

An architectural rendering of the SoCal Church of Christ building. The structure is a two-story modern building with a dark, grid-like upper facade and a lighter, more textured lower section. Large glass windows are prominent on the upper level. The address "1036" is visible on the upper left. The name "SoCal" is prominently displayed in large white letters, with "Church of Christ" in smaller text below it. A central entrance is sheltered by a white, peaked canopy supported by columns, topped with a cross. Two large vertical green walls flank the entrance. The building is set on a street with a sidewalk, where several silhouetted figures of people are walking. A white pickup truck is parked on the left, and a silver sedan is on the right. A person in a wheelchair is also visible near the car. The scene is set against a dramatic sky with clouds, and there are trees and shrubs around the building.





APPROVED
BY THE PLANNING DIVISION

SHEET TITLE

COVER SHEET


PROJECT: AC284.4

ORIGINAL ISSUE: 11-04-2024

SHEET NUMBER:

G001

DO NOT SCALE DRAWING

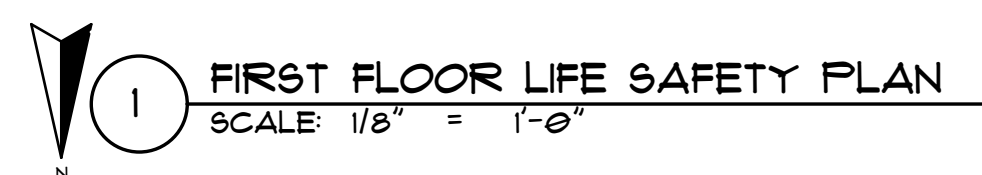

ORANGE POLICE COMMERCIAL REQUIREMENTS

THE CITY OF ORANGE MUNICIPAL CODE SECTION 15.52 REQUIRES THAT ALL BUILDING WITHIN THE CITY MEET SPECIFIC SECURITY STANDARDS (ORDINANCE # 6-22) THE FOLLOWING ITEMS SHALL BE REQUIRED ON ANY NEW OR REMODELED COMMERCIAL BUILDING/TENANT SPACE.

STRIKE PLATE - 16 GAUGE SCREWS- 3" IN WOOD FRAMED JAMBS ALUMINUM JAMB REINFORCED NON-REMOVABLE HINGE PINS (NRP) ON OUT SWINGING DOORS OPERABLE WINDOWS/GLIDING DOORS SHALL HAVE PASSED C.M.B.S.O. FORCE ENTRY TEST EXTERIOR DOOR HARDWARE SHALL BE OF STEEL OR SOLID CORE WOOD EXTERIOR DOOR HARDWARE SHALL COME FROM CURRENT CITY OF ORANGE APPROVED PRODUCTS LIST ONE MOTION LEVER HARDWARE, DEADBOLT FUNCTION REQUIRED ON ALL EXTERIOR DOORS (UNLESS PANIC REQUIRED) SOLID STEEL CYLINDER GUARD/APPROVED ESCUTCHEON REQUIRED EXTERIOR PAIR OF DOORS REQUIRE AUTOMATIC 5/8" METAL BOLT AT HEAD & THRESHOLD DOUBLE DOORS WITH PANIC HARDWARE REQUIRE FULL LENGTH ASTRAGAL APPROVED BY THE POLICE DEPARTMENT OFFICE SUITE DOORS IN MULTI-OCCUPANCY/TENANT BUILDING TO BE SECURED AS EXTERIOR DOORS (E.-DEADBOLT) SKYLIGHTS SHALL BE PROTECTED BY RATED BURGLARY/IMPACT GLAZING, OR APPROVED BURGLAR BARS HVAC OR AIR DUCTIVEN REQUIRE BURGLAR BARS/SCREEN ON ANY OPENING EXCEEDING 36 SQUARE INCHES

(IRON BARS AT LEAST 1/2 IN ROUND OR 1 IN FLAT STEEL MATERIAL SPACED NO MORE THAN 5 INCHES APART & SECURELY FASTENED)



BUILDING ADDRESS NUMBERS SHALL BE ILLUMINATED, CONTRAST AND BETWEEN 8 AND 12 INCHES IN HEIGHT LIGHTING AT EXTERIOR DOORWAYS SHALL BE MAINTAINED MINIMUM 1 FC. AT GROUND WITH VANDAL PROOF LENSES

LIGHTING ON PARKING & ACCESS AREAS SHALL BE MAINTAINED MINIMUM 1 FC. AT GROUND WITH VANDAL PROOF LENSES

ANY EXTERIOR CHANGES TO EXISTING BUILDING T.I.'S MUST MEET SECURITY ORDINANCE REQUIREMENTS

CRIME PREVENTION BUREAU

(114)-744-1327 OR (114) 744-1555

SIGNAGE LEGEND	
SYMBOL	DESCRIPTION
	ILLUMINATED VISUAL "EXIT" SIGN
	FIRE EXTINGUISHER CABINET, T.O. EXTINGUISHER IS LESS THAN 60' A.F.F.

(F.E.C.) FIRE EXTINGUISHER SCHEDULE SUMMARY			
ROOM #	LOCATION	POTTER ROEMER CABINET MODEL #	RATING
103	CORRIDOR	1023-A	2-A
213	KITCHEN AREA	1023-A	2-A

* FIRE EXTINGUISHER CABINET LOCATION PROVIDING MAX. 15' TRAVEL DISTANCE

PLUMBING FIXTURE CALCULATIONS - A-3 OCCUPANCY; PER 2022 CBC CH. 4 TABLES 422.1							
TOTAL 571 OCC.	WATER CLOSETS		URINALS	LAVATORIES		D.F.	OTHER
	MALE	FEM.	MALE	MALE	FEM.		
TOTAL REQ'D	3 (201-400)	6 (401-600)	3 (201-400)	2 (201-400)	4 (201-300)	3 (51-500)	1 SERV. SINK
TOTAL PROVIDED	4	7	3	6	6	4	1


- ### LIFE SAFETY PLAN KEYED NOTES:
- 1) ADA REQUIRED MANEUVERING CLEARANCE
 - 2) 61" FLOOR TURNING RADIUS
 - 3) 36"x52" CLEAR FLOOR SPACE
 - 4) 36"x60" CLEAR FLOOR SPACE
 - 5) PLAY FENCING, BY OWNER
 - 6) FIXED FEW CHAIR SEATING
 - 7) SAFETY GLAZING REQUIRED

PARKING REQUIREMENTS: PER TABLE 11.34.066.0: 1 PARKING SPACE REQUIRED PER 3 FIXED SEATS IN RELIGIOUS ASSEMBLY SPACES.	
213 ASSEMBLY FIXED SEATS = 71 PARKING STALLS REQUIRED	
ALLOTTED PARKING SPACES	ON SITE ACCESSIBLE SPACES
31	2
TOTAL ON SITE PARKING = 33 SPACES	
6 EXISTING PARKING SPACES HAVE BEEN REMOVED	
38 REMAINING PARKING SPACES TO BE PROVIDED ON ADJACENT PROPERTIES THROUGH OFF-SITE SHARED PARKING AGREEMENTS	

PROJECT SUMMARY	
THIS PROJECT CONSISTS OF THE RENOVATION AND CHANGE OF USE OF THE EXISTING OFFICE SPACE BUILDING TO RELIGIOUS ASSEMBLY USE. THE EXISTING FACILITY CONSISTS OF 9,863 SF OF FIRST FLOOR SPACE AND 6,981 SF OF SECOND FLOOR SPACE. THE FIRST FLOOR WILL BE RENOVATED TO PROVIDE A SANCTUARY WITH THE CAPACITY FOR 213 FIXED SEATS. ACCESSORY TO THIS RELIGIOUS ASSEMBLY SPACE WILL BE THE ADDITION OF ACCESSORY CLASSROOM SPACES. THE SECOND FLOOR WILL BE RENOVATED TO PROVIDE ADDITIONAL ACCESSORY MEETING AND CLASSROOM SPACE. TO PROVIDE ACCESSIBILITY TO THE SECOND FLOOR ACCESSORY SPACES AN ELEVATOR ADDITION IS PROPOSED ADDING AN ADDITIONAL 668 SF TO THE BUILDING, 461 SF ON THE FIRST FLOOR AND 207 SF ON THE SECOND FLOOR.	
ZONING & LAND-USE INFO	
ZONE DISTRICT	INDUSTRIAL MANUFACTURING DISTRICT (M-2)
LAND USE DESIGNATION	INDUSTRIAL (I)
BUILDING COMPONENTS	
BUILDING AREA	TOTAL: 13,518 SF
1ST FLOOR AREA	6,324 SF
2ND FLOOR AREA	11,154 SF
CONSTRUCTION TYPE	V-B
AUTOMATIC SPRINKLER SYSTEM	YES
FIRE ALARM SYSTEM	YES
OCCUPANCY CLASSIFICATION	A-3
ALLOWABLE NUMBER OF STORIES	1
ALLOWABLE NUMBER OF STORIES WITH SPRINKLER SYSTEM	2
NUMBER OF EXISTING STORIES	2
ALLOWABLE HEIGHT	40'
EXISTING HEIGHT	± 31'
ALLOWABLE AREA WITH FRONTAGE INCREASE	10,500 SF / FLOOR
SEE STRUCTURAL DESIGN COVER SHEET FOR STRUCTURAL CRITERIA	

ARCHITECTURAL SITE PLAN KEYED NOTES:

- ① NEW CONCRETE PAVING
② NEW MECHANICAL UNIT, REF. MECHANICAL
③ NEW BOLLARDS, 4"-6" Ø CONCRETE BOLLARDS,
60" HIGH, PAINTED SAFETY YELLOW
④ NEW 24" BOX RED CRAFT HYDRILE TREE

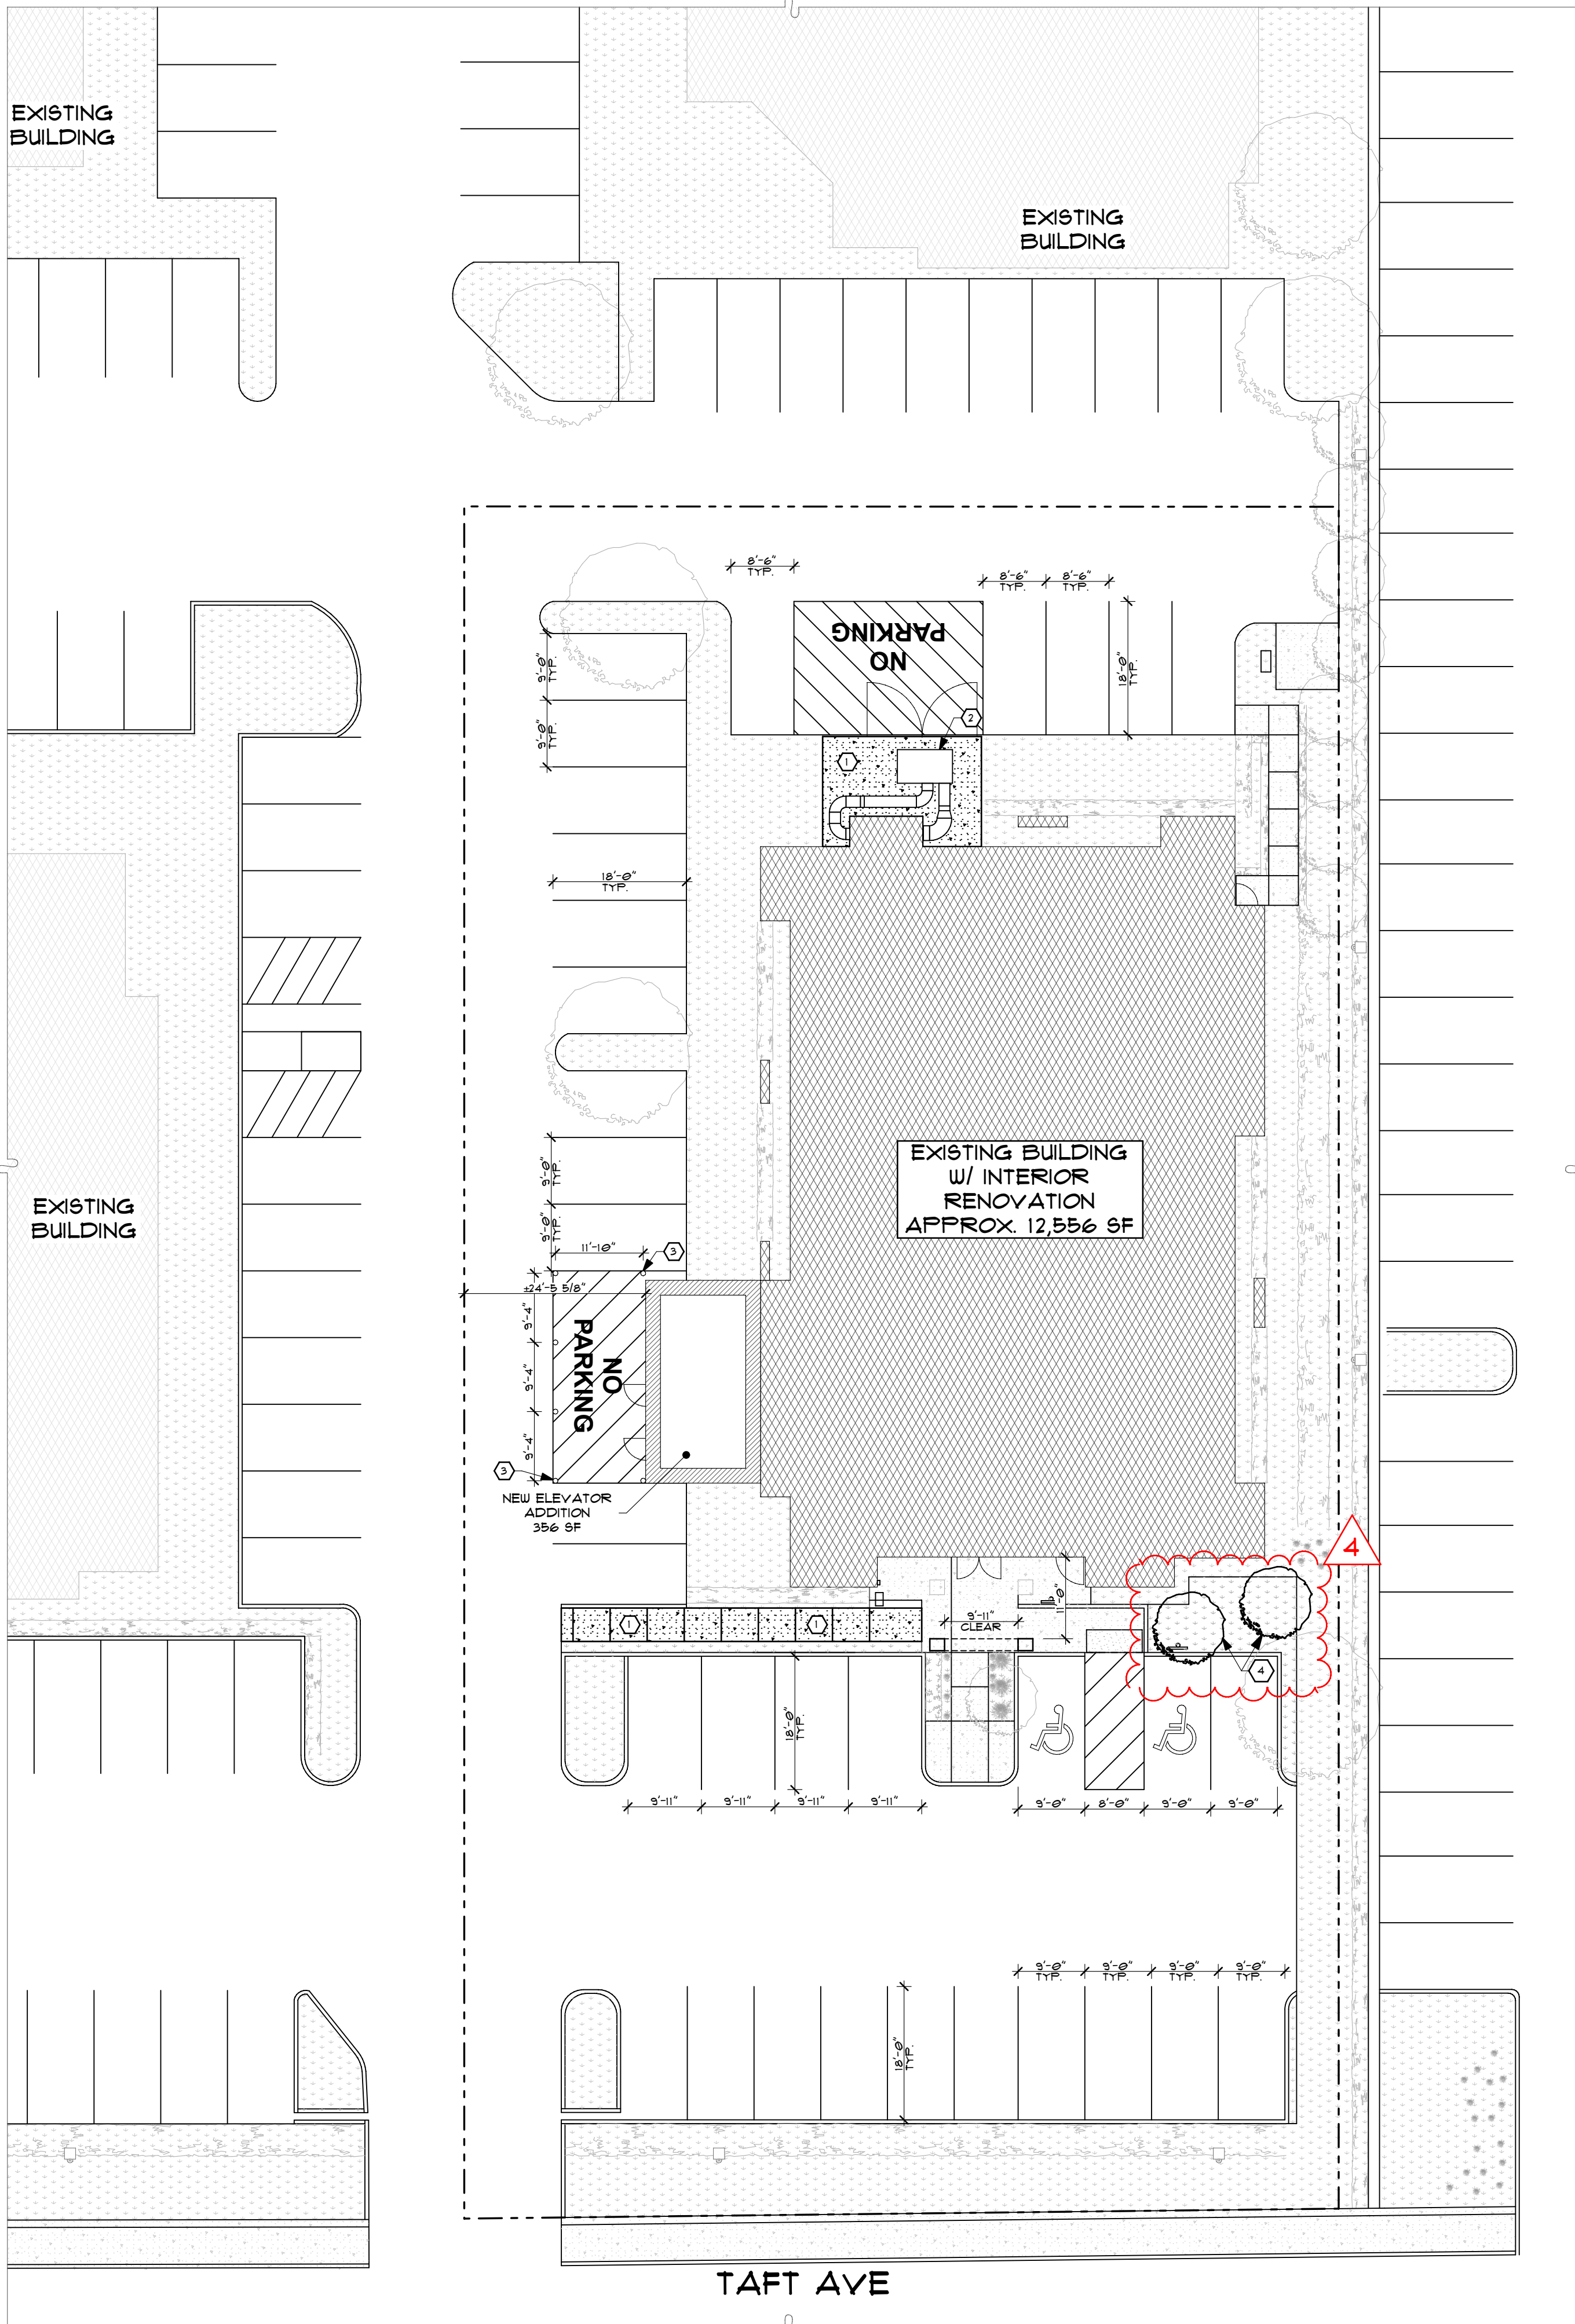

1 ARCHITECTURAL SITE PLAN
SCALE: 1/8" = 1'-0"

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PROJECT: **SOCAL CHURCH OF CHRIST
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REV. DATE DESCRIPTION
0 11-06-2024 ORIGINAL ISSUE
1 3-05-2025 PLANNING REVIEW
2 4-18-2025 PLANNING REVIEW
3 9-09-2025 PLANNING REVIEW
4 9-19-2025 PLANNING REVIEW

SEAL: **EDWARD WRIGHT**
REGISTERED ARCHITECT
STATE OF CALIFORNIA
515/2025
RENEWAL DATE


SHEET TITLE: **ARCHITECTURAL
SITE PLAN**
PROJECT#: 42524 ORIGINAL ISSUE: 11-06-2024

SHEET NUMBER: **G104**

DO NOT SCALE DRAWING

EXISTING SITE PLAN KEYED NOTES:

- 1 EXISTING TREE, TYP.
- 2 EXISTING GREENSCAPE
- 3 EXISTING SHRUBBERY
- 4 EXISTING SITE LIGHT
- 5 EXISTING MAILBOX
- 6 EXISTING COLUMN
- 7 ASSUMED PROPERTY LINE
- 8 EXISTING ELECTRICAL BOX
- 9 EXISTING TRASH ENCLOSURE
- 10 EXISTING PAVING
- 11 EXISTING TREE TO BE REMOVED AND REPLACED

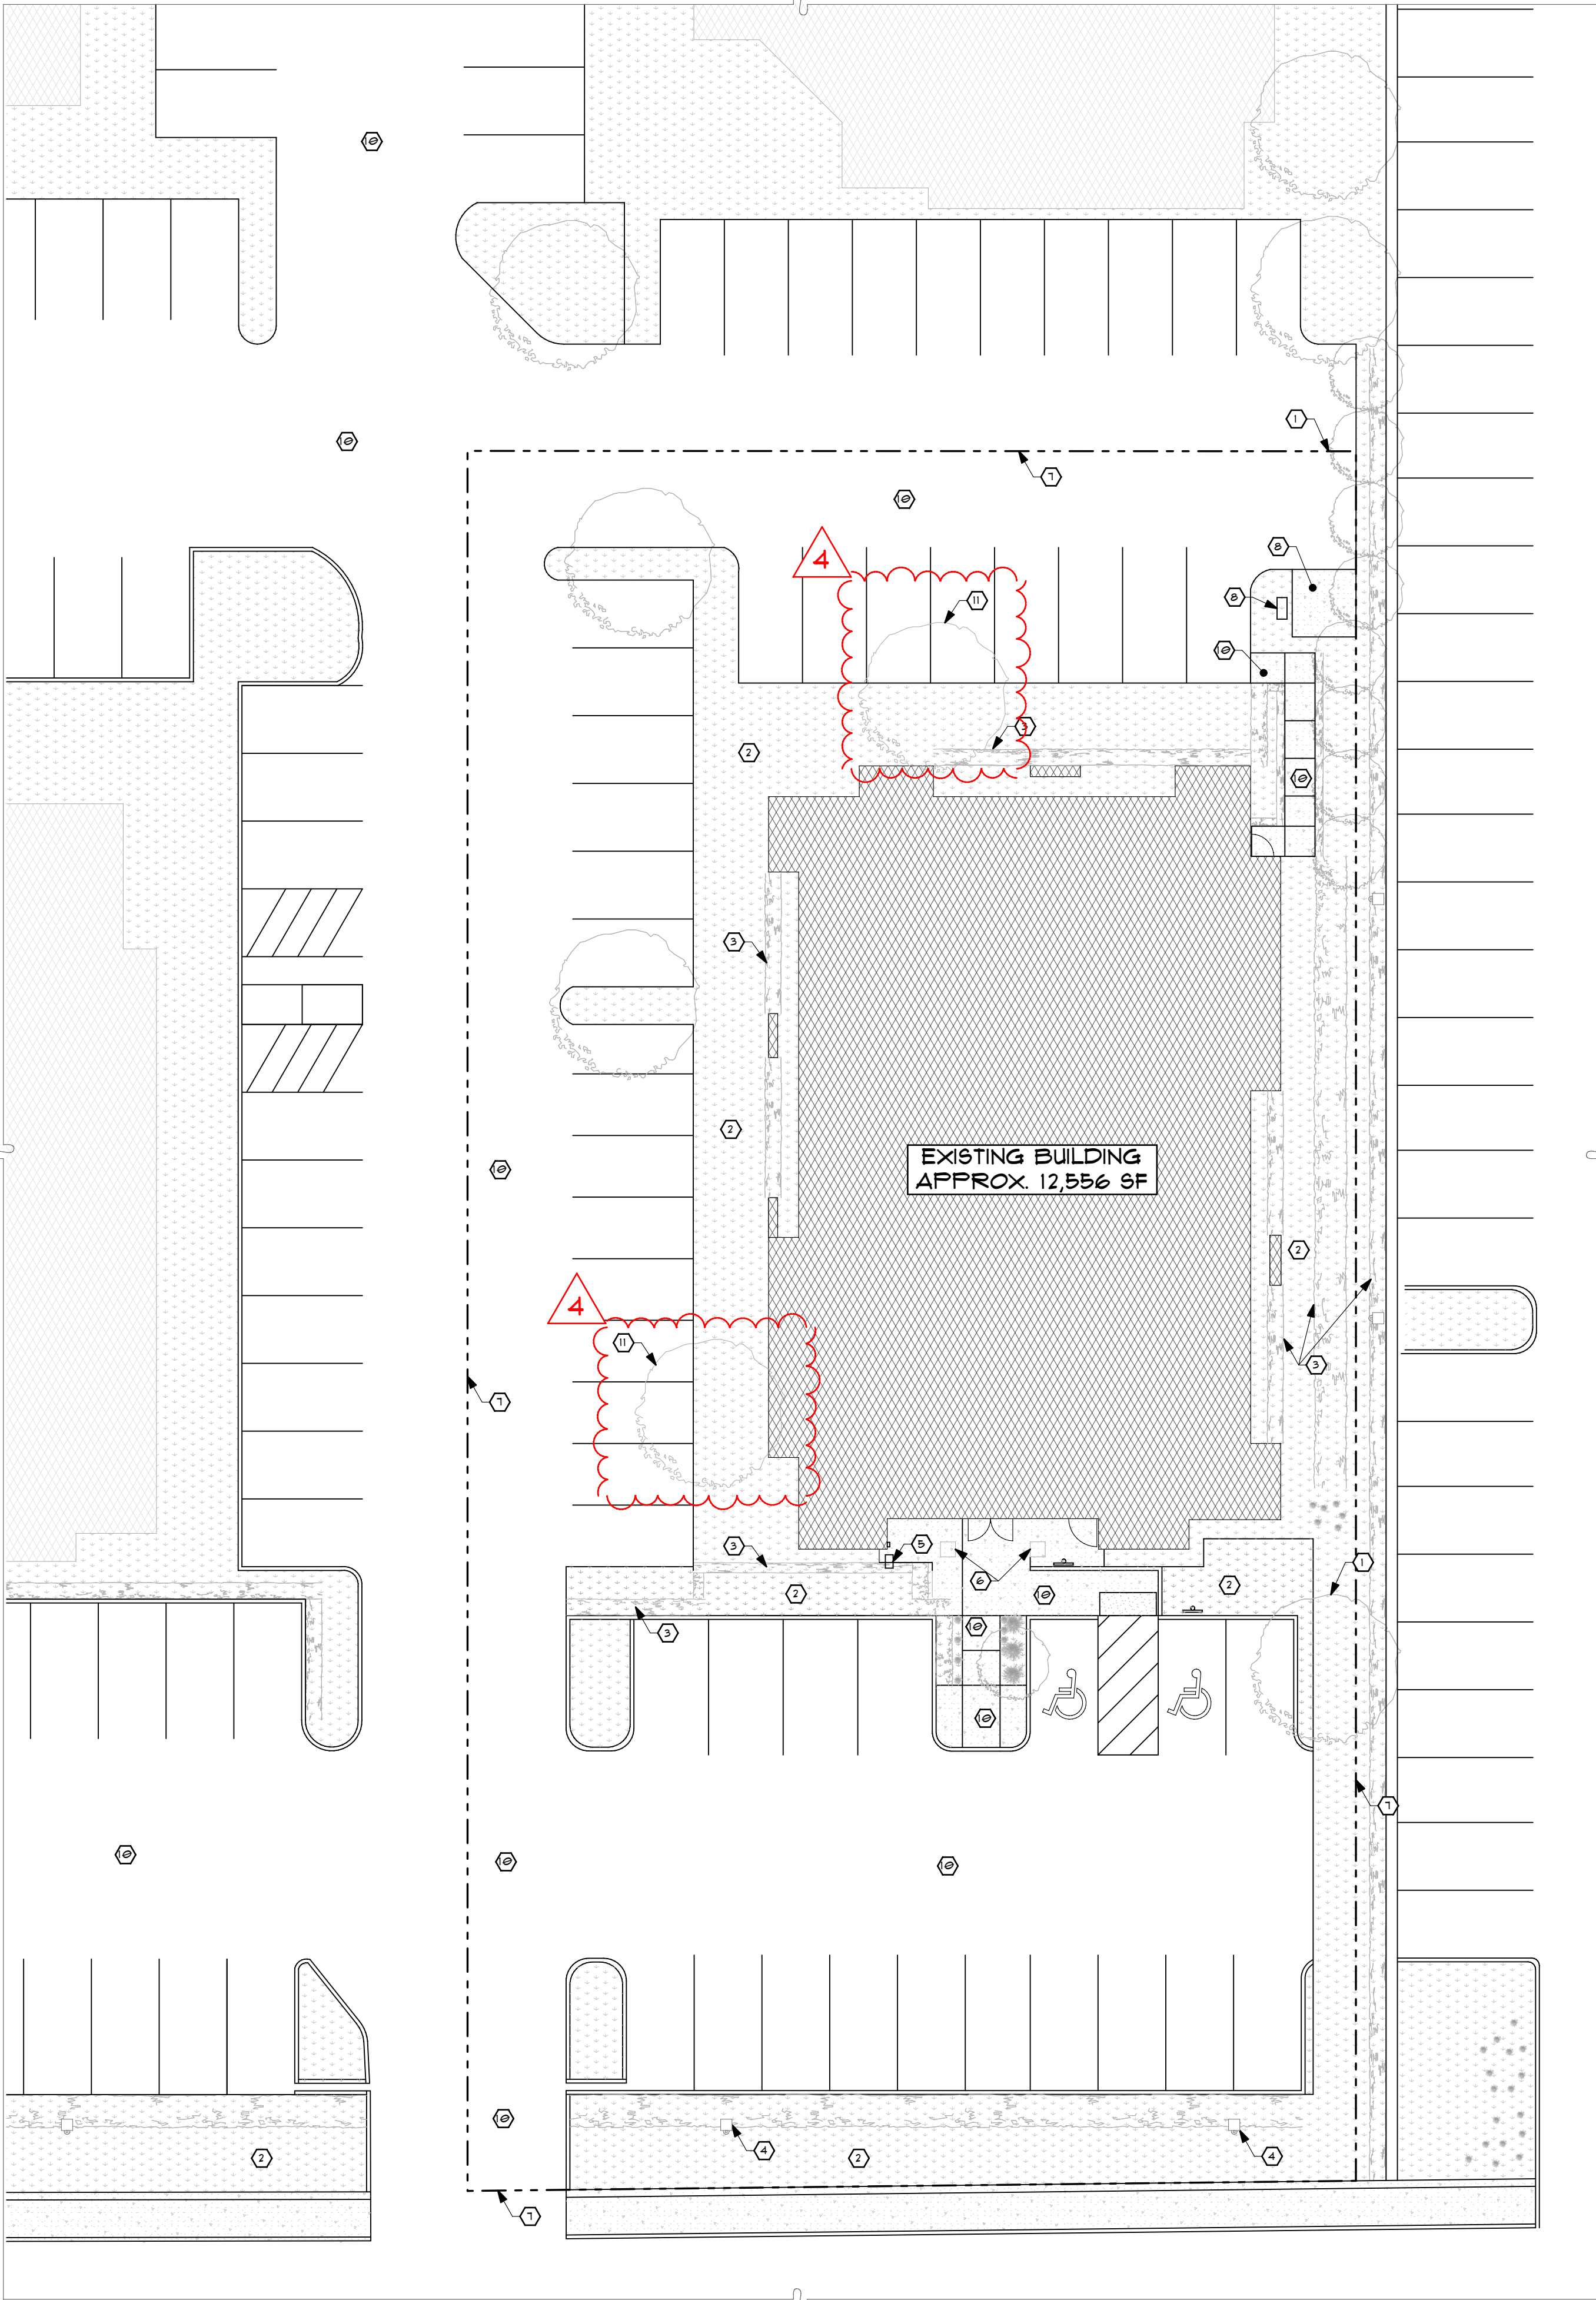

1 EXISTING SITE PLAN
SCALE: 1"=100'

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4 9-18-2025 PLANNING REVIEW


SEAL:

SHEET TITLE: **EXISTING SITE
PLAN**

SHEET NUMBER: **G105**

DO NOT SCALE DRAWING

PROJECT#: 2024 ORIGINAL ISSUE: 11-06-2024

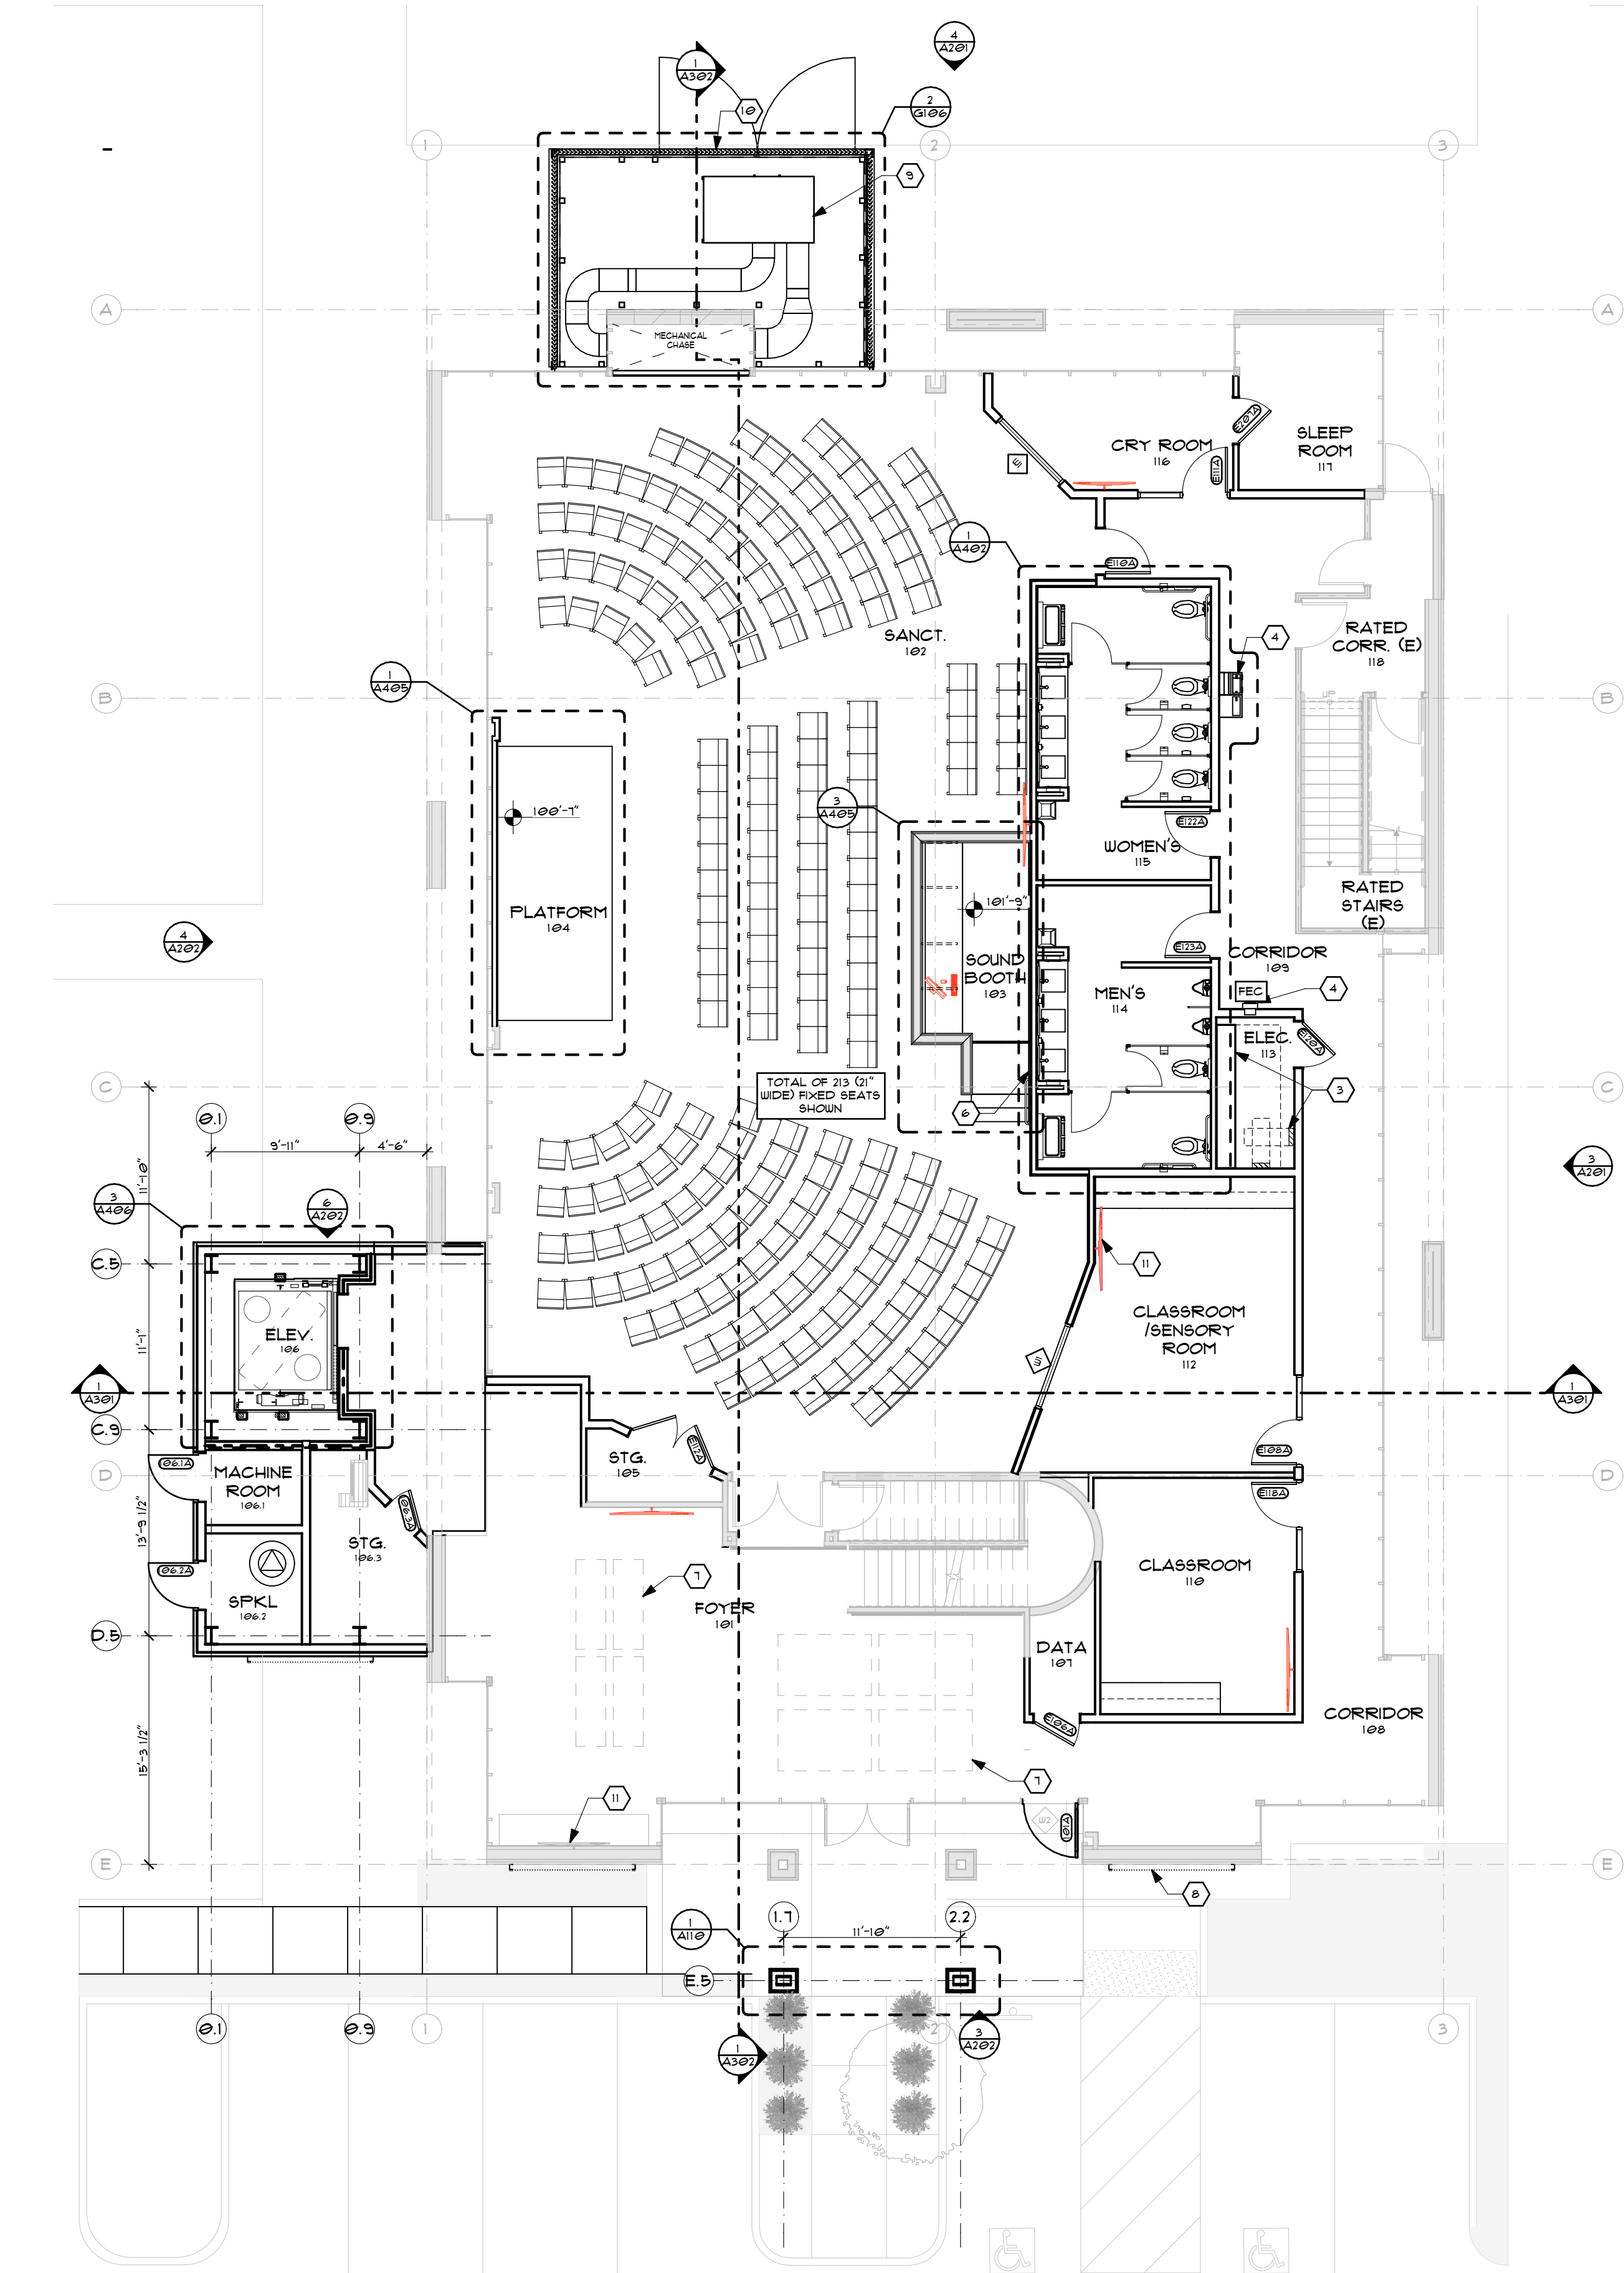

1 FIRST FLOOR PLAN
SCALE: 1/8" = 1'-0"

FLOOR PLAN GENERAL NOTES

- DIMENSIONS AND WALL TYPES**
 - SEE FRAMING PLAN FOR ALL FRAMING DIMENSIONS AND WALL TYPES.
- GYPSUM DRYWALL**
 - CORRIDOR GYPSUM PANELS. PROVIDE 5/8" IMPACT RESISTANT TYPE "X" GYPSUM WALLBOARD COMPLYING WITH ASTM C1625 (USG "MOLD TOUGH VHT" OR EQUAL) TO 4'-0" A.F.F. AT ALL CORRIDOR/HALLWAY LOCATIONS.
 - RESTROOM GYPSUM PANELS. PROVIDE 5/8" MOISTURE AND MOLD RESISTANT TYPE "X" GYPSUM WALL BOARD COMPLYING WITH ASTM C1396 AT ALL RESTROOM, KITCHEN AND UET ROOM APPLICATIONS (USG SHEETROCK "MOLD TOUGH FIRECODE X" OR EQUAL).
 - TILE BACKER. PROVIDE 5/8" GLASS-MAT TILE BACKER BOARD AT ALL TILE APPLICATIONS COMPLYING WITH ASTM D3713. (USG DUROCK OR EQUAL).
 - SEE WALL TYPES SHEET FOR ALL CONTROL JOINT DETAILS. HORIZONTAL AND VERTICAL CONTROL JOINTS WILL BE REQ'D.
- SOUND INSULATION**. ALL INTERIOR WALLS, EXCEPT STORAGE AREAS, SHALL BE SOUND INSULATED. 3-1/2" AND 4" FRAMED WALLS TO HAVE R-11 AND 4" FRAMED WALLS TO HAVE R-13, UNFACED BATT INSULATION.
- FIRE EXTINGUISHERS**. FIRE EXTINGUISHERS SHALL BE INSTALLED IN 80" RECESSED CABINETS.
- INTERIOR SIGNAGE**. SEE SIGNAGE PLAN AND CODE REVIEW SHEET FOR REQUIRED SIGNAGE.

FLOOR PLAN KEYED NOTES:

- ACCESSIBLE W/LD DRINKING FOUNTAIN W/ BOTTLE FILLER. REF. PLUMBING.
- CASEWORK, REF. LARGE PLAN/INTERIOR ELEVATIONS.
- ELECTRICAL PANEL/EQUIPMENT, REF. ELECTRICAL.
- FIRE EXTINGUISHER CABINET, REF. FIRE EXTINGUISHER SCHEDULE.
- SOFFIT/CEILING ELEMENT ABOVE, REF. RCP.
- 1-1/2" DIA. HANDRAIL, POWDER COATED FINISH, COLOR: BLACK.
- CEILING CLOUD OR SOFFIT ABOVE.
- METAL LATTICE, SEE EXTERIOR ELEVATIONS.
- MECHANICAL EQUIPMENT, REF. MECHANICAL.
- MECHANICAL EQUIPMENT ENCLOSURE, REF. 2/G106.
- DISPLAY SCREEN.
- EXISTING TABLE TO REMAIN.

WALL LEGEND	
	EXISTING WALL
	NEW WALL FRAMING

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PROJECT

REV	DATE	DESCRIPTION
0	11-09-2024	ORIGINAL ISSUE
1	3-09-2025	PLANNING REVIEW
2	4-18-2025	PLANNING REVIEW

SEAL

EDWARD WRIGHT
REGISTERED ARCHITECT
STATE OF CALIFORNIA
04/18/2025
RENEWAL DATE


SHEET TITLE
FIRST FLOOR PLAN

SHEET NUMBER
A101

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PROJECT # A2524
ORIGINAL ISSUE 11-09-2024

1 ROOF PLAN
SCALE: 1/8" = 1'-0"

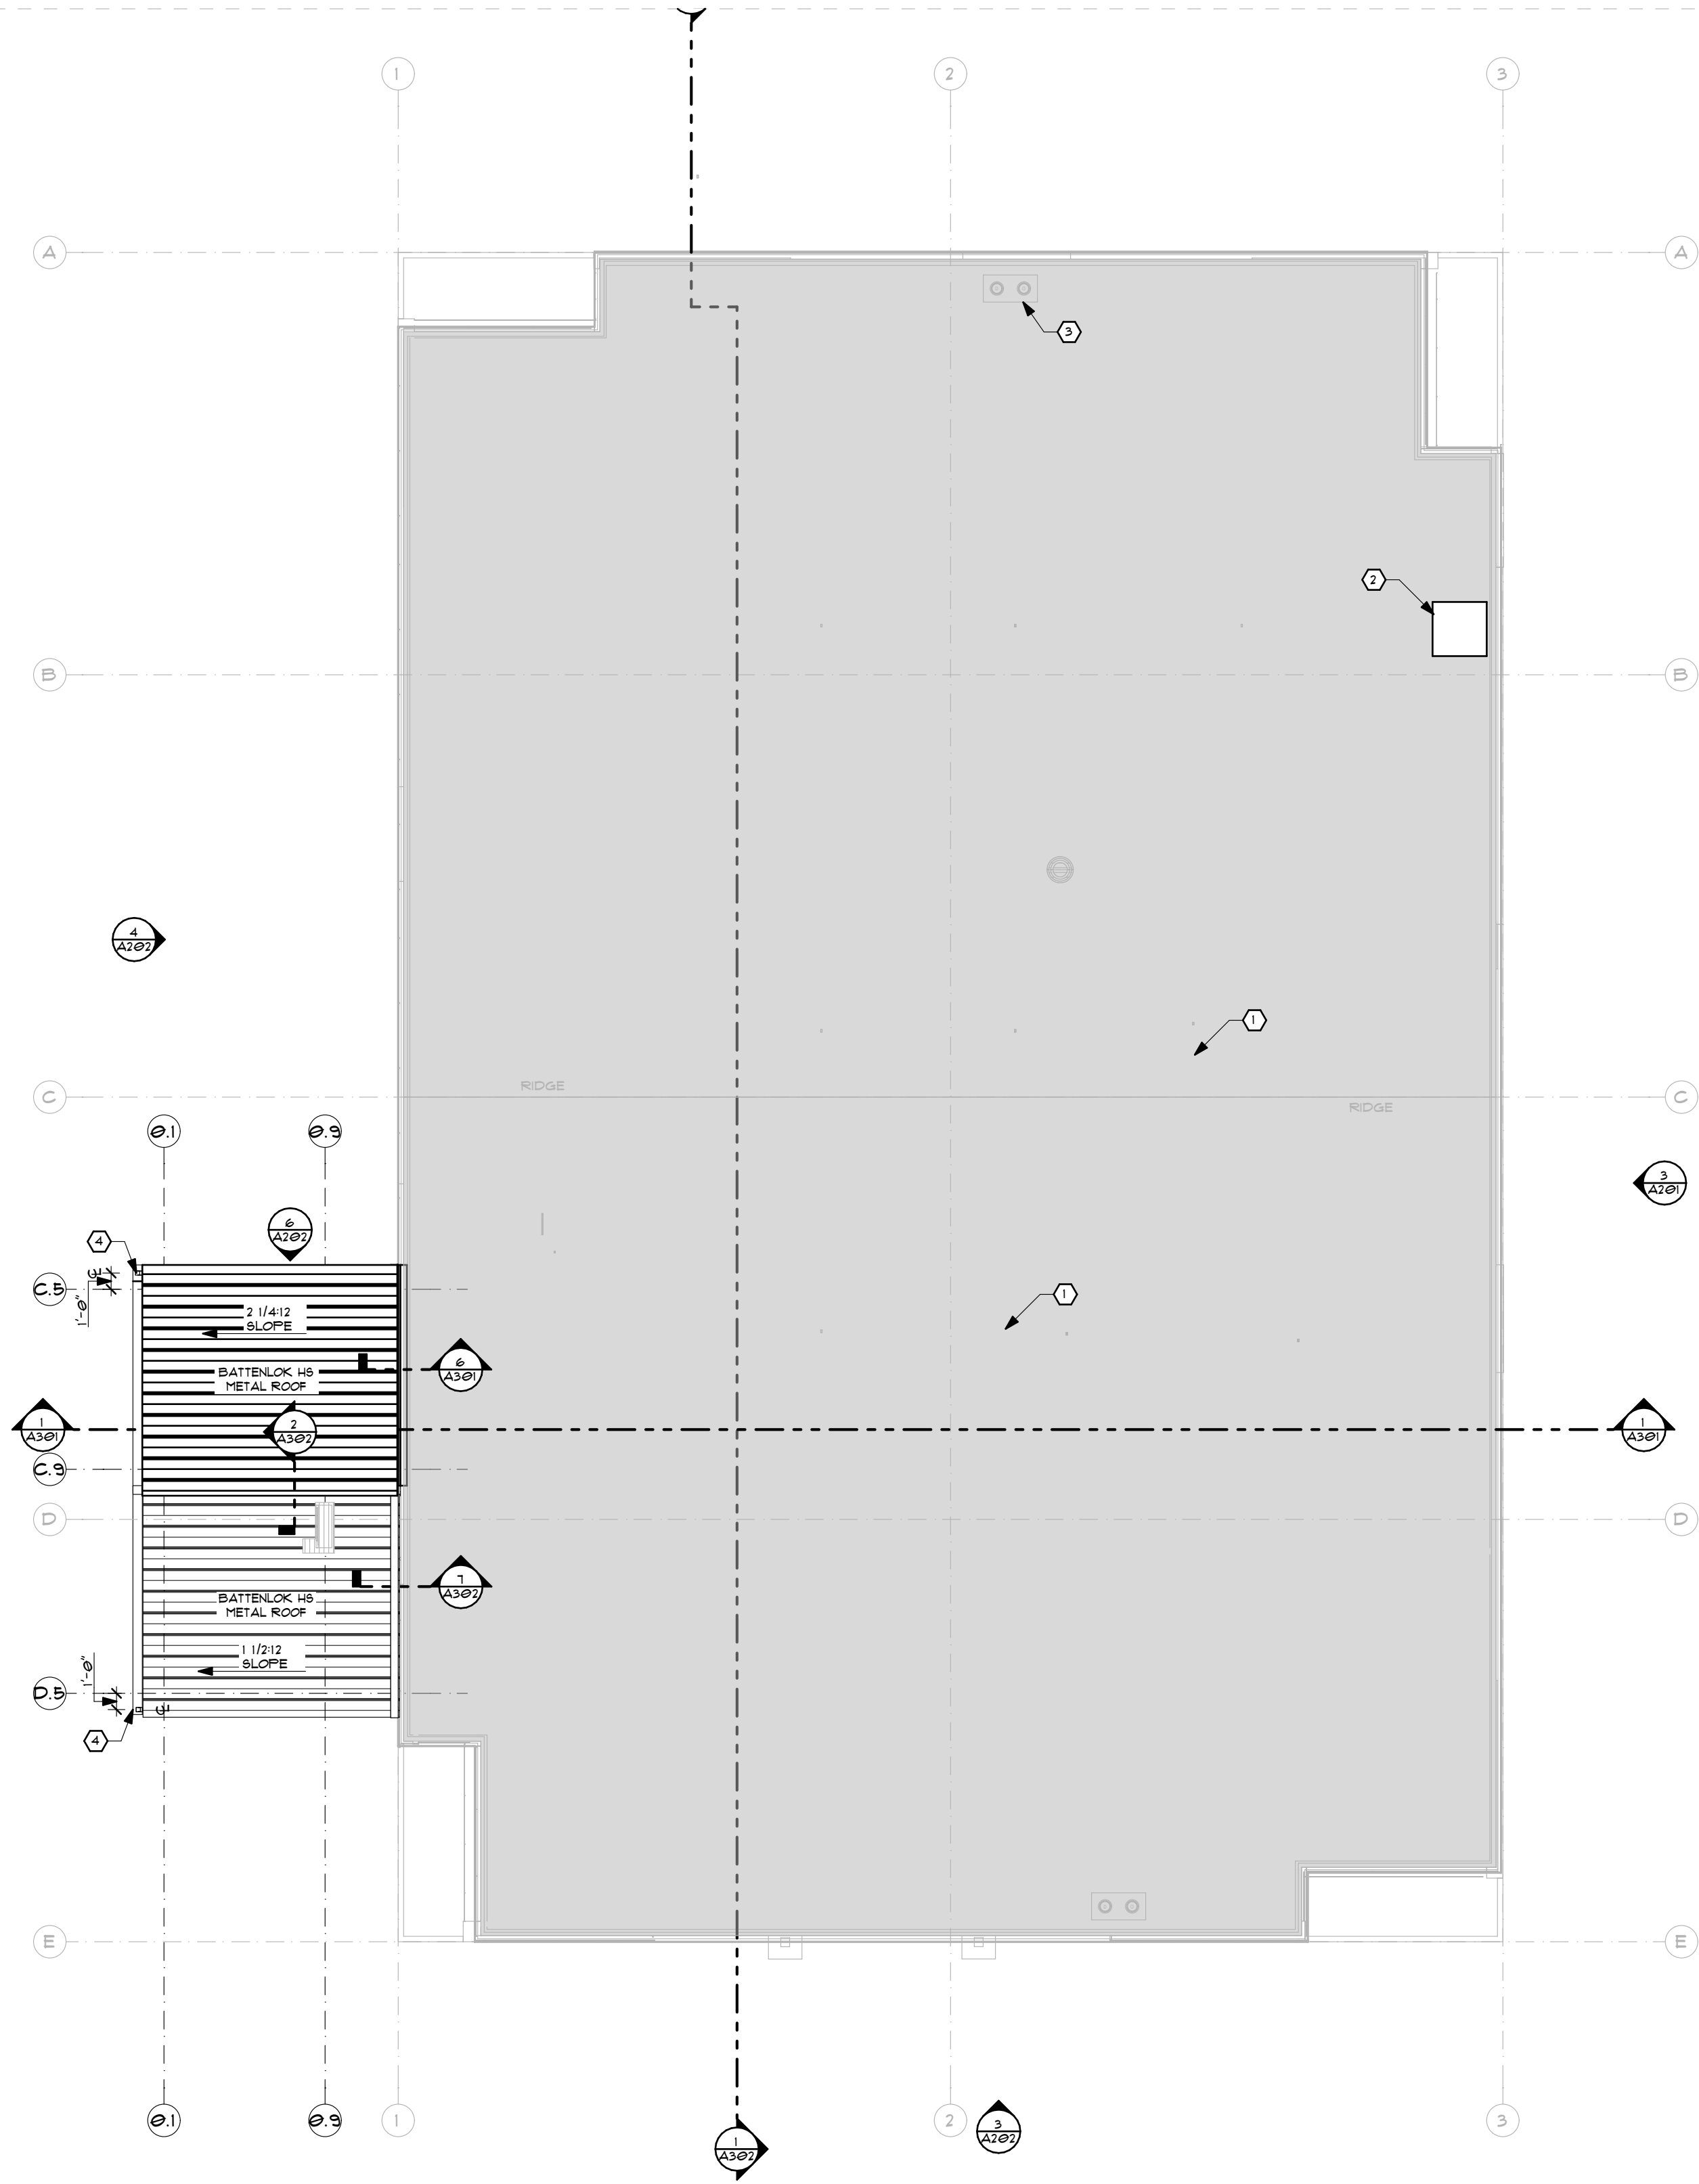

ROOF PLAN GENERAL NOTES

- STANDING SEAM ROOFING.** ALL ARCHITECTURAL STANDING SEAM ROOFING CALLED OUT ON PLAN TO BE MBCI "BATTENLOK" OR EQUAL ARCHITECTURAL STANDING SEAM METAL ROOF. ALL ROOF TRIMS, DOWNSPOUTS AND GUTTERS TO BE COLOR MATCHED TO ROOF.
- ROOF INSULATION (SHED ROOF / STANDING SEAM).** ALL SHED ROOF W/STANDING SEAM ROOF TO HAVE 4" POLYSTYRO INSULATION.
- VENTS THROUGH ROOF.** SEE MECHANICAL DESIGN FOR TYPICAL VENT TWO ROOF DETAILS. ROOFING CONTRACTOR TO PROVIDE OR APPROVE ALL ROOF PENETRATIONS.
- RTU SERVICE AREA ROOF PROTECTION.** PROVIDE WALK-OFF PADS AROUND ALL RTUS AND AT ALL ROOF ACCESS HATCHES. PROVIDE TREADED FULLY ADHERED PADS IN ACCORDANCE WITH ROOFING MANUFACTURER RECOMMENDATIONS. DASHED LINES AT RTUS INDICATE CLEAR SERVICE AREA REQUIREMENTS.
- RTU CLEARANCE.** MAINTAIN MIN 18" OFFSET BETWEEN ROOF VENTS AND RTUS. MECHANICAL CONTRACTOR TO COORDINATE WITH ROOFER ON ALL ROOF PENETRATIONS PRIOR TO ROOF INSTALLATION.
- CRICKETS.** ALL CRICKETS TO BE CONSTRUCTED OF TAPERED EPS INSULATION. INSTALLING CONTRACTOR TO PROVIDE SHOP DRAWING OF ALL CRICKETS FOR ARCHITECT'S REVIEW AND APPROVAL.
- CLEAR SERVICE AREA REQUIREMENTS.** DASHED LINES AT RTUS INDICATE CLEAR SERVICE AREA REQUIREMENTS.
- ROOF TRANSITIONS AT RTUS.** SINGLE PLY SHEET OVERLAP ROOF EXTENDS UP AND OVER RTU CURBS. ROOFING CONTRACTOR TO TERMINATE RTU SKIRT FLASHING TO CURB. ALLOW ADEQUATE EXCESS FOR UNIT MOVEMENT.
- GENERAL ROOF TRANSITIONS.** PROVIDE ADDITIONAL WEATHER RESISTIVE BARRIER (ICE & WATER SHIELD) TO ALL RIDGES, VALLEYS AND HPFS. EXTEND SELF ADHERED ADDITIONAL WATER BARRIER MIN 4" ON BOTH SIDES OF TRANSITION.
- ROOF BLOCKING.** ALL ABOVE ROOF BLOCKING TO BE APPROVED BY ROOFING CONTRACTOR PRIOR TO INSTALLATION.
- ROOF CLEANING.** ROOF TO REMAIN FREE AND CLEAR OF CONSTRUCTION DEBRIS DURING CONSTRUCTION. ROOF SHALL BE CLEANED OF ALL CONSTRUCTION DIRT NO LESS MORE THAN 2 MONTHS PRIOR TO CERTIFICATE OF OCCUPANCY.
- ROOF PENETRATIONS.** ALL ROOF PENETRATIONS TO BE APPROVED BY ROOFING CONTRACTOR PRIOR TO INSTALLATION.
- ROOF TO WALL FLASHING.** PROVIDE MIN 8" VERTICAL HEIGHT ROOF TO WALL FLASHING AT ALL ROOF TO WALL TRANSITIONS.
- ROOF STRUCTURE.** SEE STRUCTURAL DRAWINGS FOR ALL ROOF STRUCTURE DESIGN.

ROOF PLAN KEYED NOTES:

- 1 EXISTING ROOFTOP UNITS
- 2 EXISTING ROOF ACCESS HATCH
- 3 EXISTING INTERNAL DRAIN
- 4 6" GUTTER & 3"X 3" DOWNSPOUT


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REV	DATE	DESCRIPTION
0	11-09-2024	ORIGINAL ISSUE
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2	4-18-2025	PLANNING REVIEW

PROJECT
SOCAL CHURCH OF CHRIST
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




SHEET TITLE
ROOF PLAN AND
DETAILS

SHEET NUMBER
A109

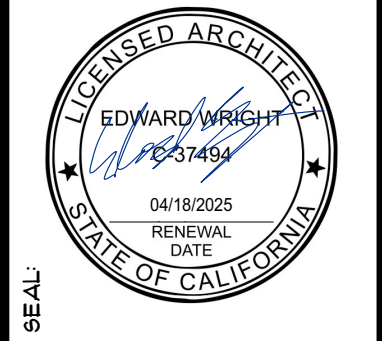
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PROJECT #2524 ORIGINAL ISSUE 11-09-2024


EXTERIOR ELEVATION LEGEND	
	EXTERIOR IMPROVEMENTS
	NO EXTERIOR IMPROVEMENTS

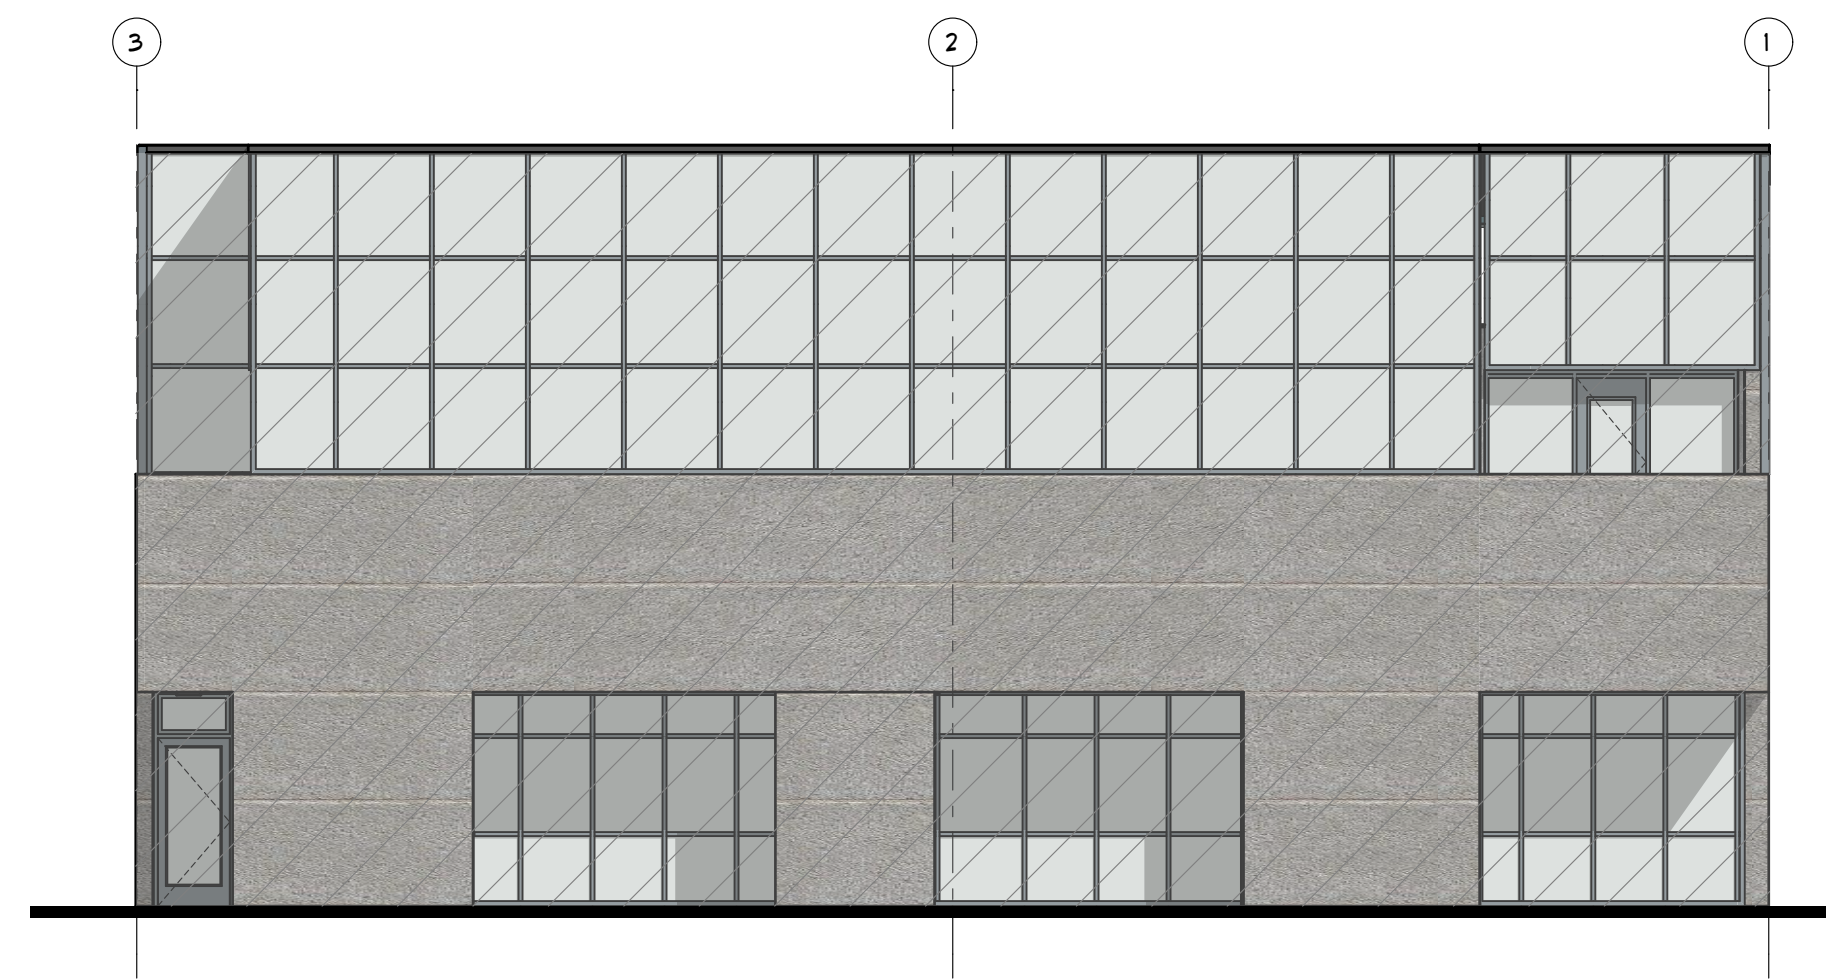


1 (EXISTING) NORTH ELEVATION
SCALE: 1/8" = 1'-0"

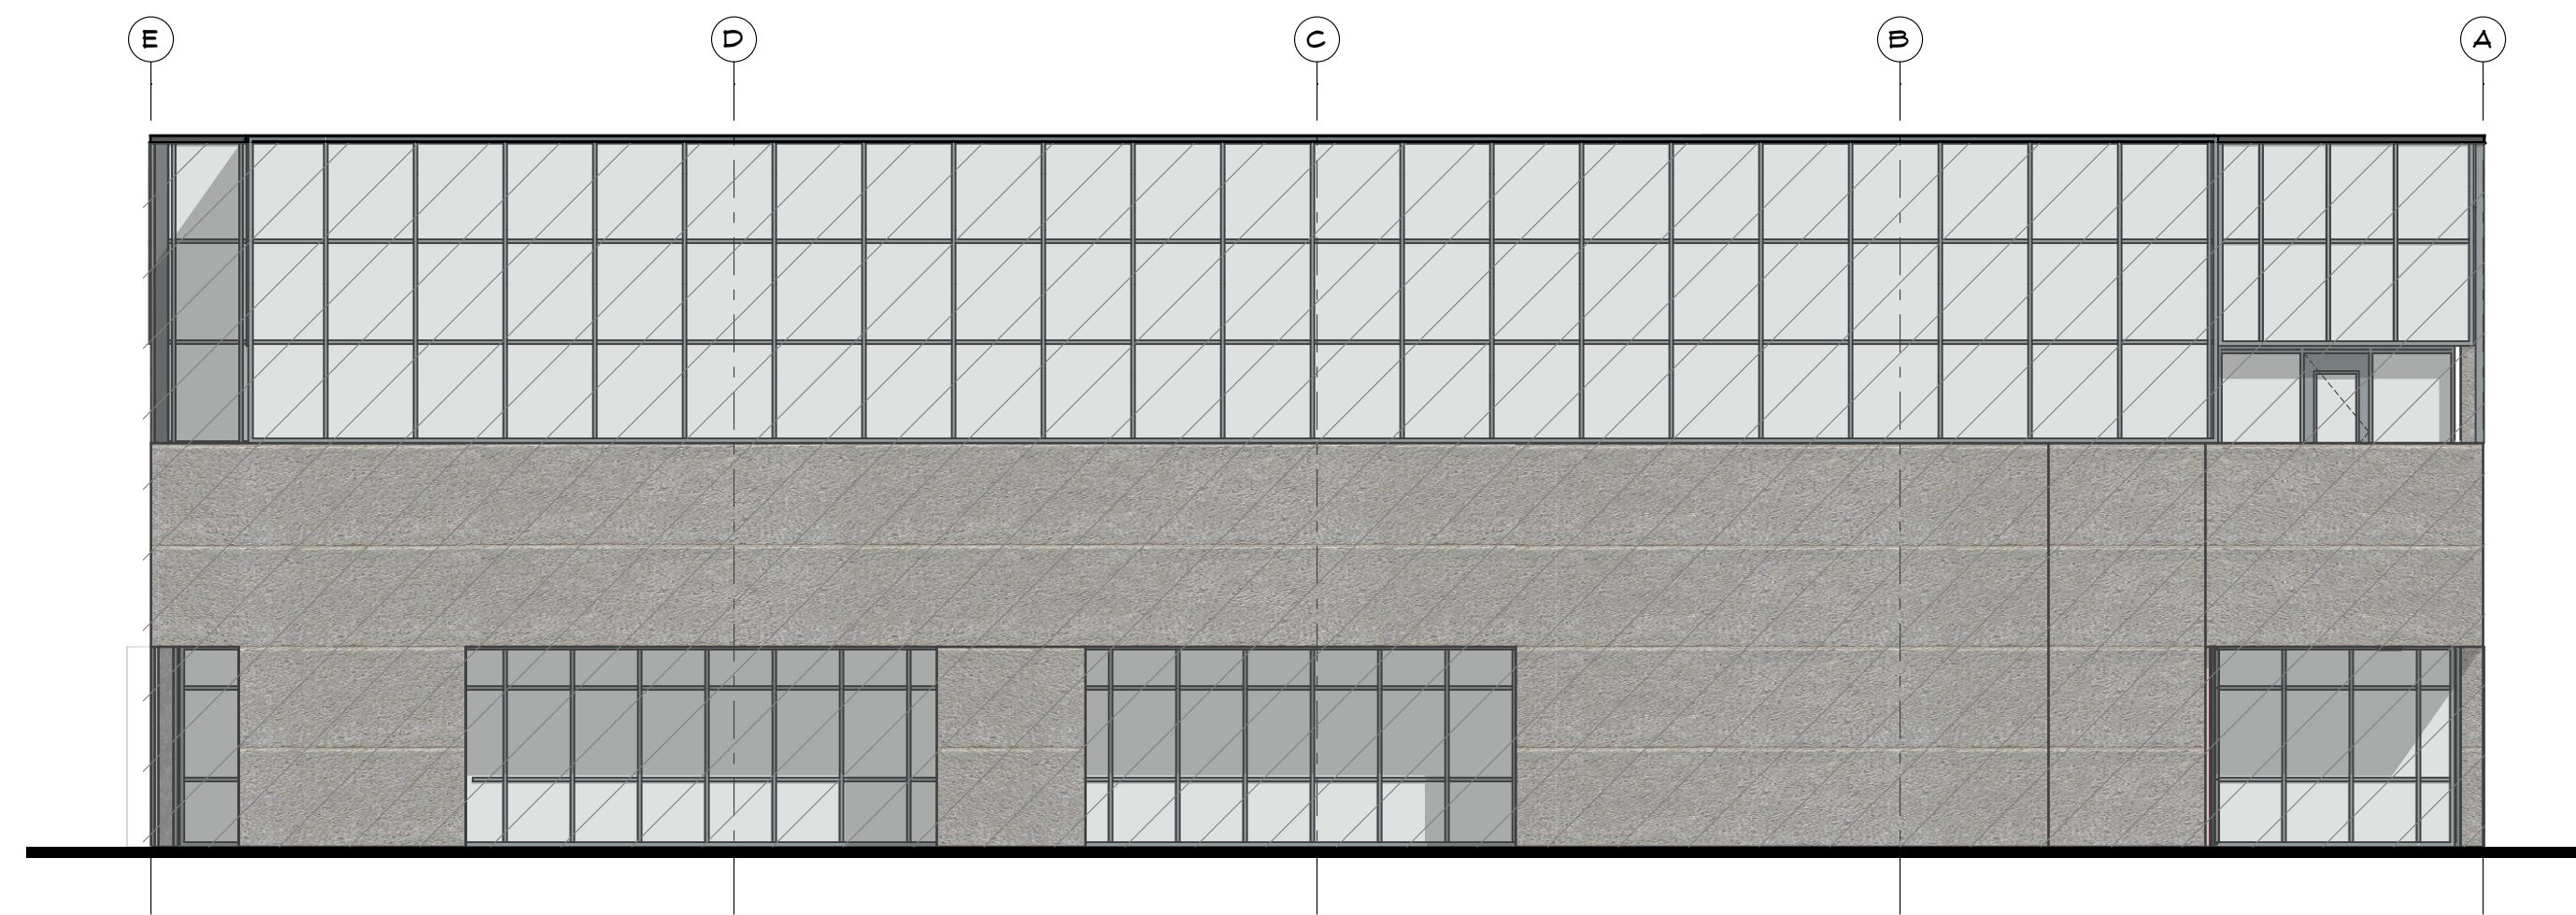


2 (EXISTING) EAST ELEVATION
SCALE: 1/8" = 1'-0"

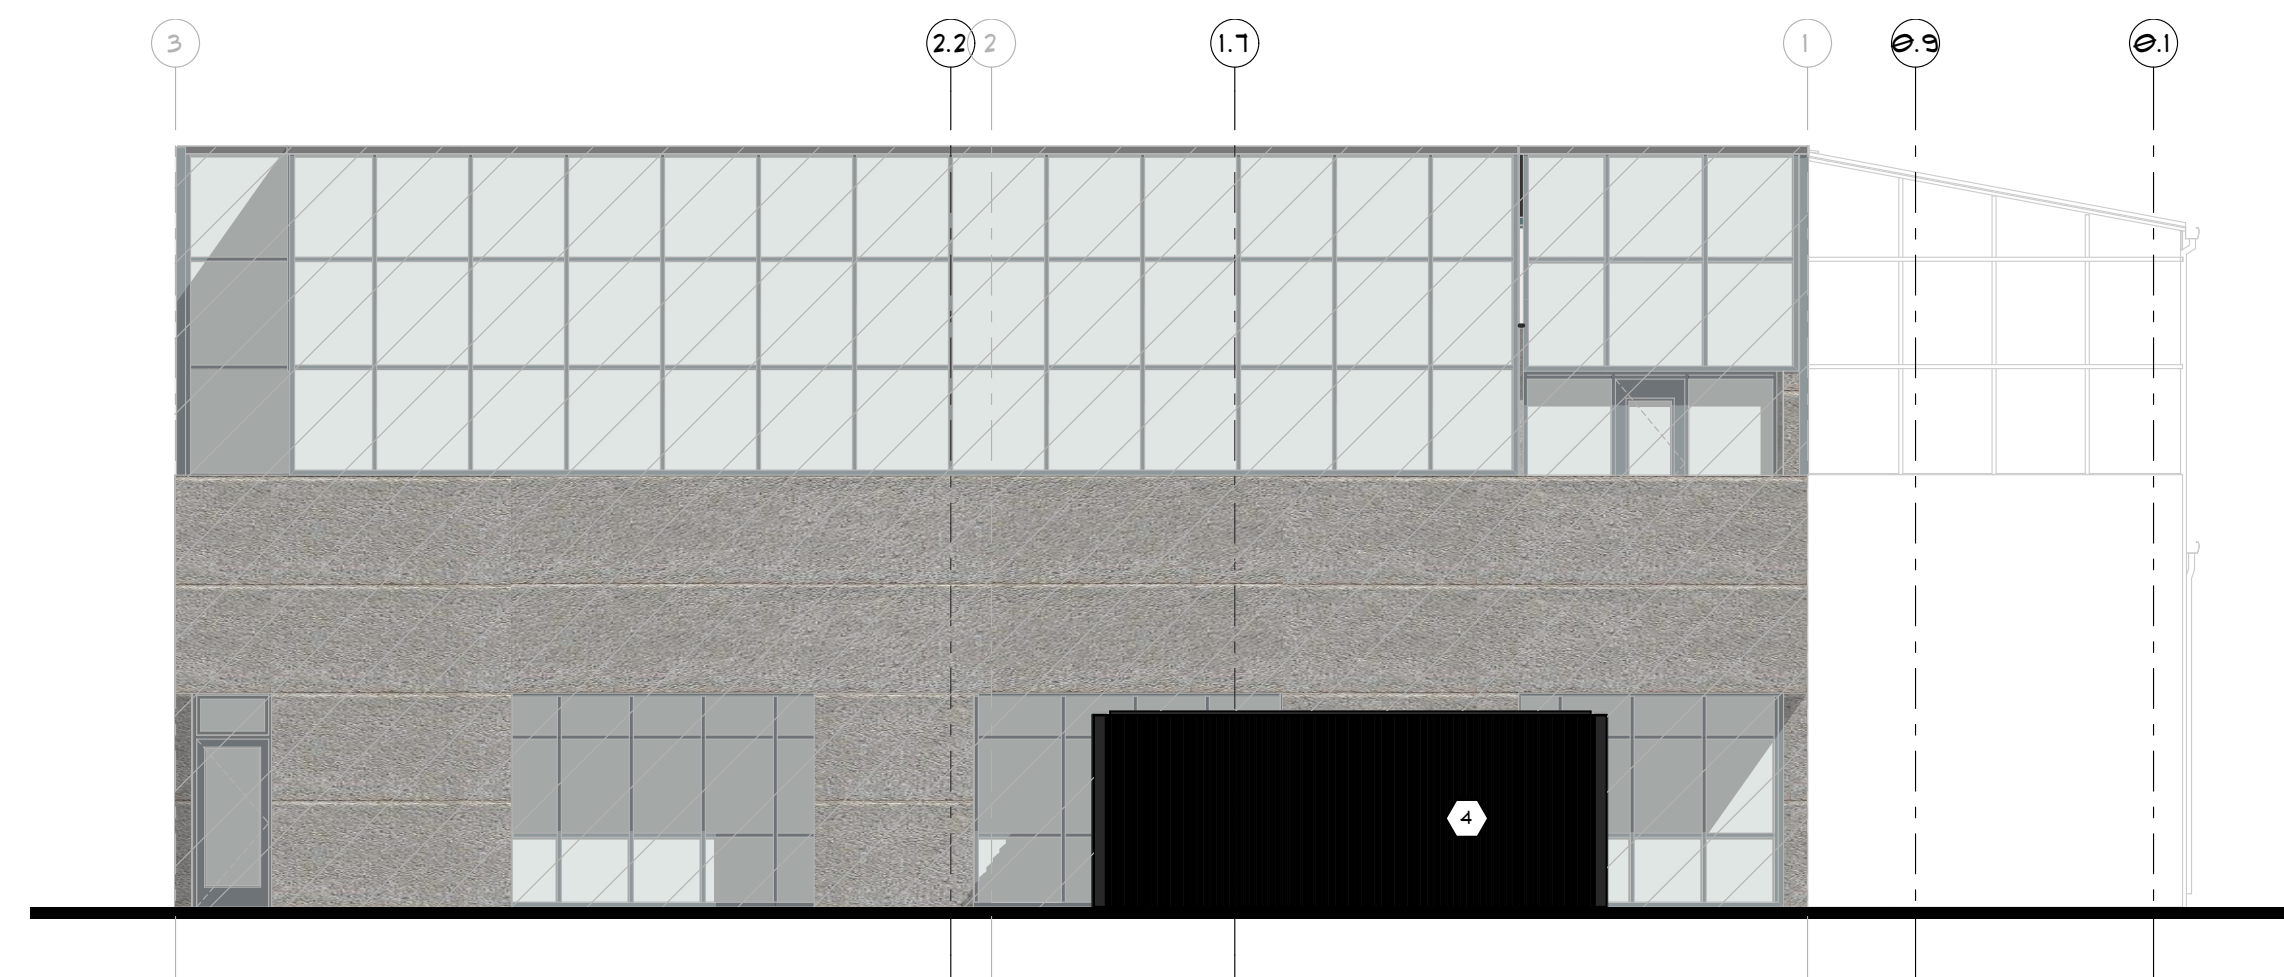


4 NORTH ELEVATION
SCALE: $1/8" = 1'-0"$

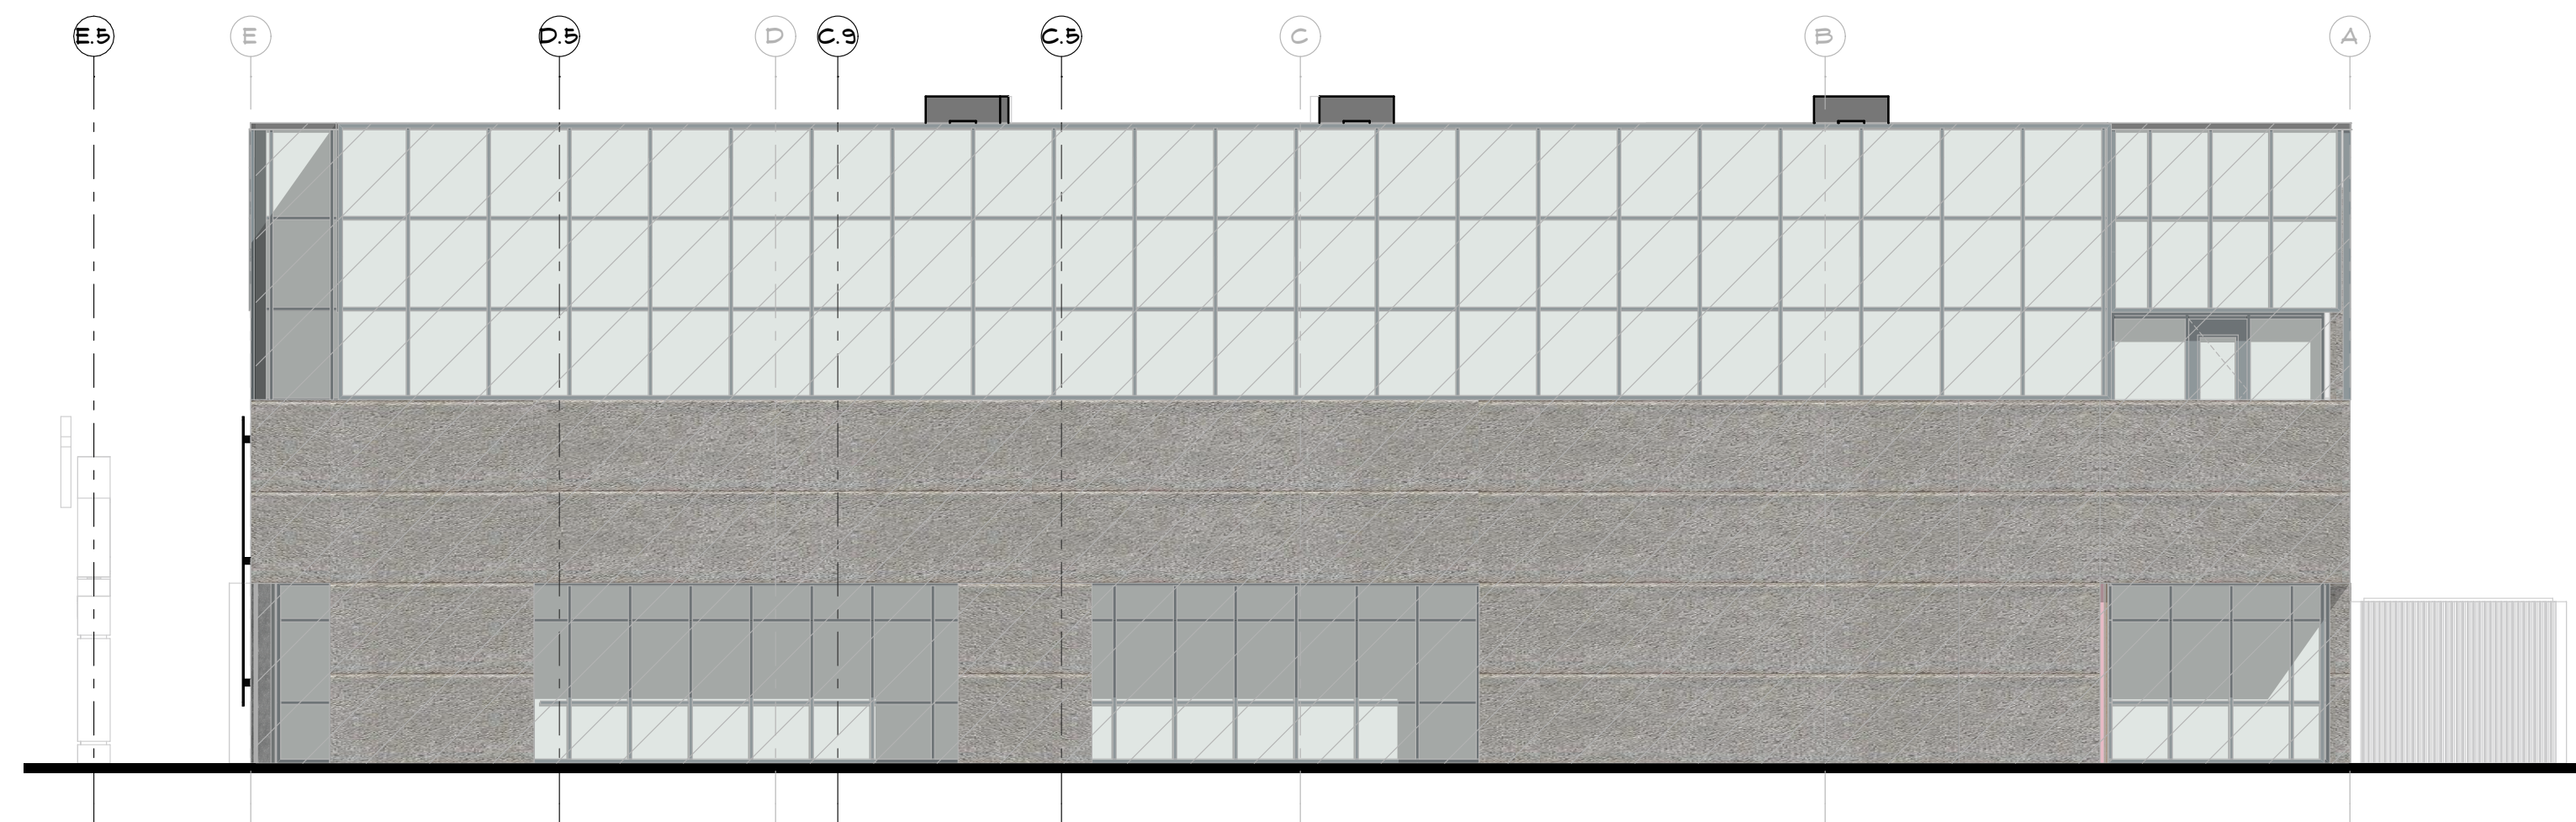


3 EAST ELEVATION
SCALE: 1/8" = 1'-0"

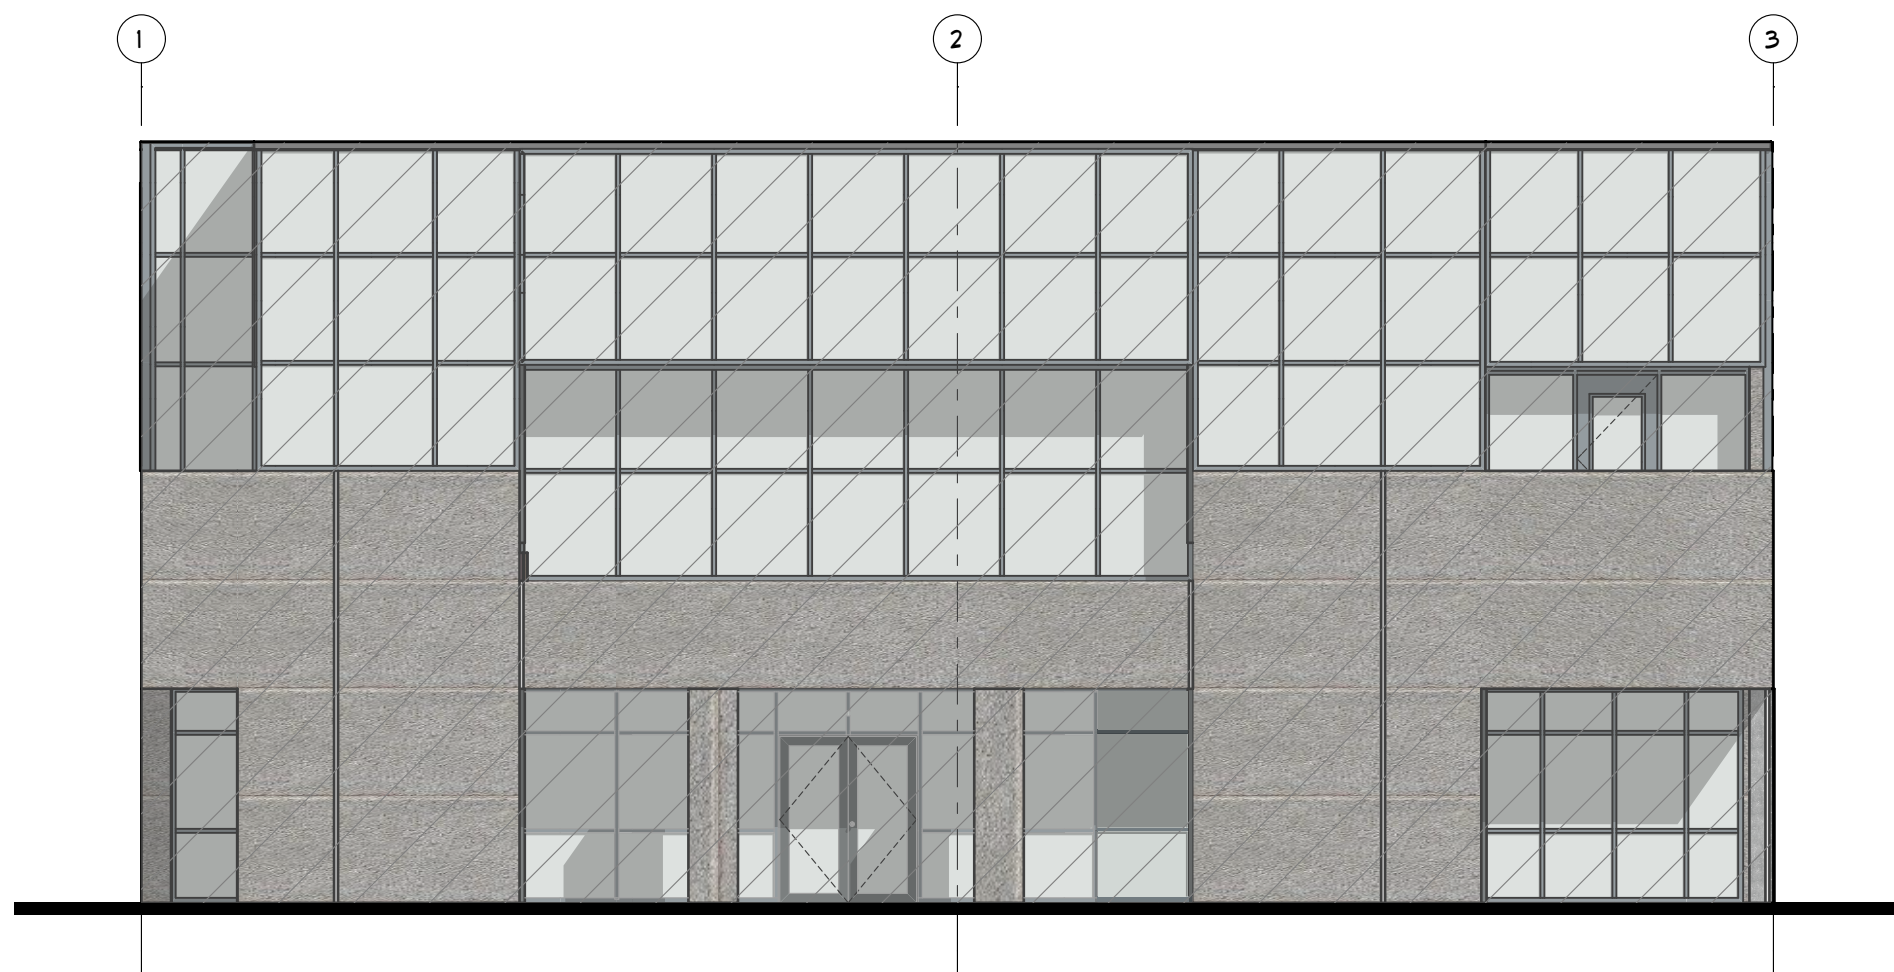


1 (EXISTING) SOUTH ELEVATION
SCALE: 1/8" = 1'-0"

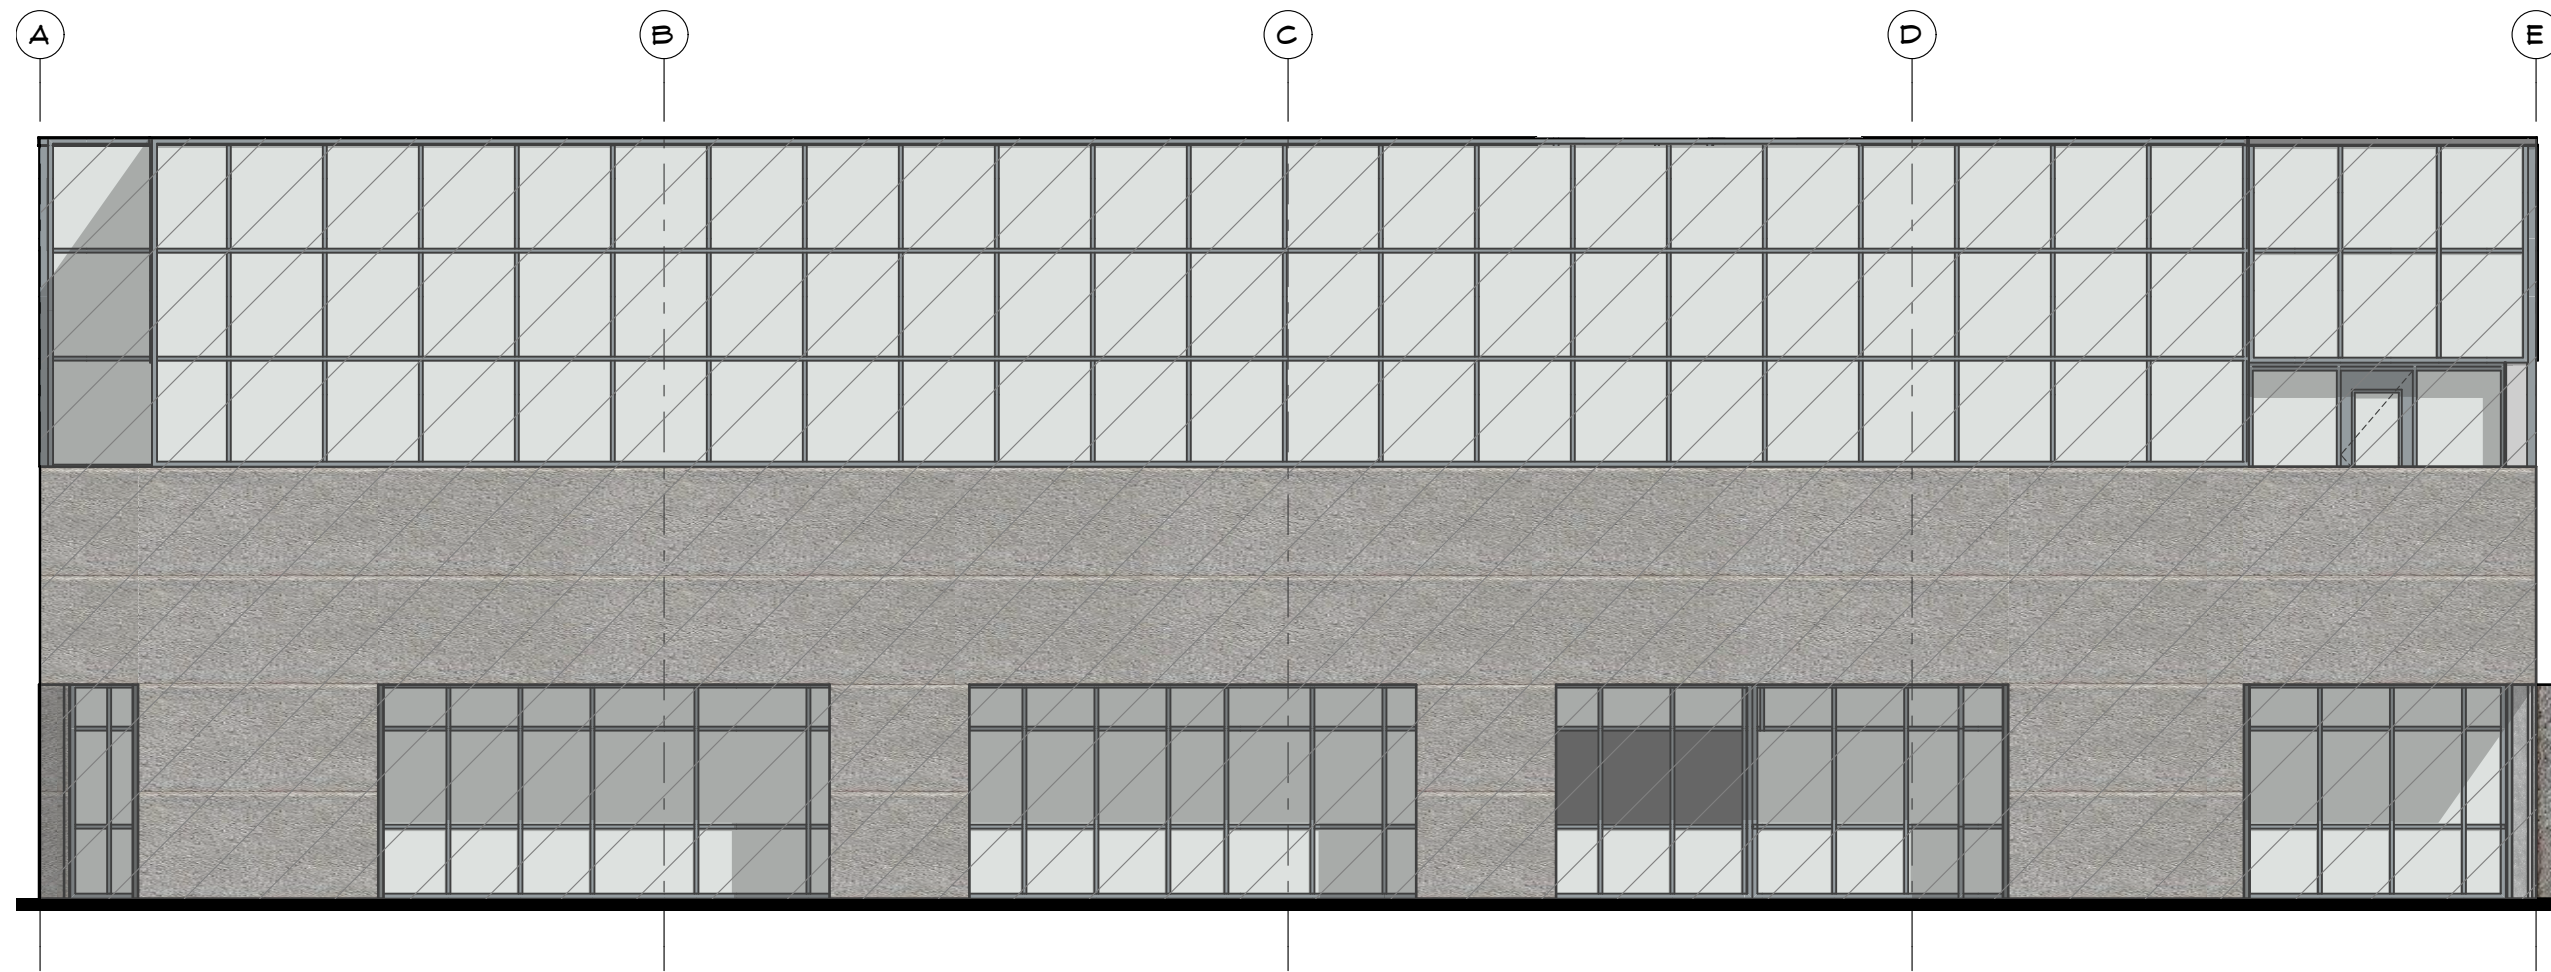


2 (EXISTING) WEST ELEVATION
SCALE: 1/8" = 1'-0"

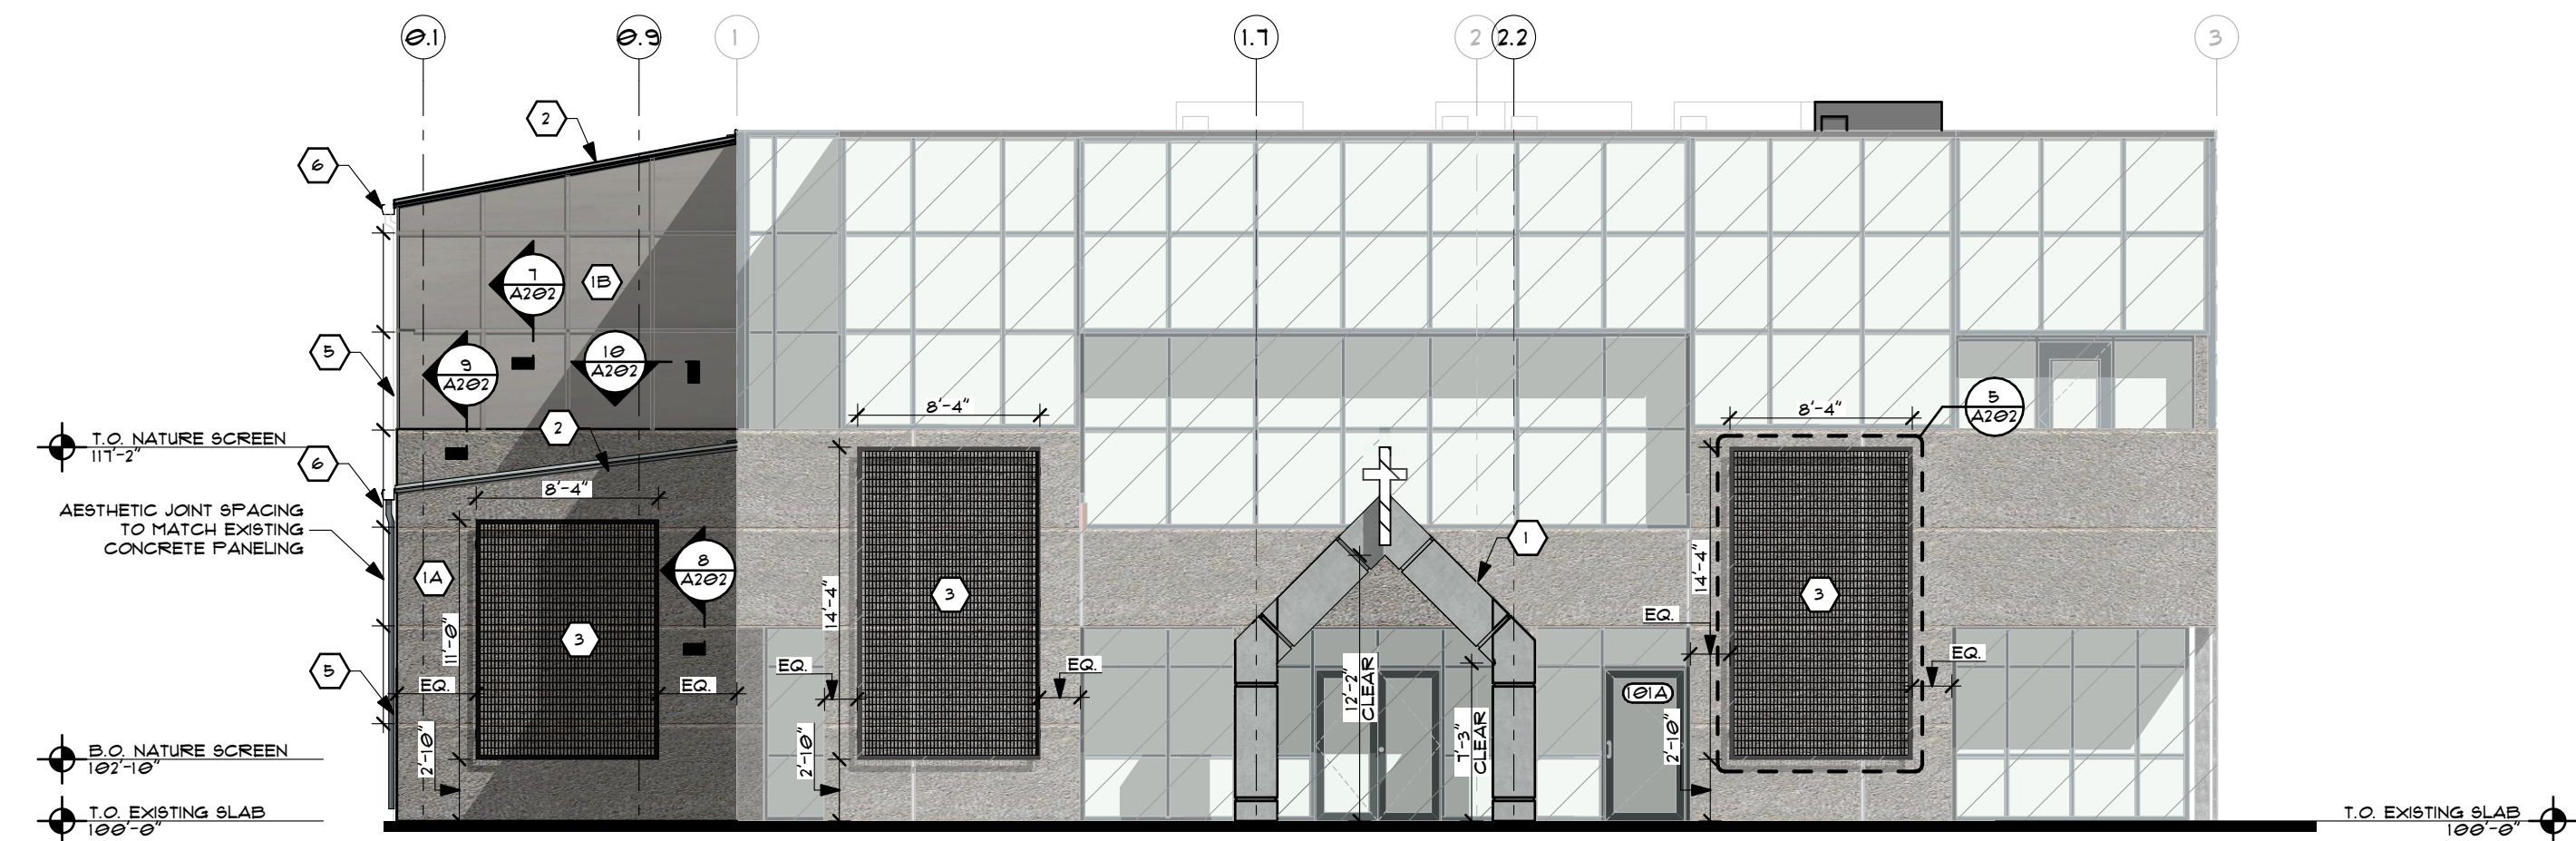


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SCALE: 1/8" = 1'-0"

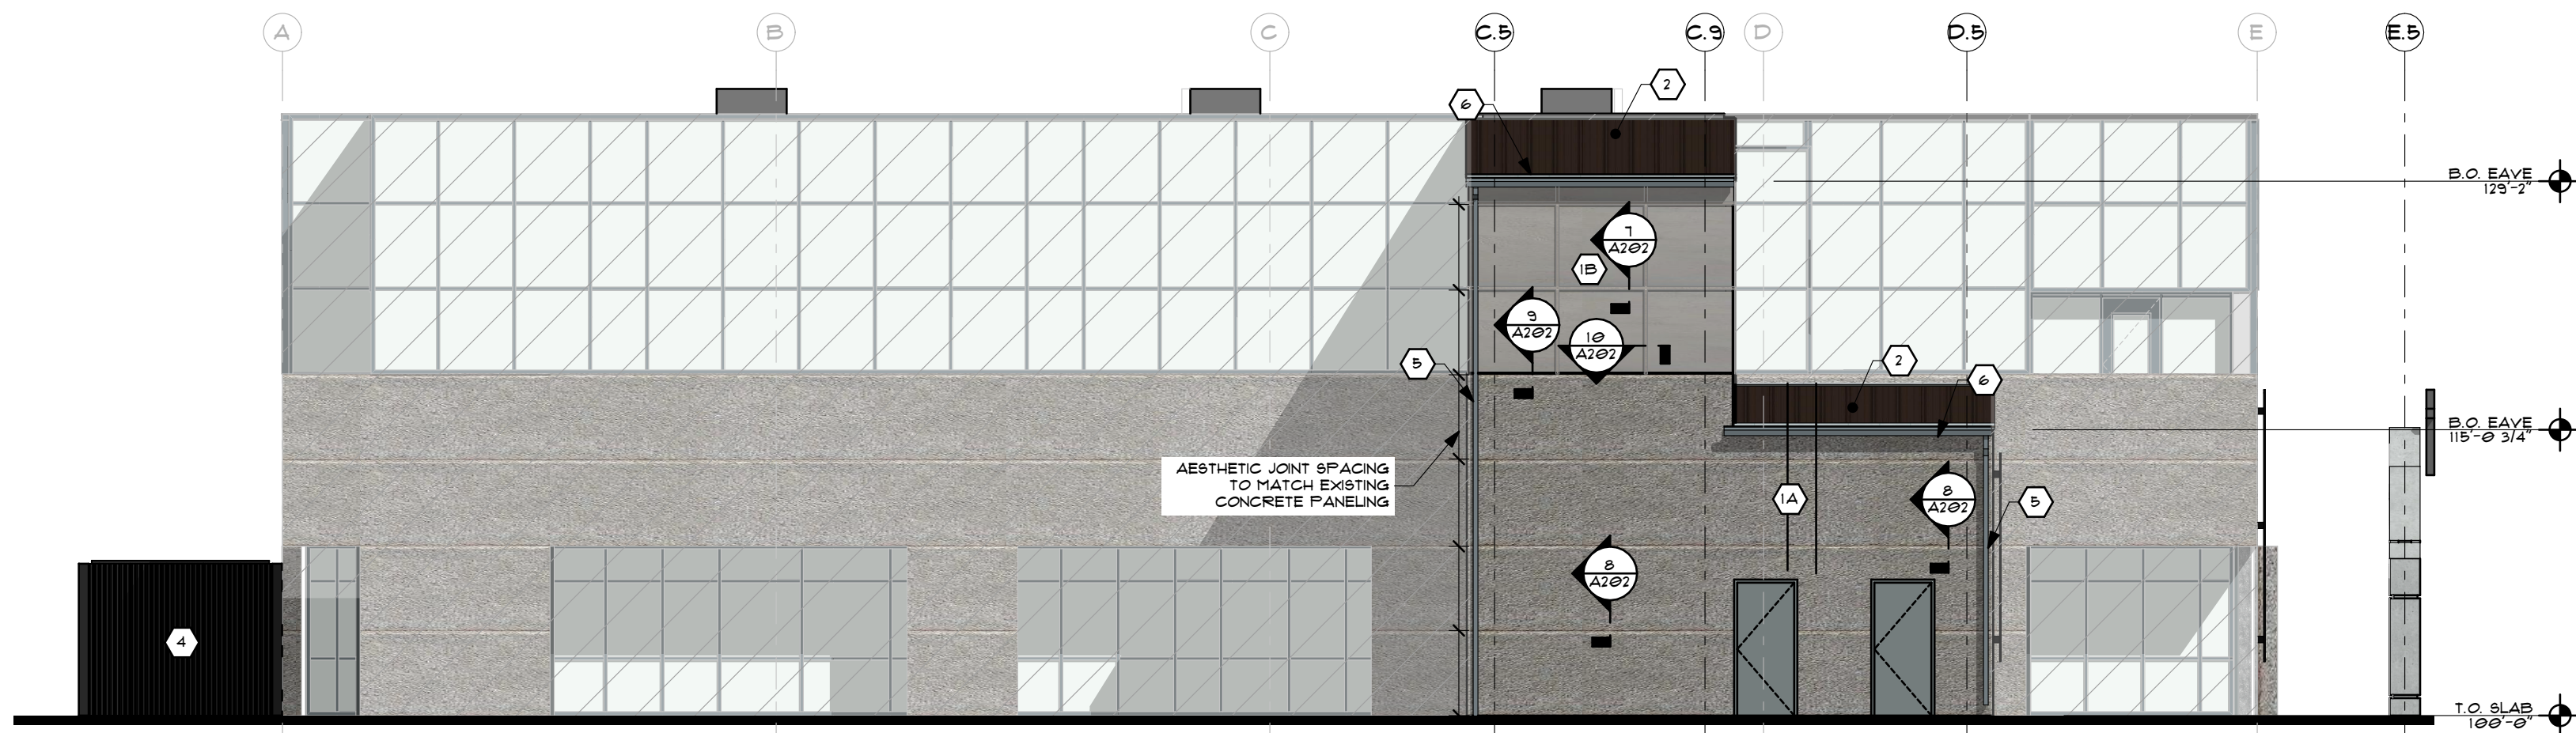


4 WEST ELEVATION
SCALE: 1/8" = 1'-0"

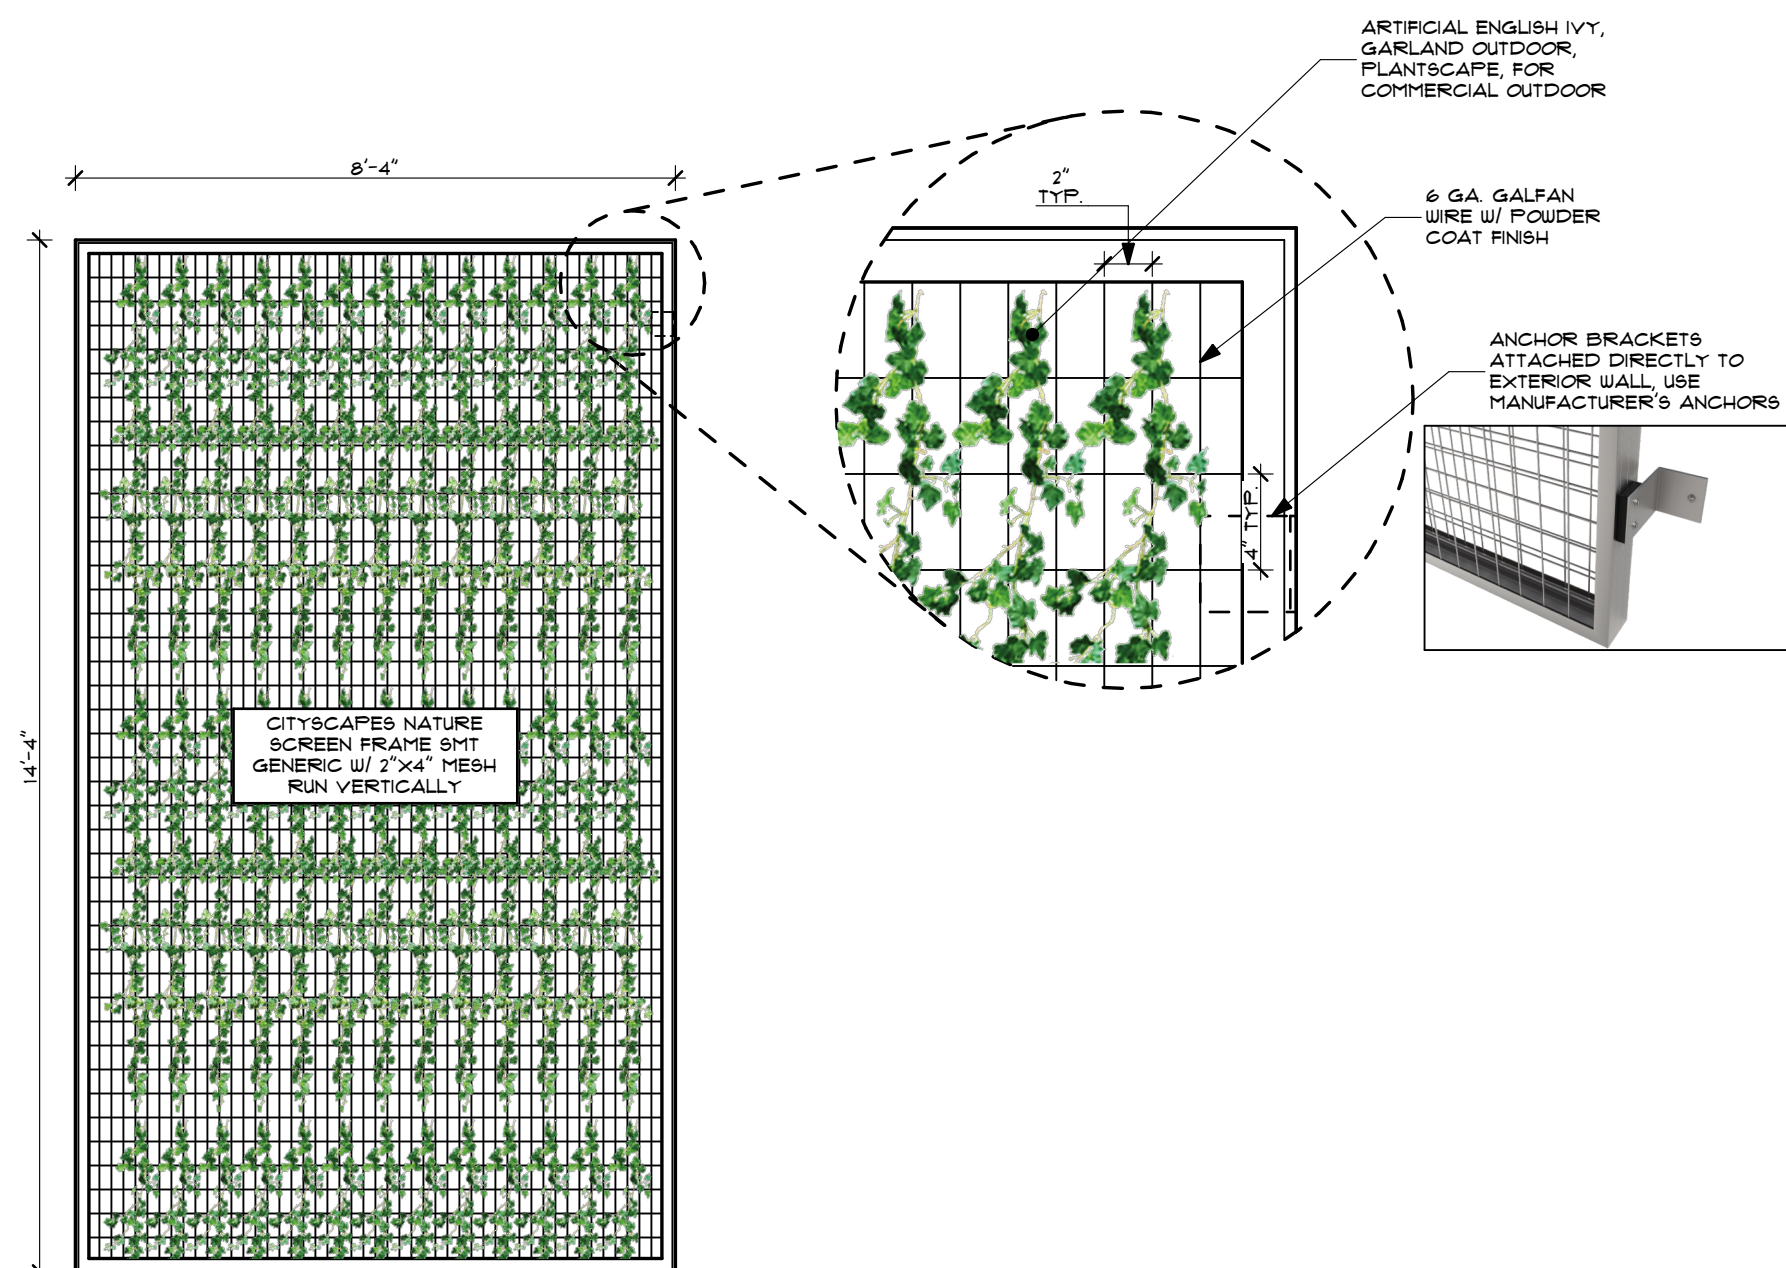


5 NATURE SCREEN DETAIL
SCALE: 3/8" = 1'-0"

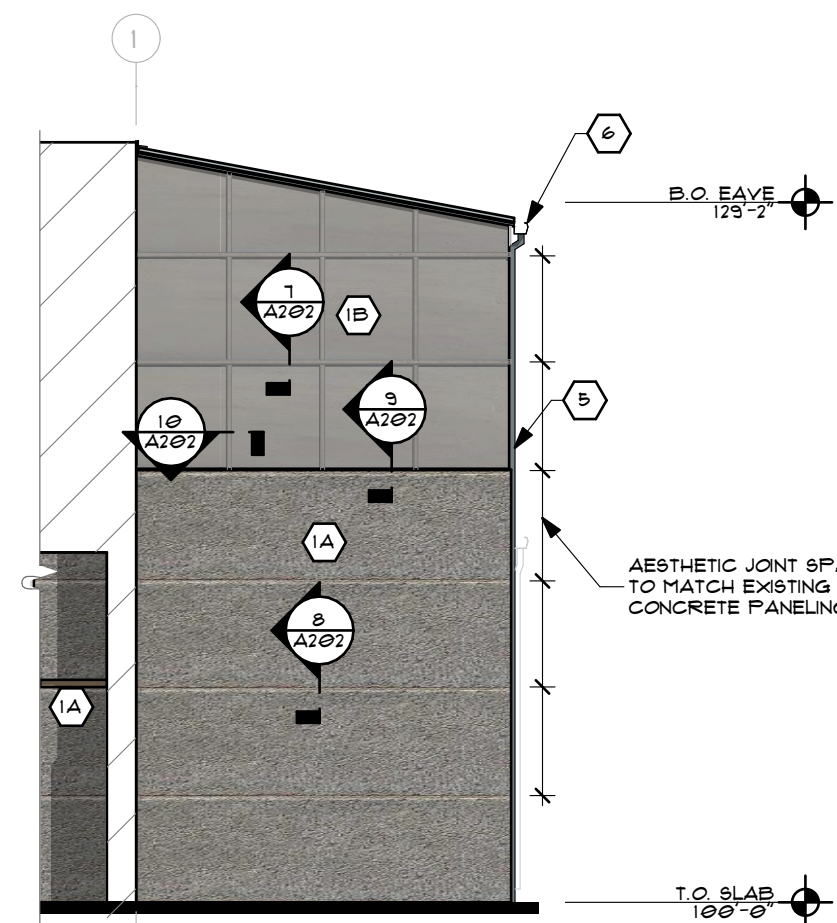


6 NORTH ELEVATION
SCALE: 1/8" = 1'-0"

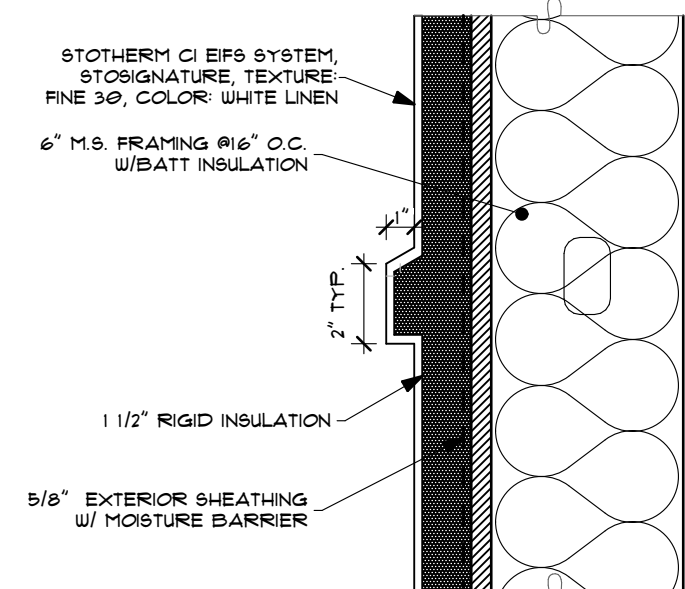


7 EIFS AESTHETIC JOINT DETAIL
SCALE: 1/8" = 1'-0"

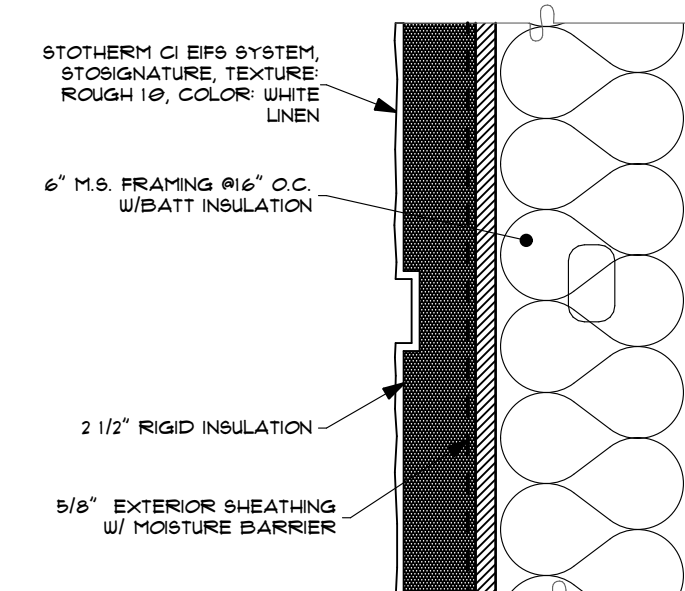

8 EIFS AESTHETIC JOINT DETAIL
SCALE: 1/8" = 1'-0"

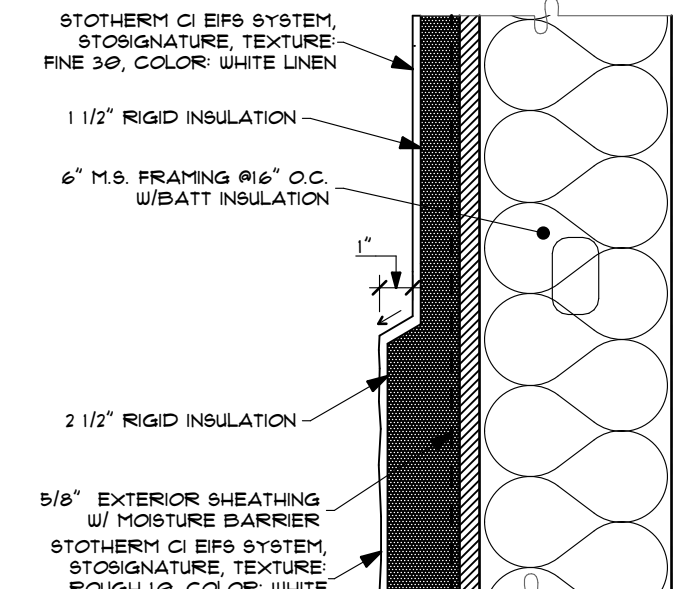

9 EIFS AESTHETIC JOINT DETAIL
SCALE: 1/8" = 1'-0"

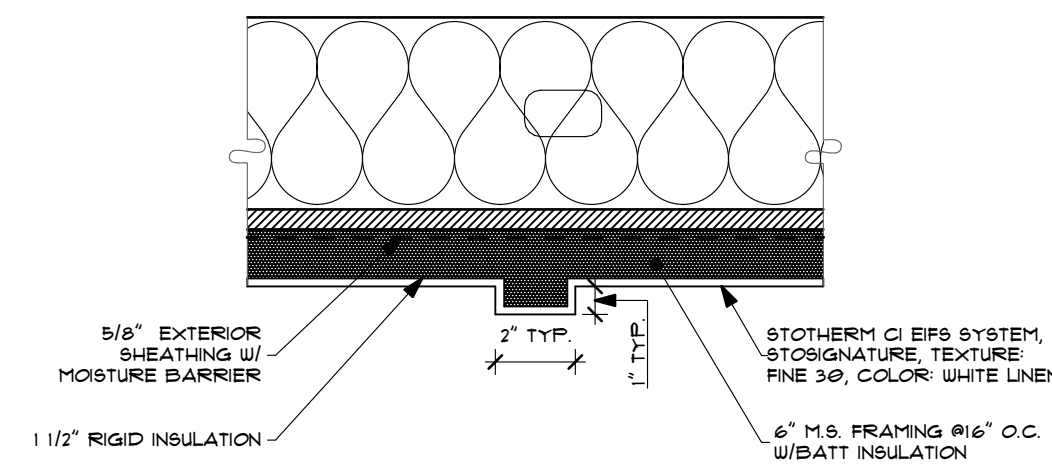

10 EIFS AESTHETIC JOINT DETAIL
SCALE: 1/8" = 1'-0"

EXTERIOR FINISH SCHEDULE	
1	STOTHEM CI EPS, STOSIGNATURE FINISH, TEXTURE: ROUGH 10, COLOR: OYSTER 2162
2	STOTHEM CI EPS, STOSIGNATURE FINISH, TEXTURE: FINE 30, COLOR: OYSTER 2162
3	BATTENLOCK 145 METAL ROOF, SIG. 200, COLOR: BURNISHED SLATE
4	METAL MESH PANEL, CITYSCAPES NATURESCREEN, REF. 5/A202
5	MECHANICAL UNIT ENCLOSURE, CITYSCAPES TRUE LOUVER, REF. 2/G106
6	3"x3" DOWNSPOUT, SIG. 200, COLOR: BURNISHED SLATE
7	6" GUTTER, SIG. 200, COLOR: BURNISHED SLATE

EXTERIOR ELEVATION LEGEND	
[Line Style]	EXTERIOR IMPROVEMENTS
[Line Style]	NO EXTERIOR IMPROVEMENTS

HILBERS
INCORPORATED
CONTRACTORS & ENGINEERS

BGW
ARCHITECTS

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REV.	DATE	DESCRIPTION
0	11-09-2024	ORIGINAL ISSUE
1	3-09-2025	PLANNING REVIEW
2	4-18-2025	PLANNING REVIEW

SOCAL CHURCH OF CHRIST
INTERIOR RENOVATION

1036 W TAFT AVE
ORANGE, CA 92665

BGW ARCHITECTS | 1327 GRANT AVE - OGDEN, UT 84401 | PH: 801-409-1941 | WWW.BGWARCHITECTS.COM

EDWARD WRIGHT
REGISTERED ARCHITECT
04/18/2025
RENEWAL DATE

SEAL

EXTERIOR ELEVATIONS

SHEET NUMBER:


A202

DO NOT SCALE DRAWING

SHEET TITLE:

PROJECT #: A202-4


ORIGINAL ISSUE: 11-09-2024

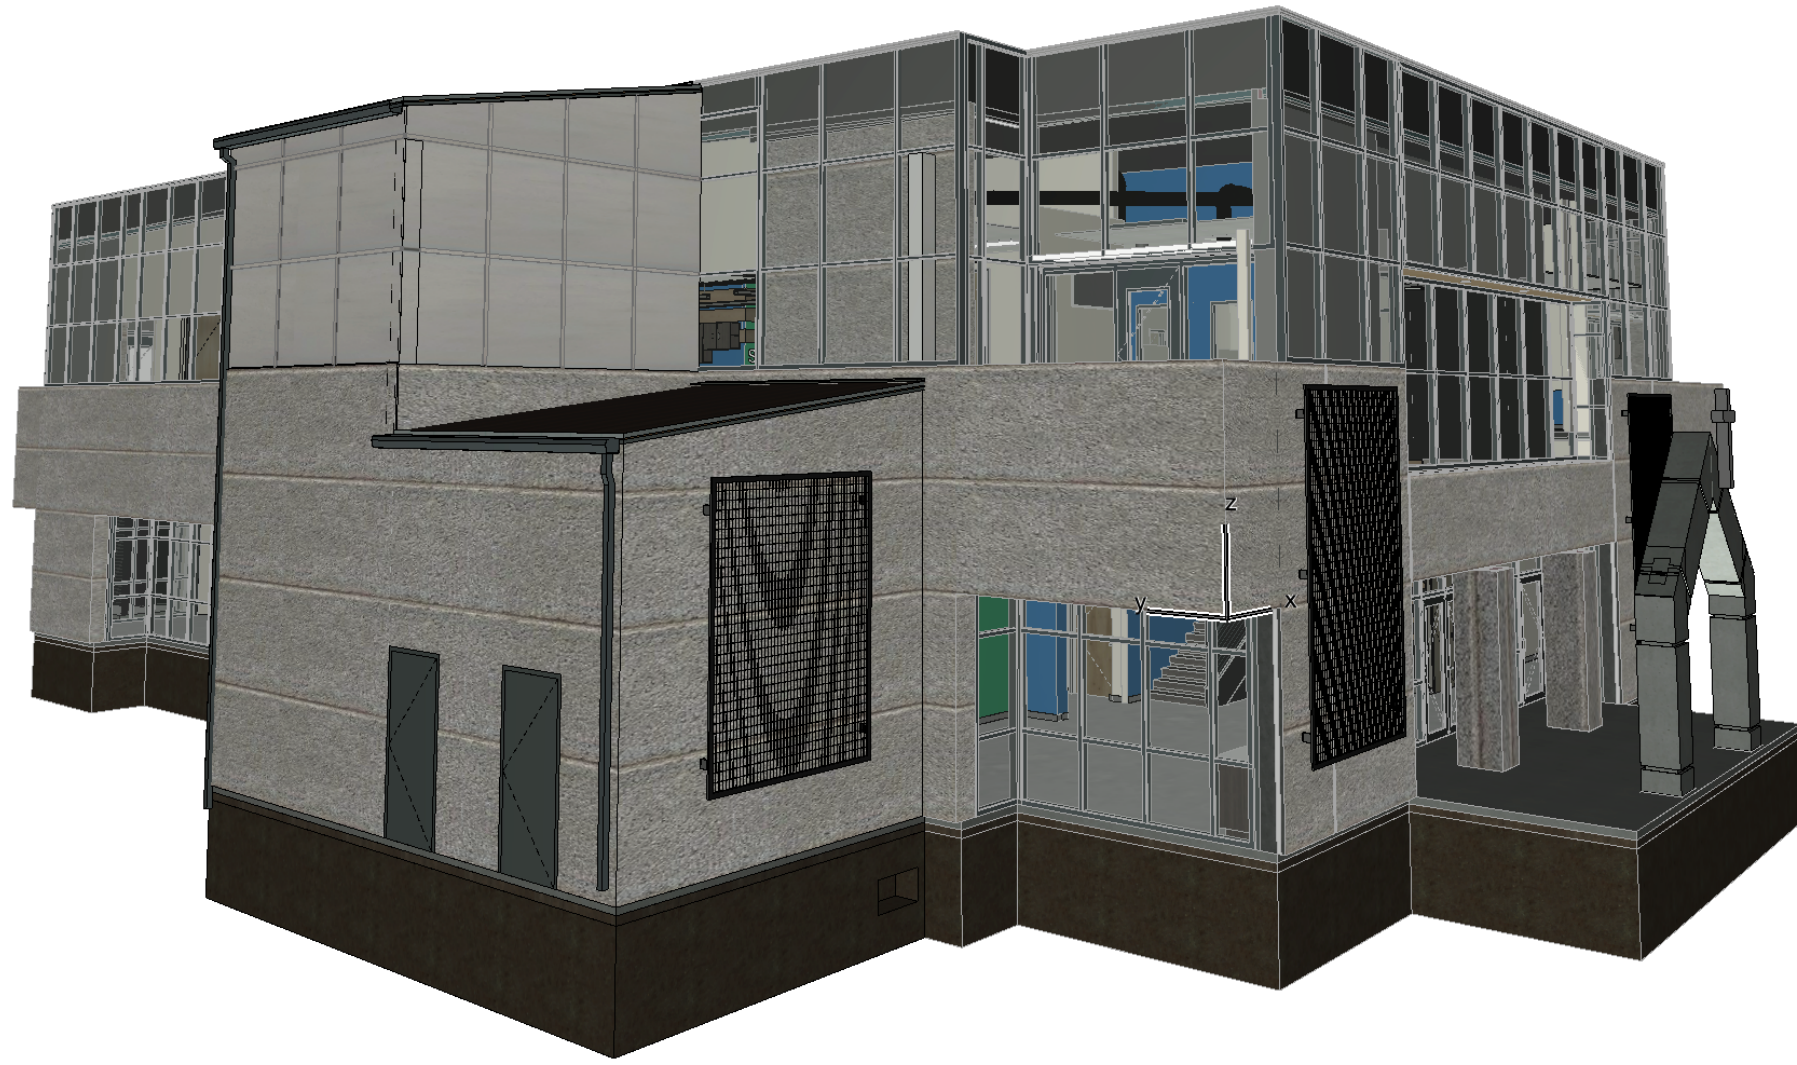

VIEW #1



VIEW #2

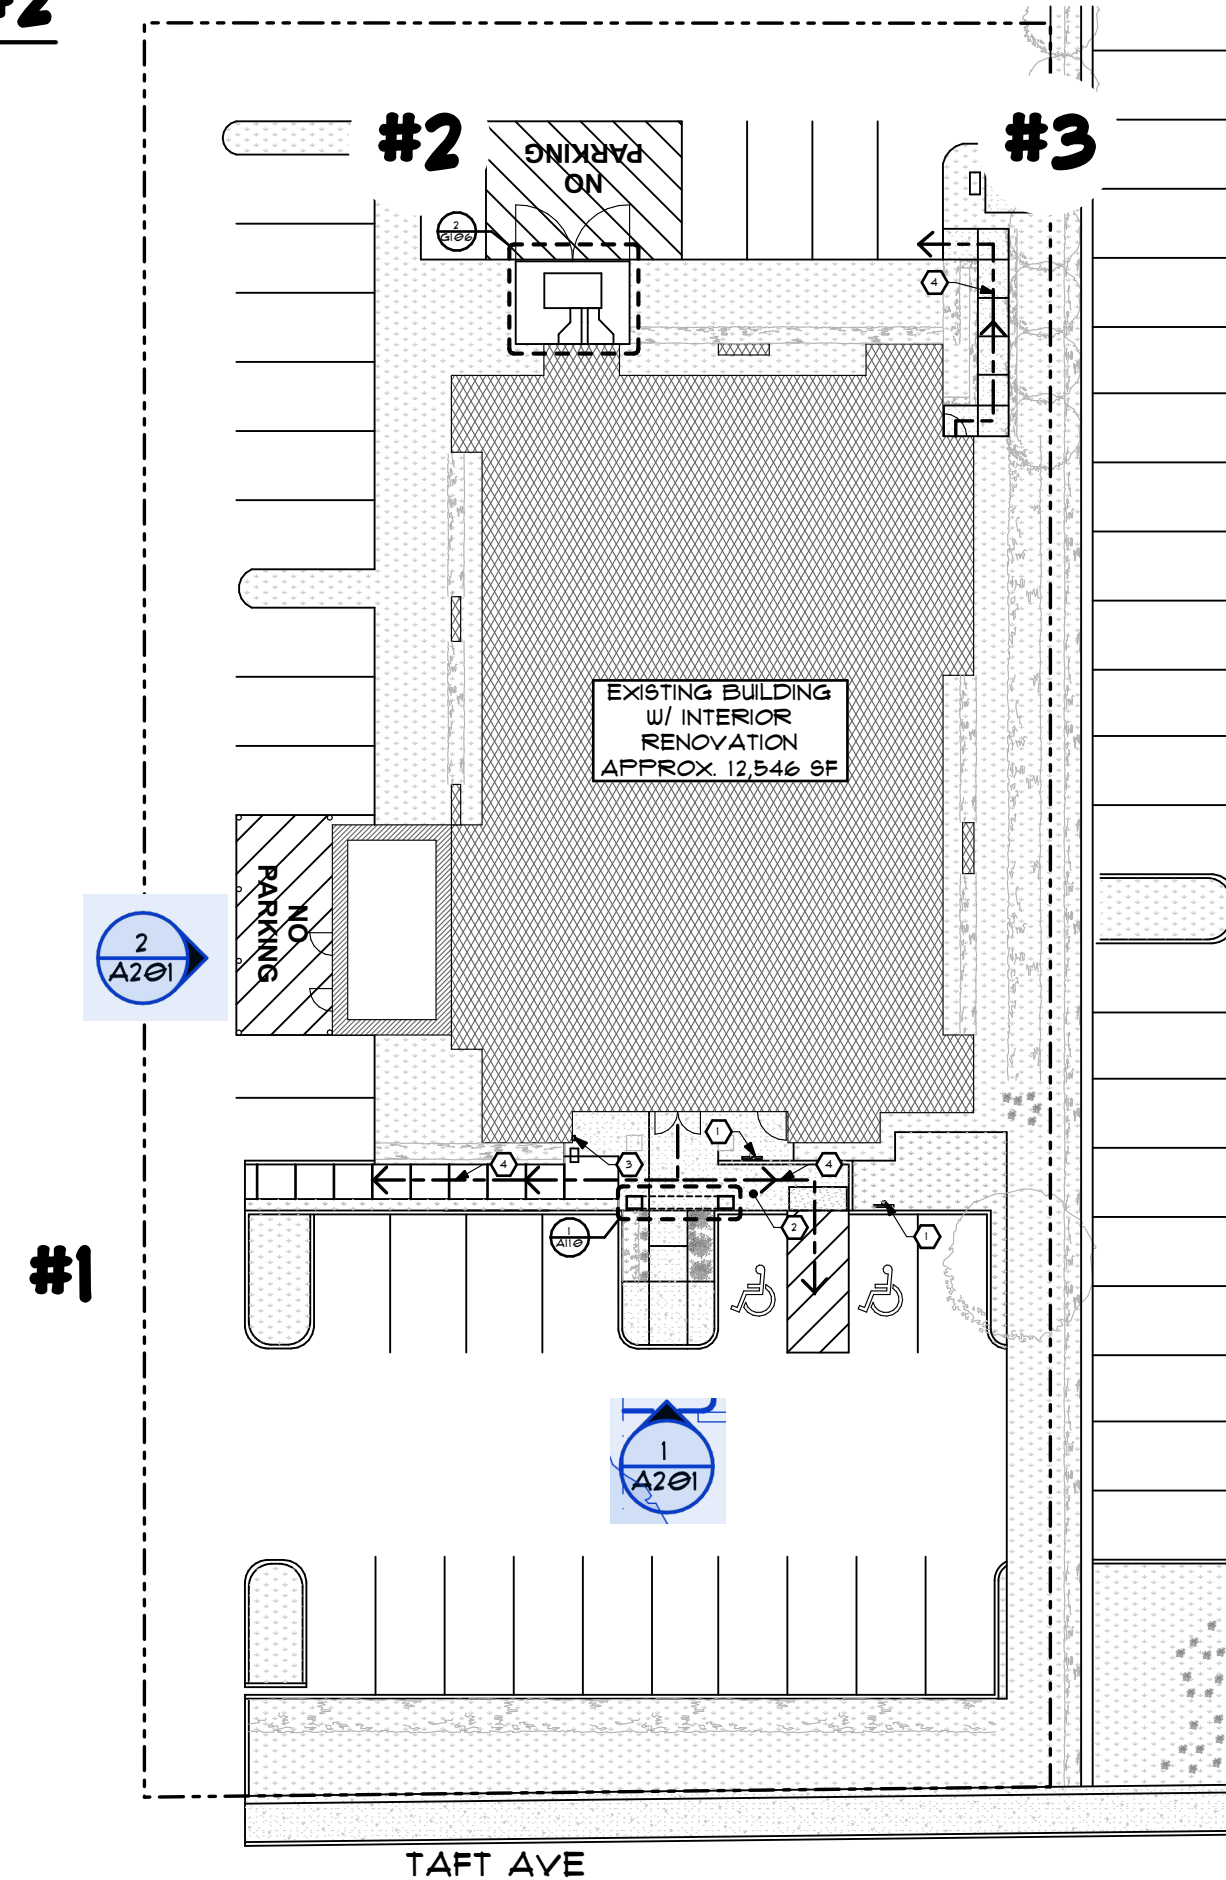


1036 W TAFT AVE.
ORANGE, CA 92865
LOCATION KEY

ELEVATOR ADDITION
EXTERIOR FINISH




EXISTING CONCRETE FINISH

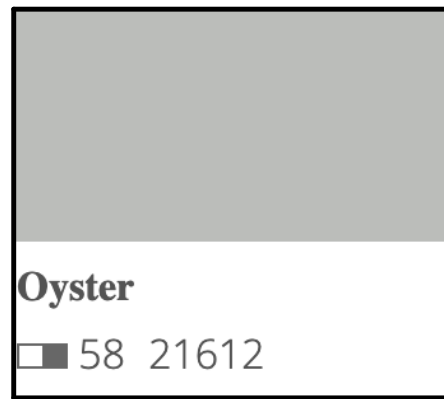


STOTHERM CI W/ STOSIGNATURE
FINISH W/ ROUGH 10 & FINE 30
TEXTURES

ACCENT LINE WIDTHS TO
MATCH EXISTING

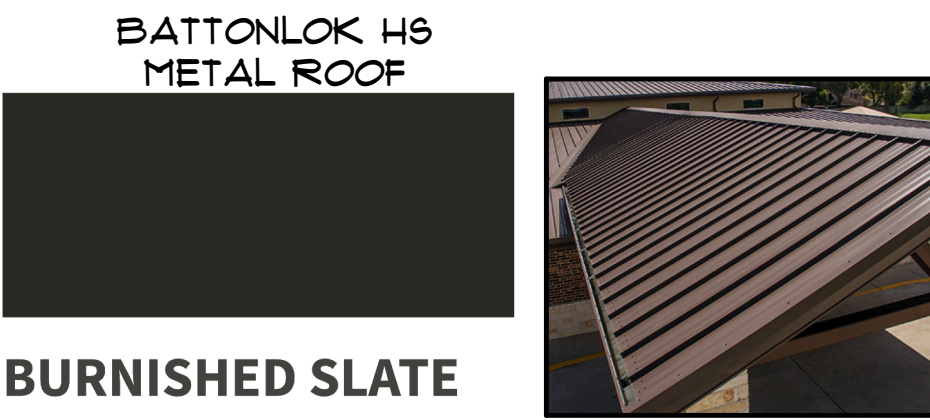


EXTERIOR FINISH SCHEDULE	
1	STOTHERM CI EPS SYSTEM, STOSIGNATURE FINISH, TEXTURE: ROUGH 10, COLOR: OYSTER 58/21612
2	STOTHERM CI EPS SYSTEM, STOSIGNATURE FINISH, TEXTURE: FINE 30, COLOR: OYSTER 58/21612
3	BATTONLOK H5 METAL ROOF, SIG. 2009, COLOR: BURNISHED SLATE
4	METAL MESH PANEL, CITYSCAPES NATURESCREEN, REF. SIA202
5	MECHANICAL UNIT ENCLOSURE, CITYSCAPES TRUE LOUVER, REF. 210106
6	3"x3" DOWNPOUT, SIG. 2009, COLOR: BURNISHED SLATE
7	6" GUTTER, SIG. 2009, COLOR: BURNISHED SLATE


EXTERIOR ELEVATION LEGEND	
[Pattern]	EXTERIOR IMPROVEMENTS
[Pattern]	NO EXTERIOR IMPROVEMENTS

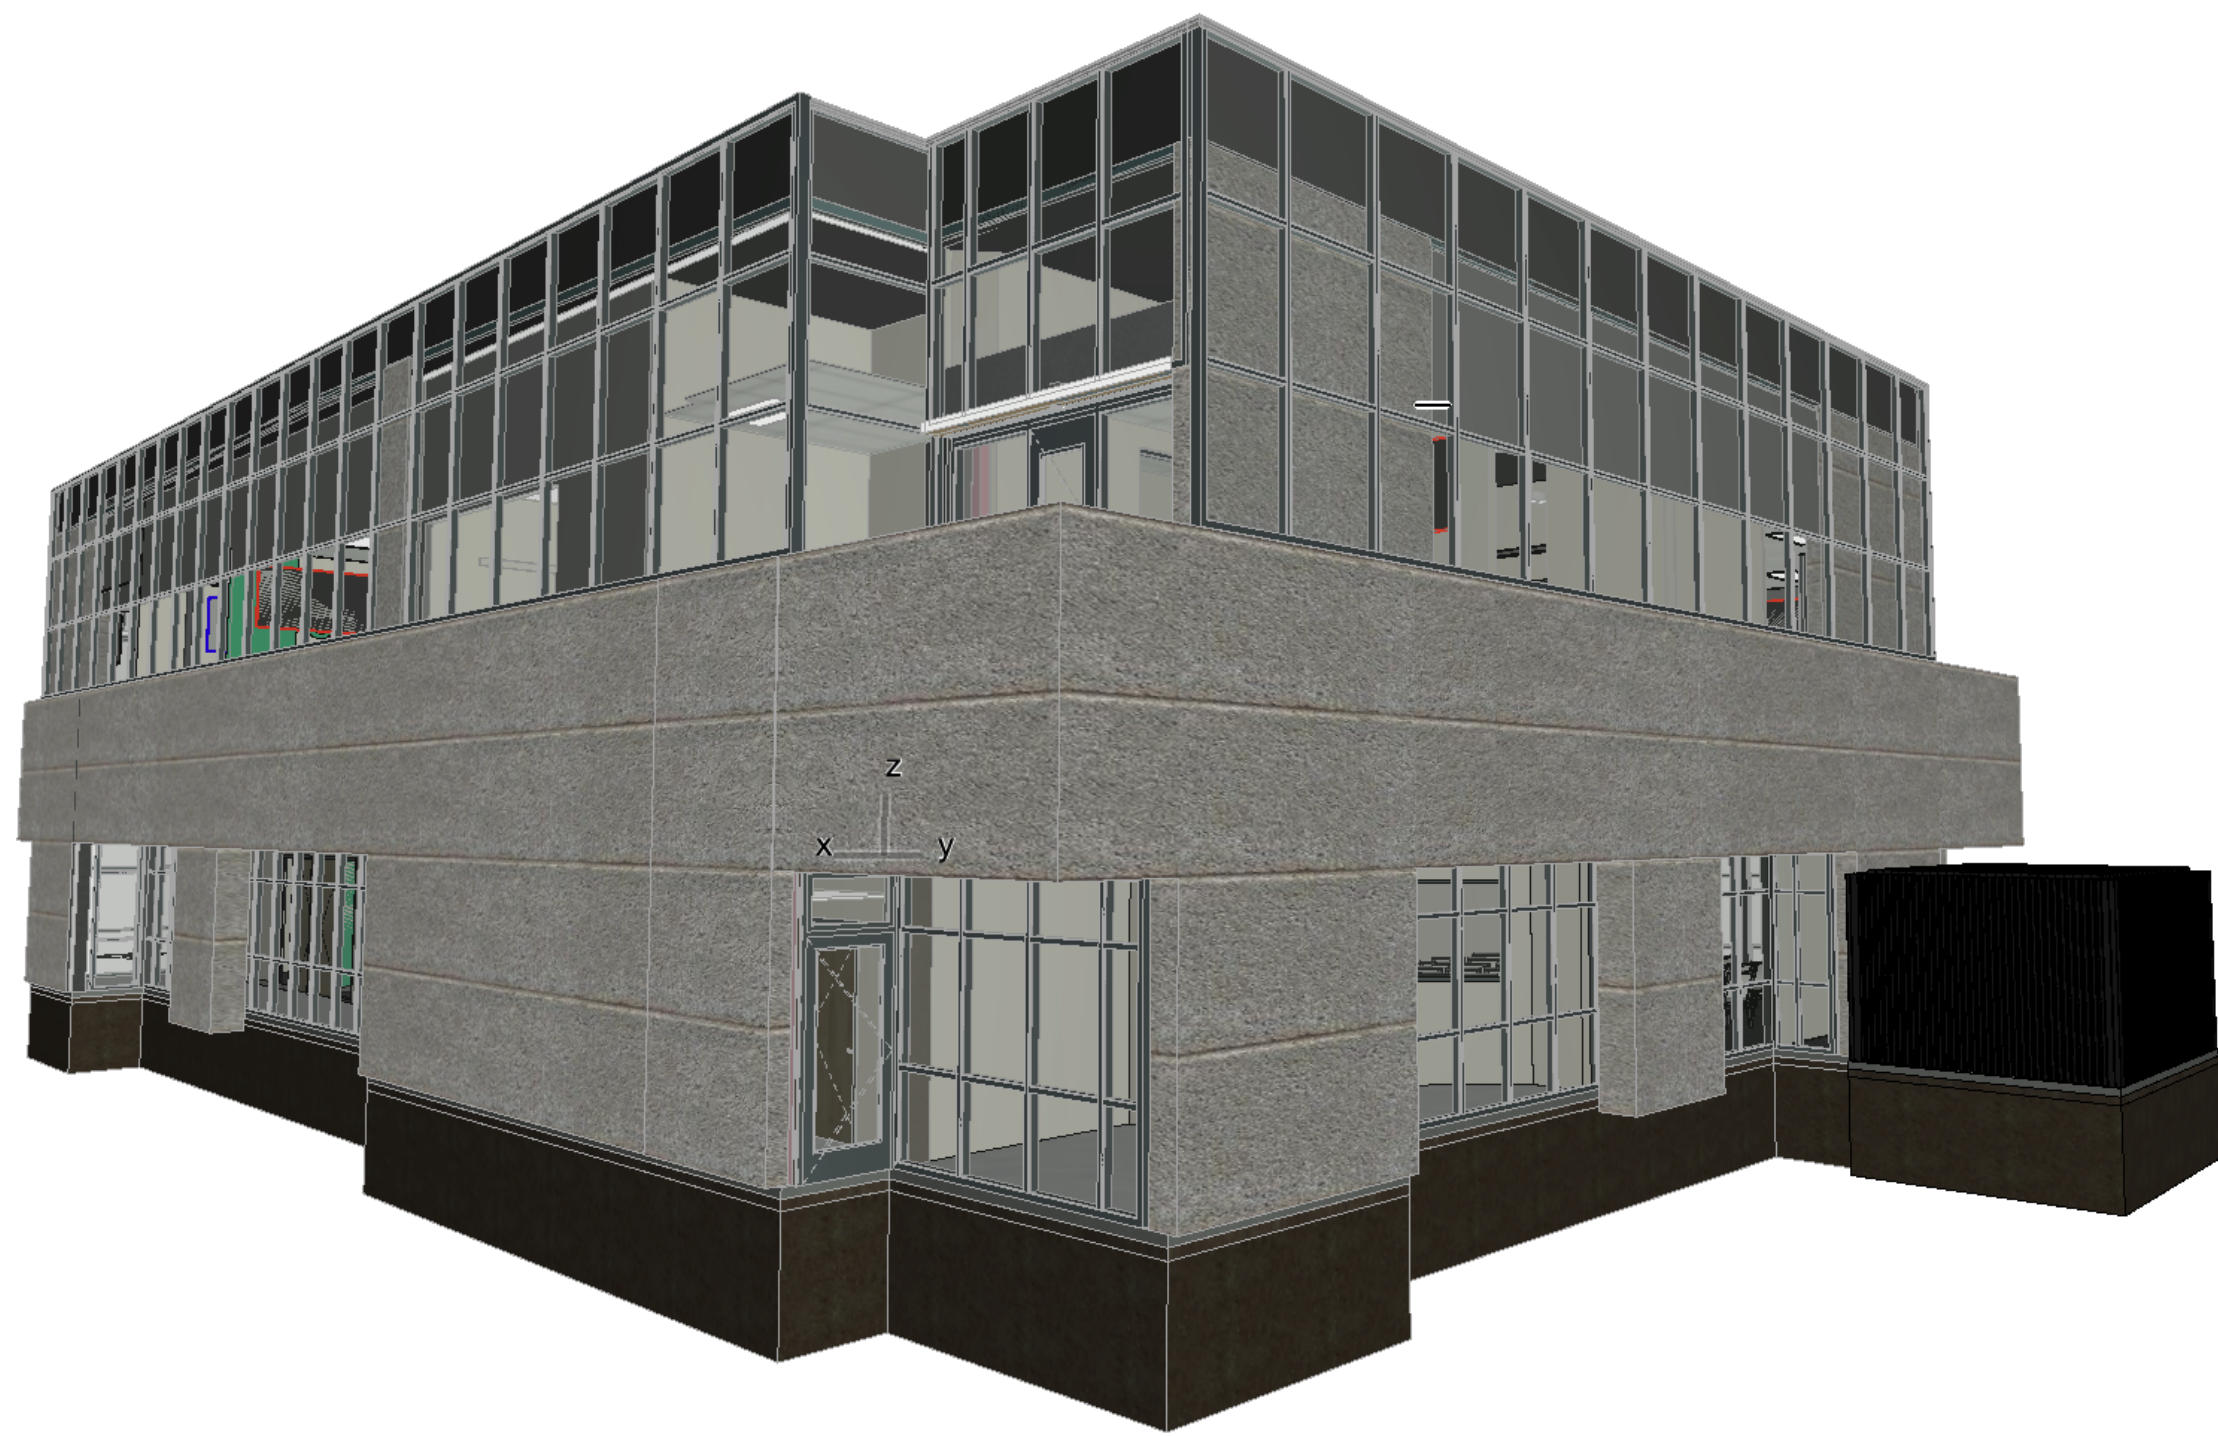

VIEW #3

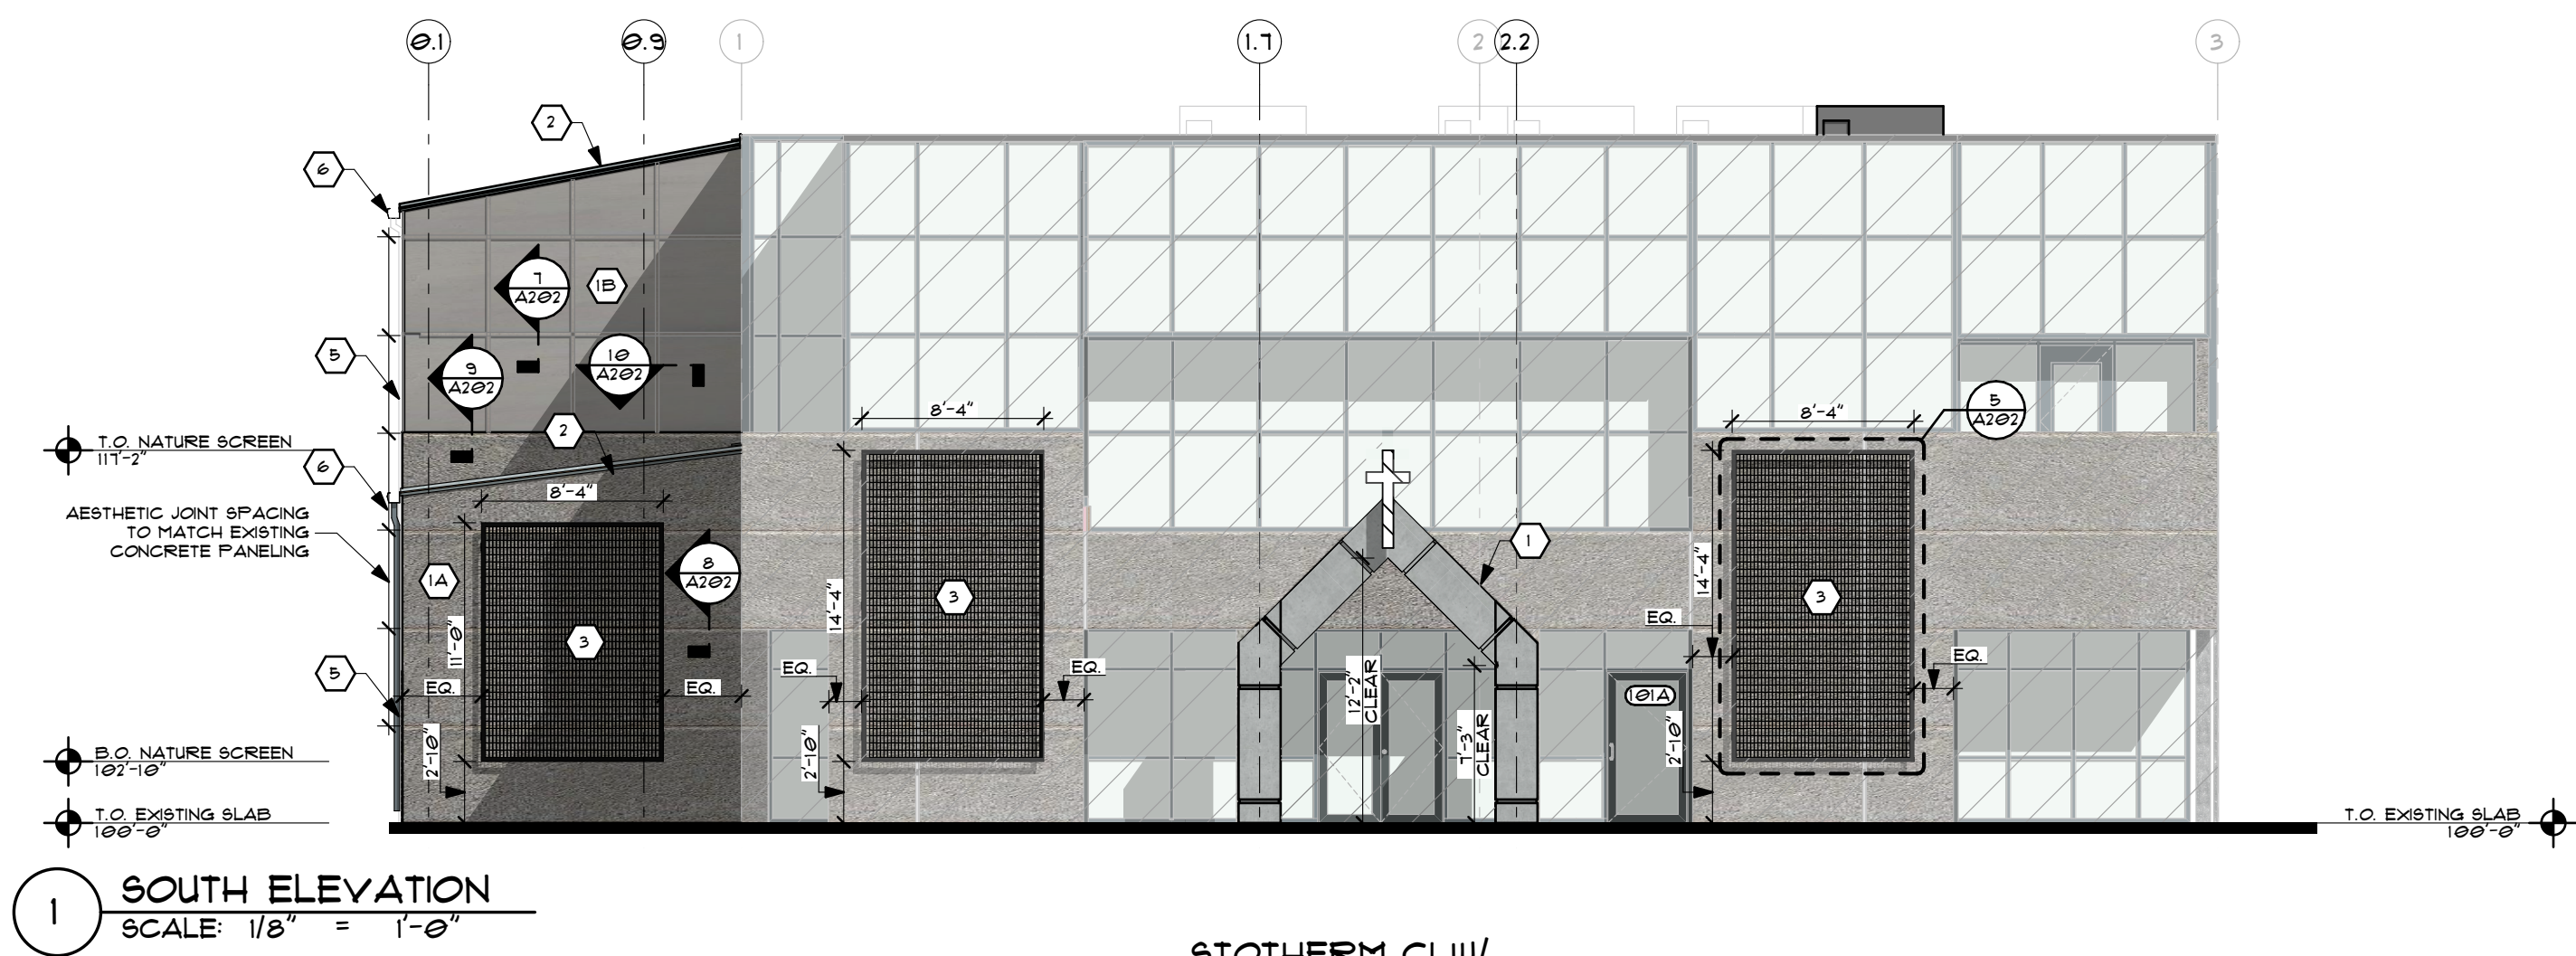


1 SOUTH ELEVATION
SCALE: 1/8" = 1'-0"

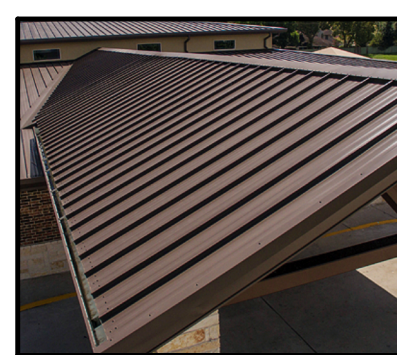

BATTONLOK H5
METAL ROOF


BURNISHED SLATE

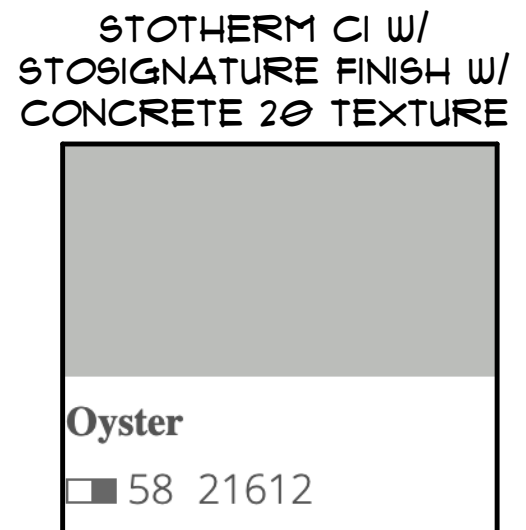

STOTHERM CI W/
STOSIGNATURE FINISH W/
CONCRETE 20 TEXTURE




EXISTING CONCRETE FINISH

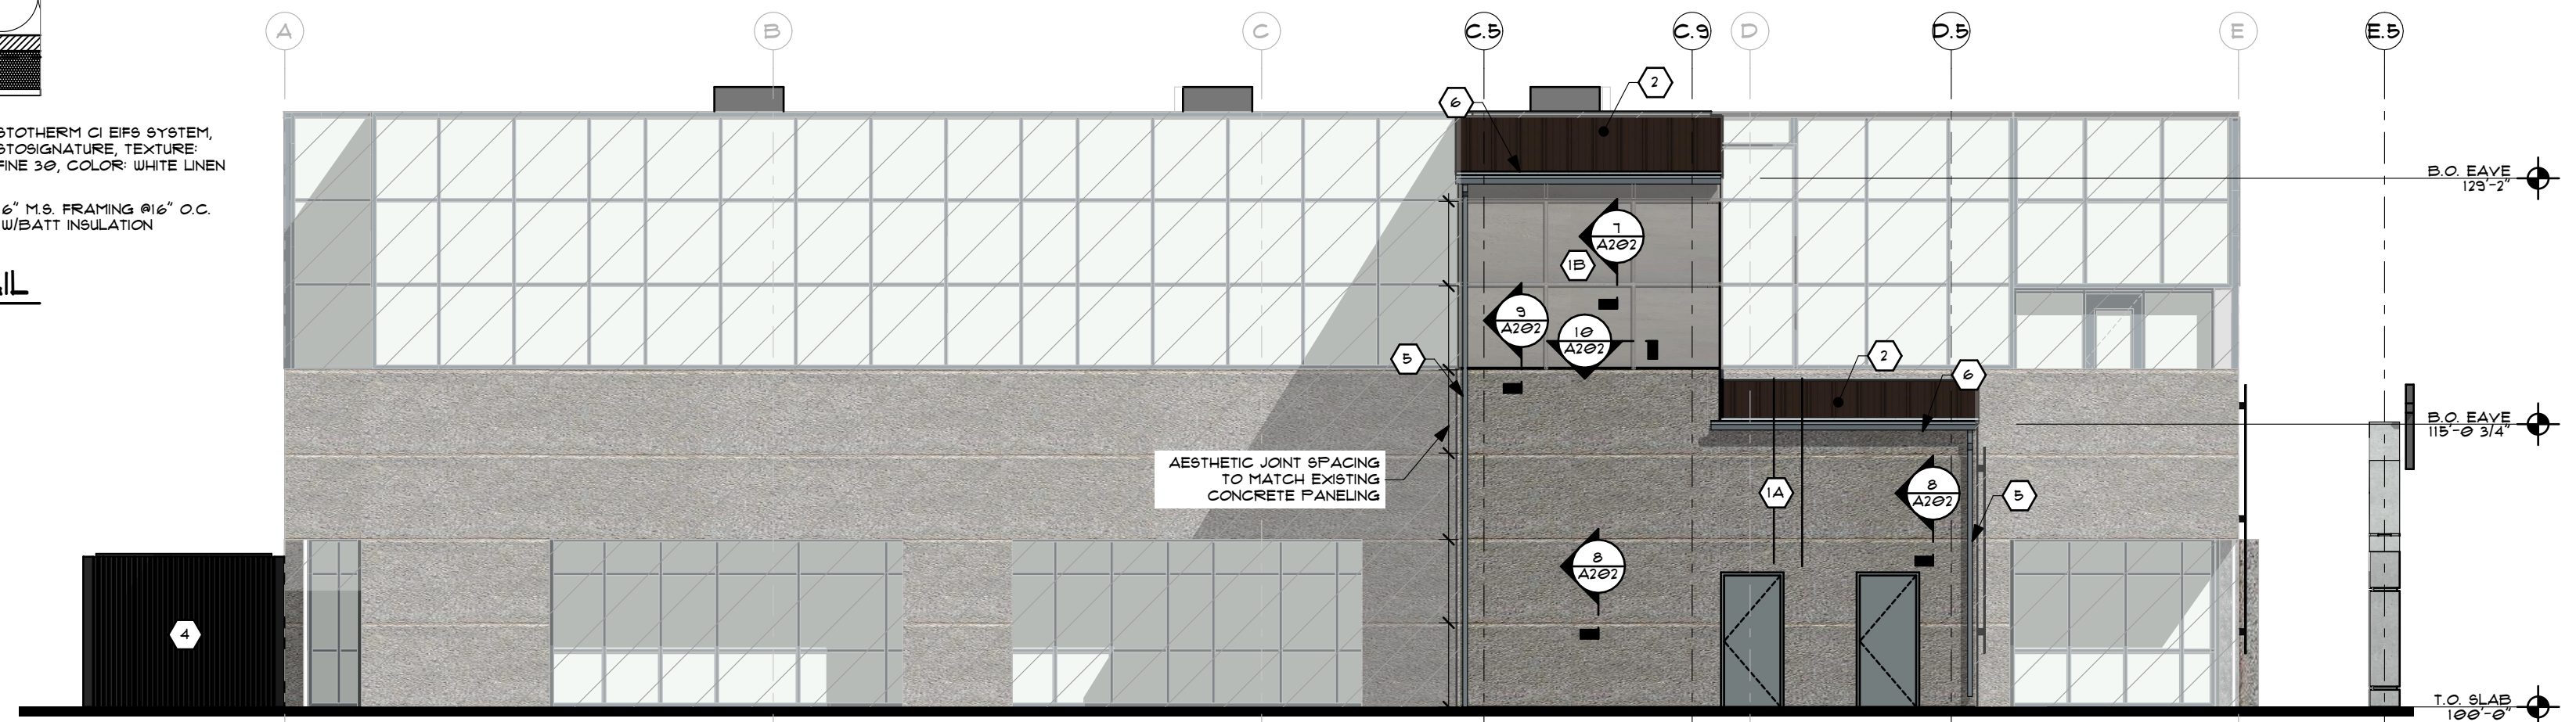

2 WEST ELEVATION
SCALE: 1/8" = 1'-0"



ELEVATION #1

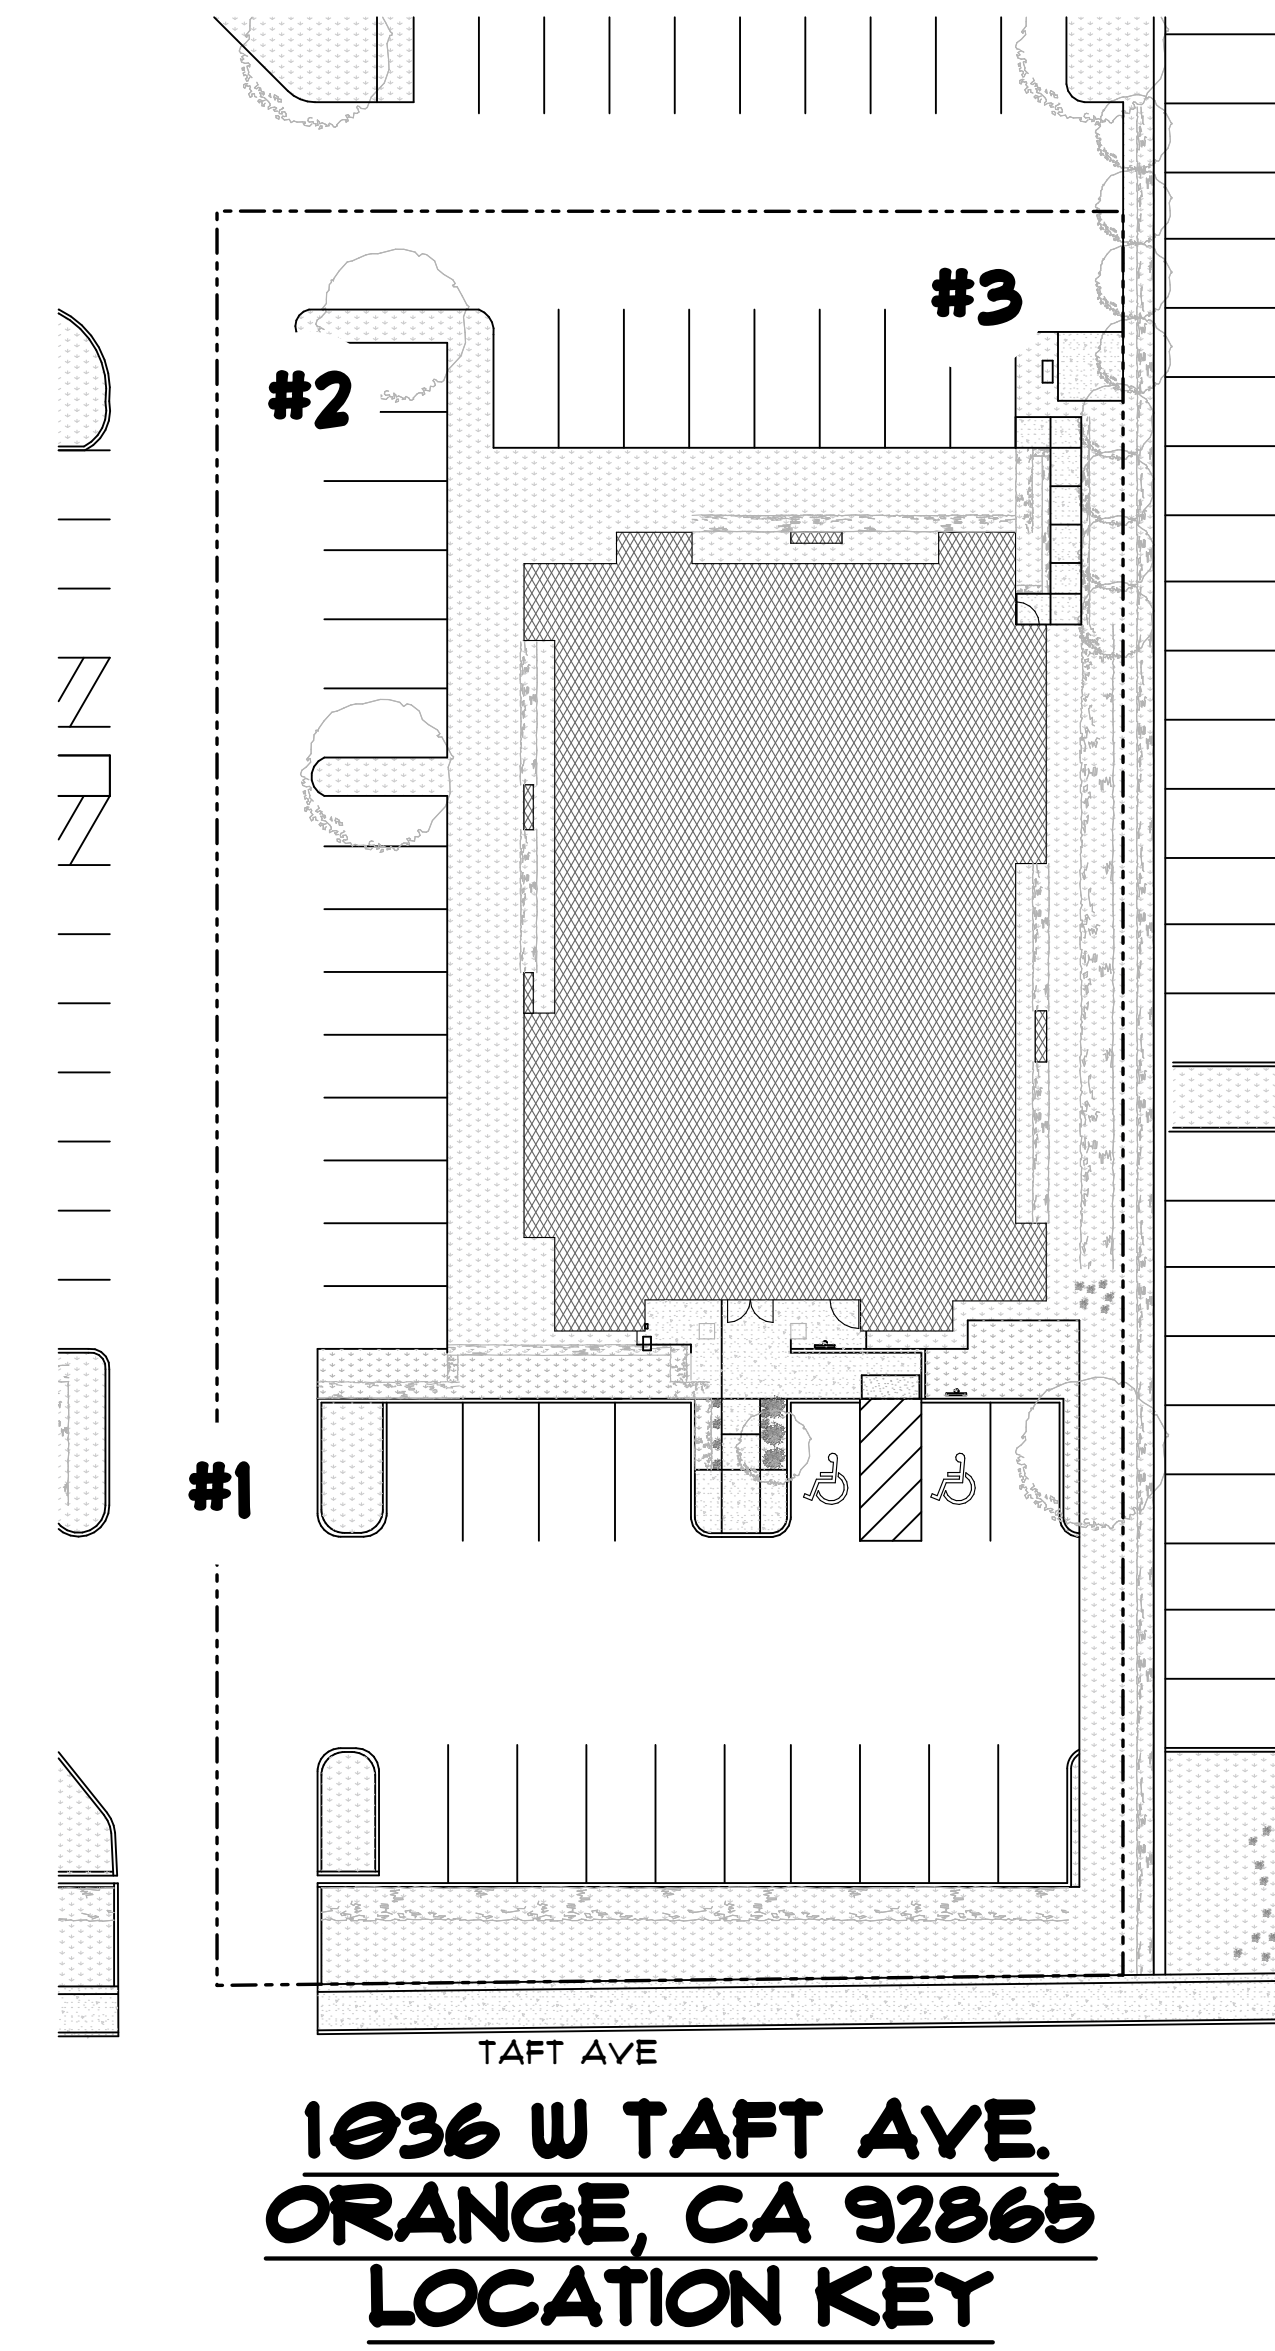

ELEVATION #2



ELEVATION #3