

AREA MODIFICATION AS IT PERTAINS TO THE CITY OF ORANGE HISTORIC AND DESIGN REVIEW BOARD.

SCOPE OF CHANGES

- (A) REPLACE OVERHEAD ROLL-UP DOOR WITH NANAWALL SLIDE AND STACK WINDOW SYSTEM. WINDOW FRAME TO BE PAINTED WOOD TO MATCH OTHER WINDOWS AND DOORS. + ADD AWNING WITH WOOD FASCIA. **REFER TO DETAILS ON** A105.
- (B) REPLACE SOLID DOOR WITH SINGLE WOOD FRENCH DOOR WITH FROSTED GLAZING. STYLE AND FINISH TO MATCH EXISTING FRONT ENTRY DOORS.
- (C) REPLACE PAIR OF SOLID DOORS WITH PAIR OF WOOD FRENCH DOORS WITH FROSTED GLAZING. STYLE AND FINISH TO MATCH EXISTING FRONT ENTRY DOORS.

_____ EXISTING BUILDING AT 391 S. GLASSELL ST. ORANGE, CA 92866 APN - 390-401-09 LOT# - 7 TRACT C2

2 - PARTIAL SITE PLAN - PROPOSED SCALE = 1/4" = 1'-0"

PROJECT ADDRESS

391 SOUTH GLASSELL STREET ORANGE, CA 92866

LEGAL DESCRIPTION

APN 390-401-09 - LOT 7 - TRACT C2 CULVER TRACT

PROJECT DESCRIPTION

REPLACE EXISTING SOLID DOORS AT THE SOUTH AND WEST ELEVATIONS WITH NEW DOORS WHICH CONTAIN WINDOWS AND REPLACE OVERHEAD ROLL-UP DOOR WITH OPERABLE WINDOW WITH FROSTED GLAZING + ADD ROOF OVERHANG WITH METAL FASCIA OVER NEW WINDOW.

CODE ANALYSIS CODE

CONSTRUCTION TYPE OCCUPANCY OCCUPANT LOAD STORIES FIRE SPRINKLER PARKING

BUILDING LOT AREA LOT AREA

EXISTING BUILDING AREA **BUILDING RFA**

PROPOSED BUILDING AREA BUILDING RFA

5 (4 ON STREET, 1 HC STALL OFF STREET) 3,500 SF

2019 CRC, CBC,CMC, CEC, CPC

V-B (NON-SPRINKLERED)

2,438 SF/100 = 25 (OFFICE)

2,438 SF

B (OFFICE)

NA

2,438 SF

PROJECT INFORMATION

OWNER/ARCHITECT: MCCLEAN DESIGN INC. NATHAN HUNT 190 S GLASSELL ST, #203 ORANGE, CA 92866 TEL: (714) 505-0556

TITLE 24 ENGINEER:


FARAHMAND ENGINEERING, INC FARITETH (FAYE) FARAHMAND 3679 MOTOR AVE. SUITE 204 LOS ANGELES, CA 90034 TEL: (310) 560-6641


PROJECT TEAM

STRUCTURES


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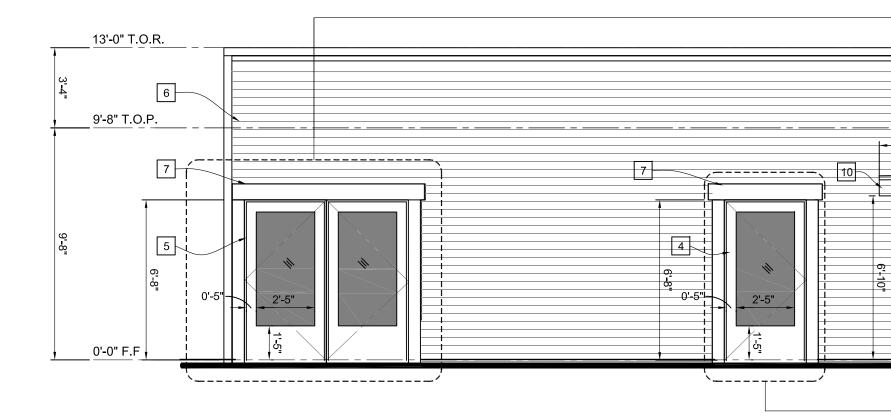
TEL: (949) 715-0775



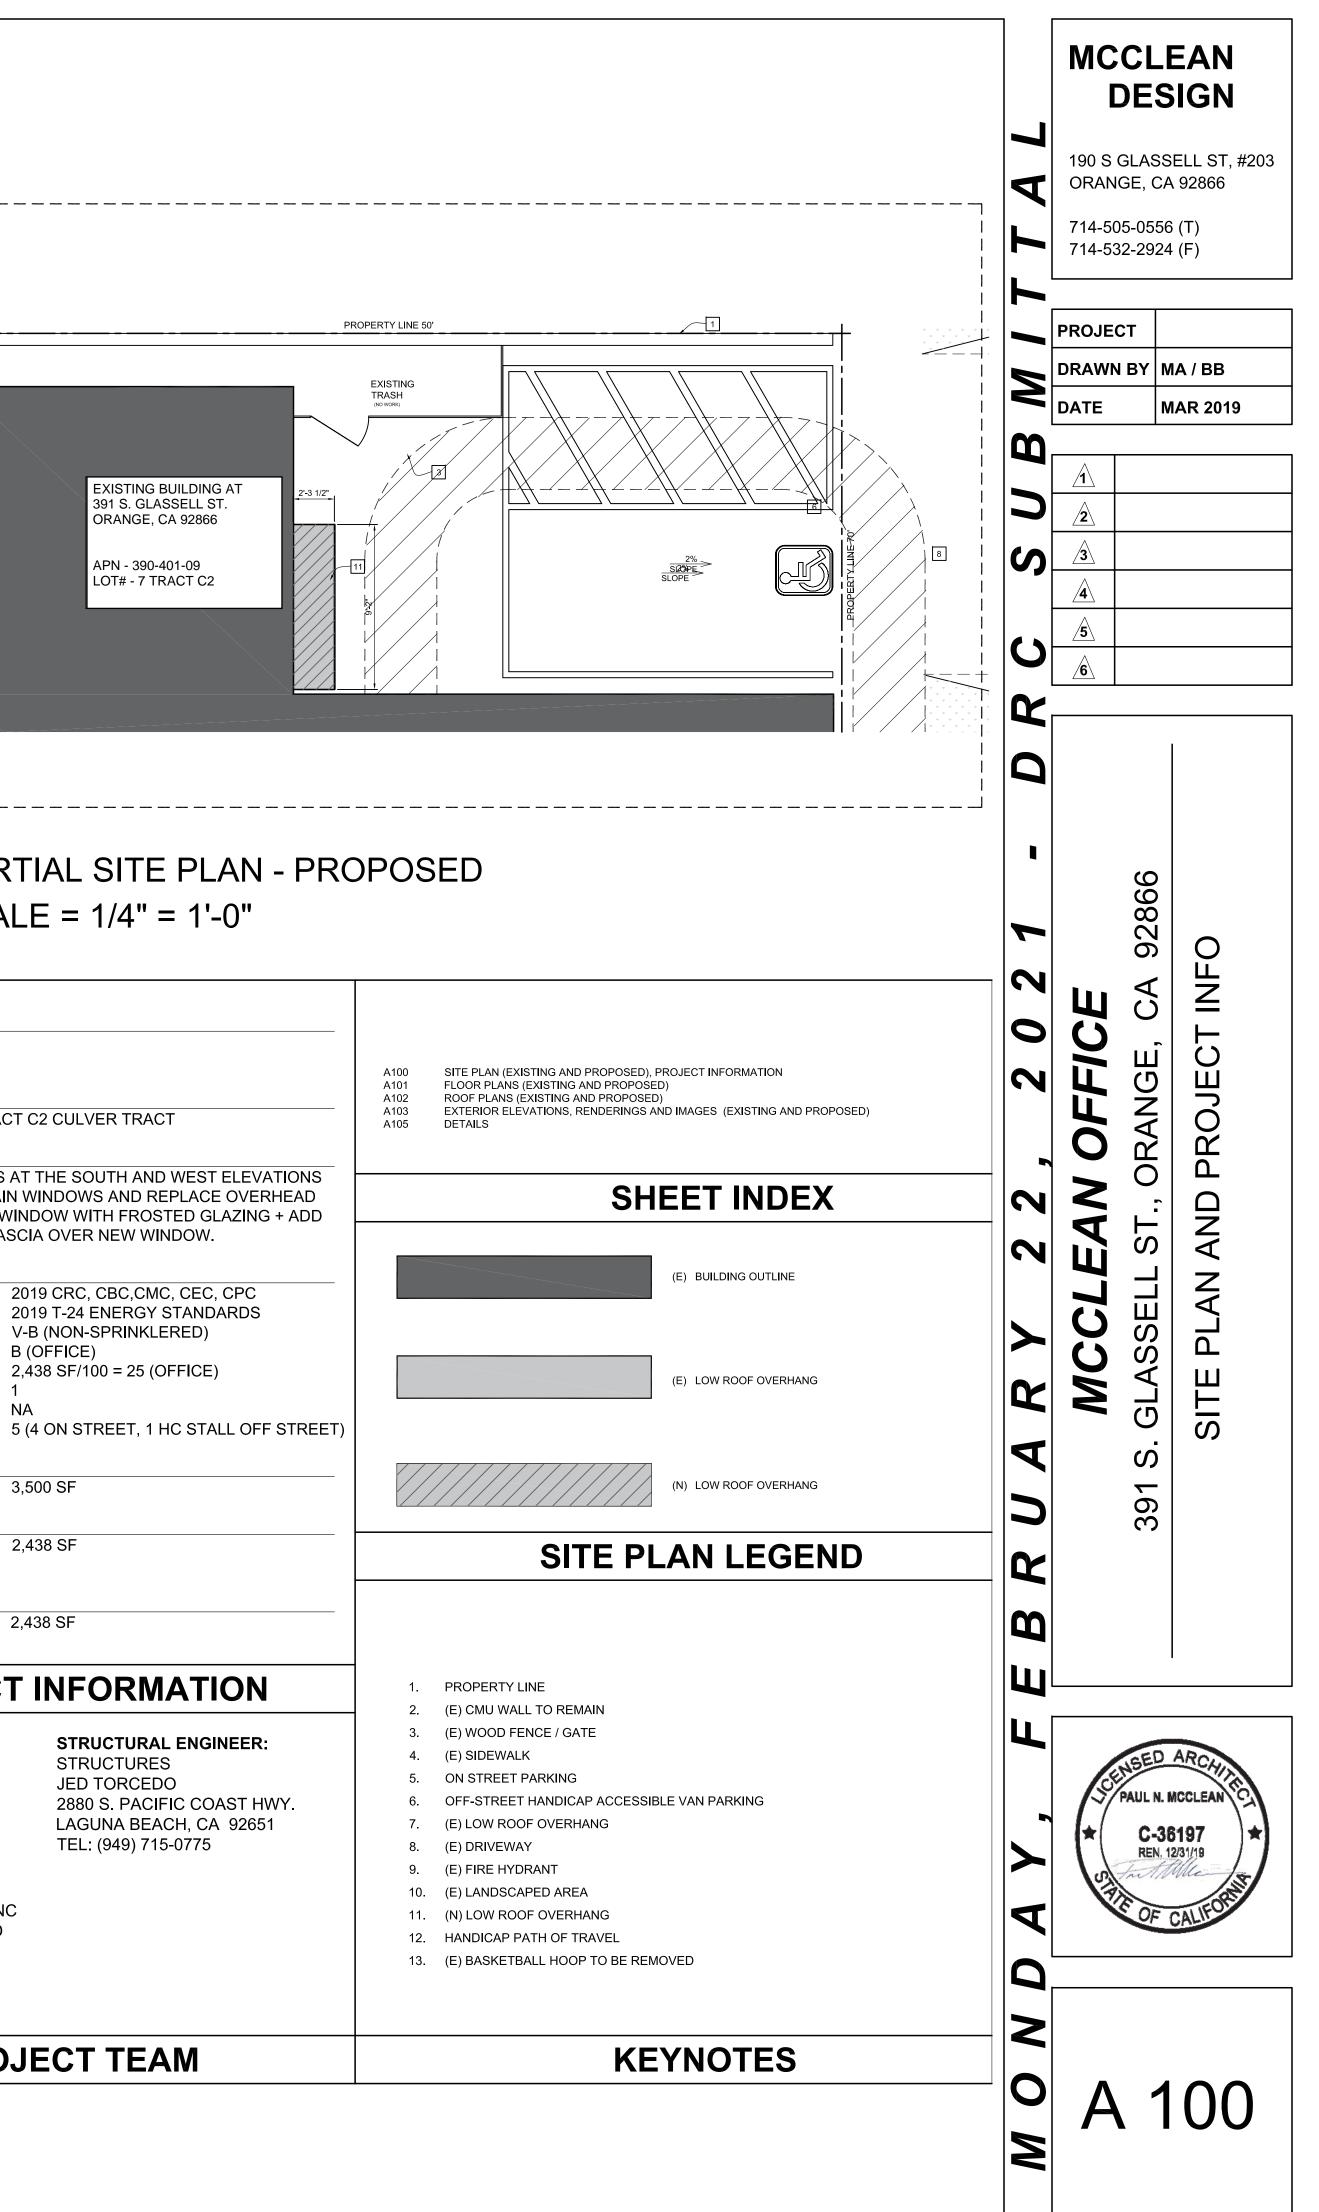


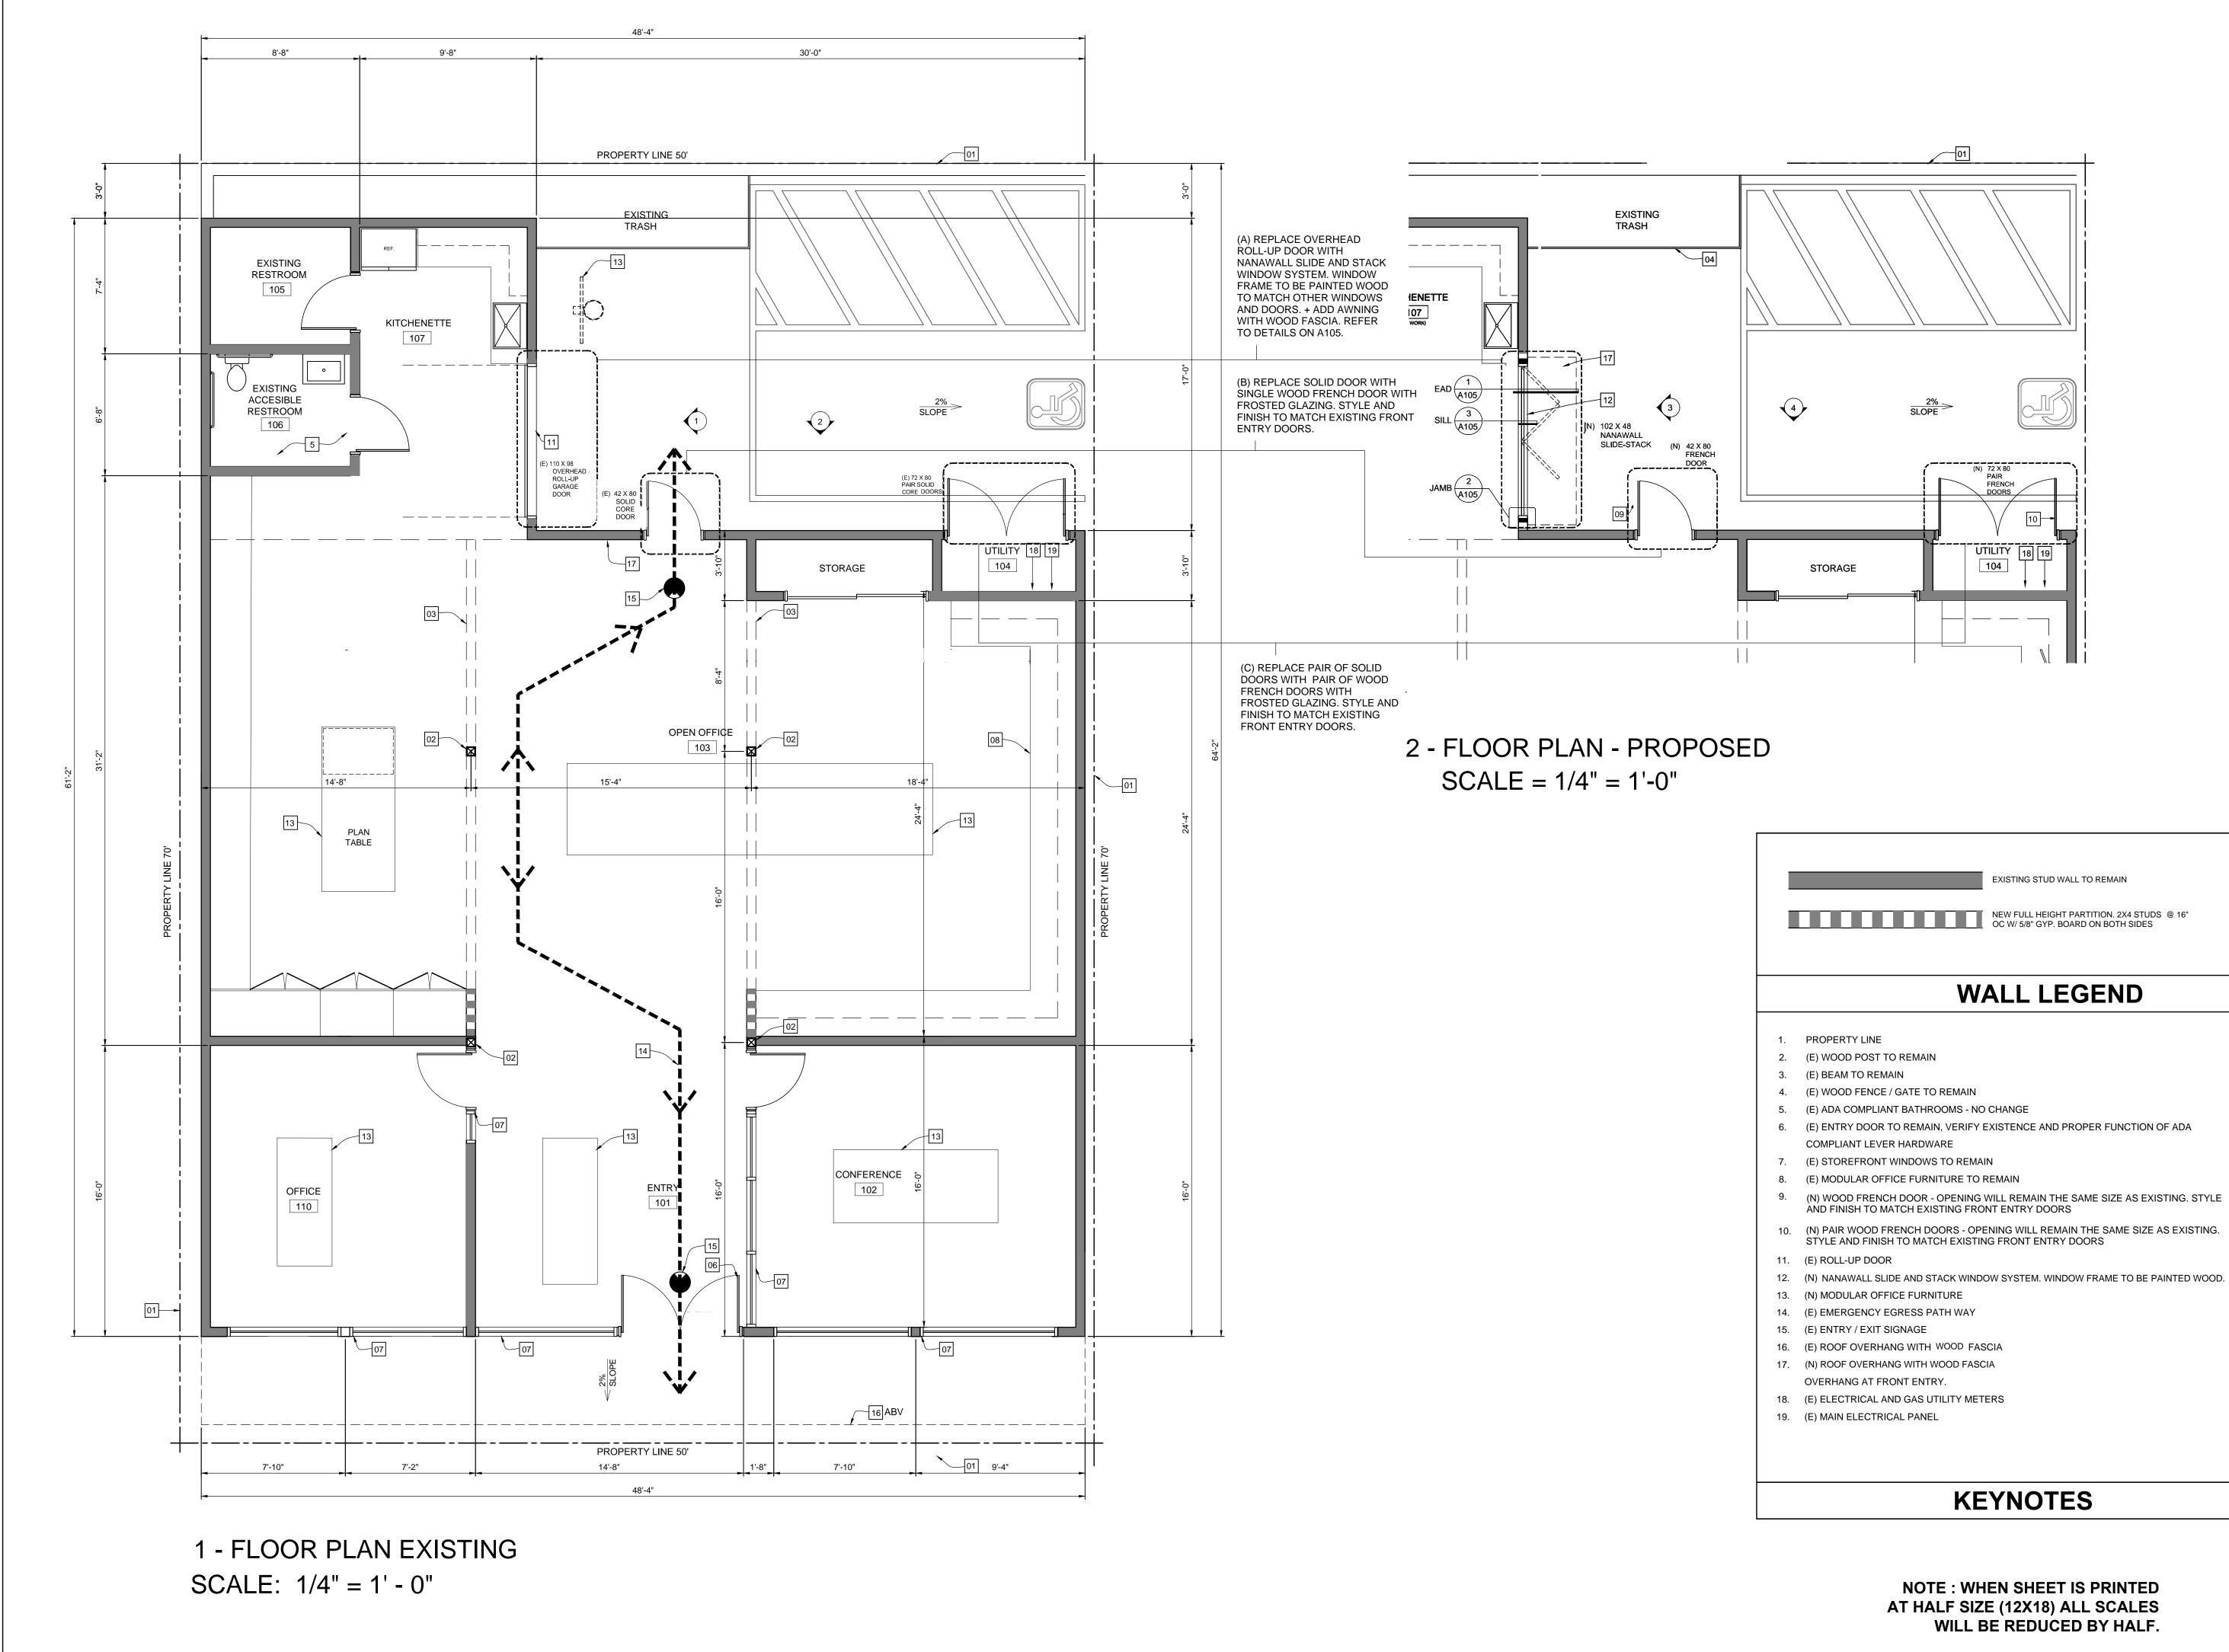MCCLEAN DESIGN 190 S GLASSELL ST, #203 ORANGE, CA 92866 714-505-0556 (T) 714-532-2924 (F) PROJECT DRAWN BY MA / BB MAR 2019 Ω /2∖ S ∕5∖ S ∕6∖ R POSED 92866 N RO Ш Ú 0 S Ω AND Ш ORANGE N Ц Ц 0 **TING** Ζ N XIS. Г М S ш Ш S S AN C S 2 Ц GL OR 1 S FLO 391 $\mathbf{\Omega}$ Ш Ц PAUL N. MCCLEAN C-36197 REN. 12/31/19 J Ζ 0 A 101 Z



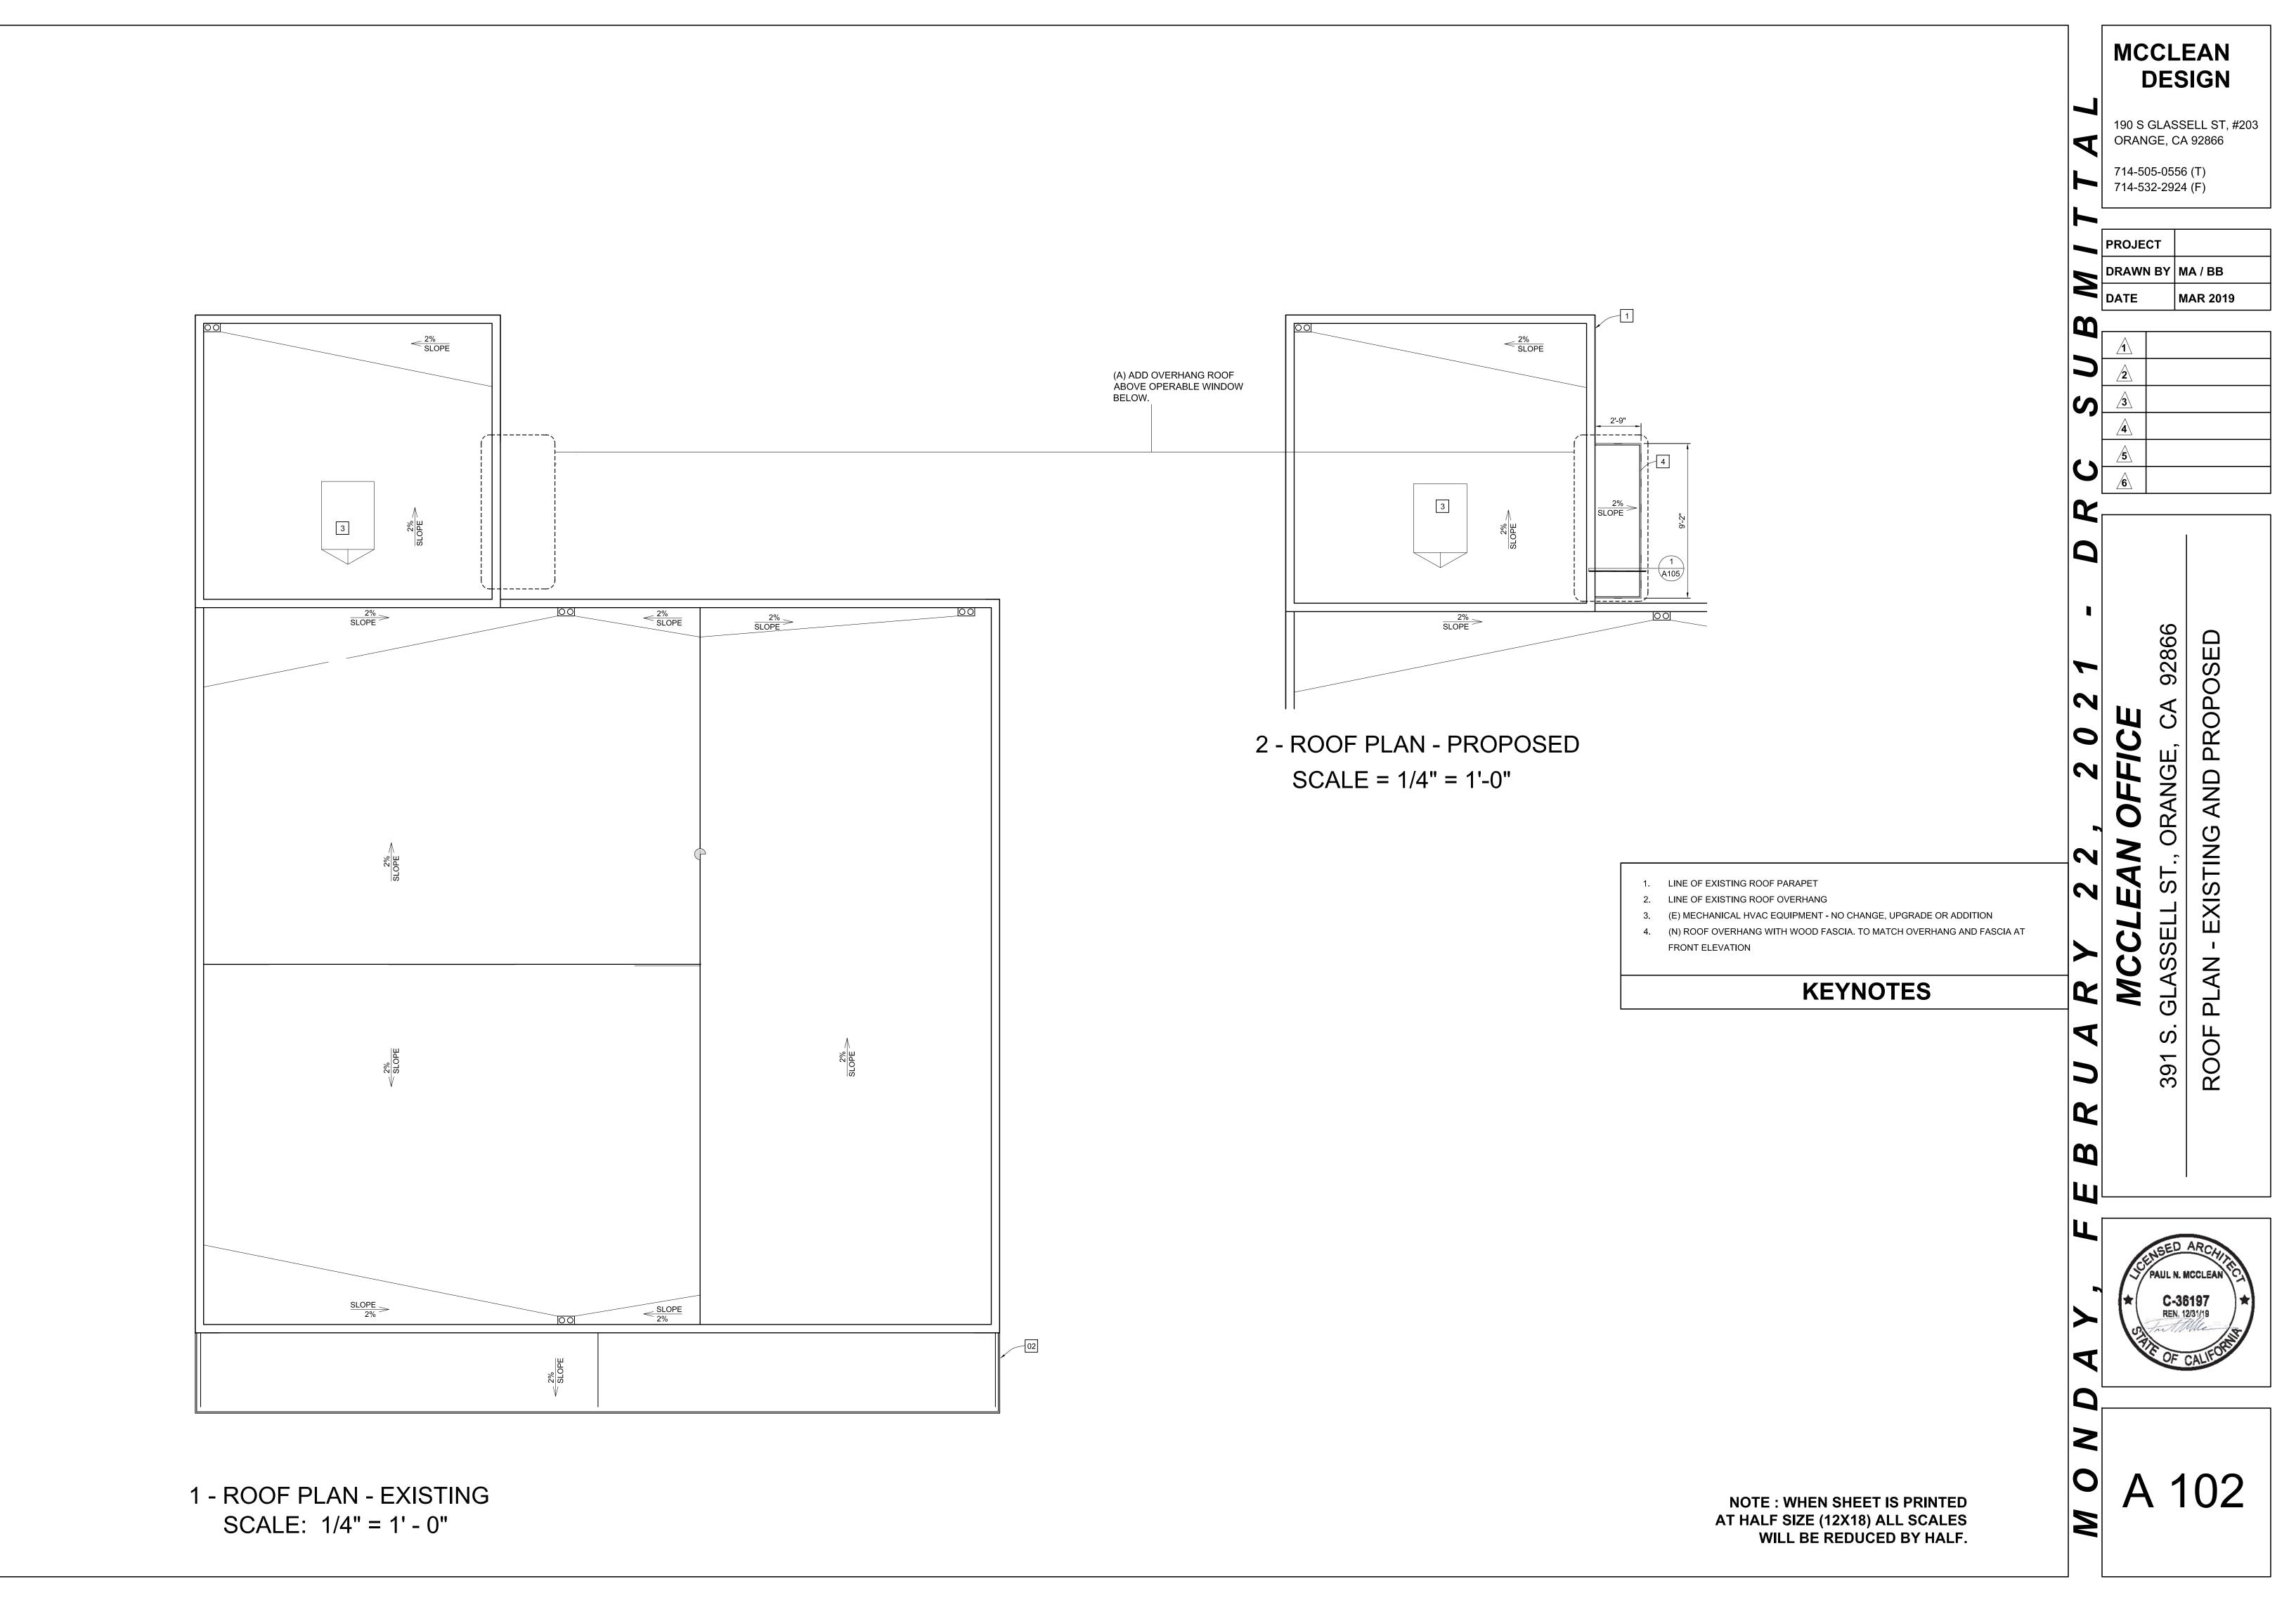

3 - PARTIAL SOUTH ELEVATION - PROPOSED SCALE: 1/4" = 1' - 0"

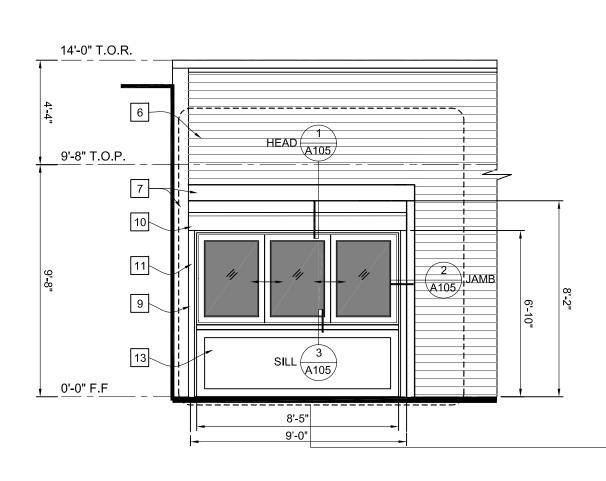


4 - PARTIAL EAST ELEVATION - PROPOSED SCALE: 1/4" = 1' - 0"



6 - REAR PERSPECTIVE - PROPOSED


(C) REPLACE PAIR OF SOLID DOORS WITH PAIR OF WOOD FRENCH DOORS WITH FROSTED GLAZING. STYLE AND FINISH TO MATCH EXISTING FRONT ENTRY DOORS.

-2'-9"

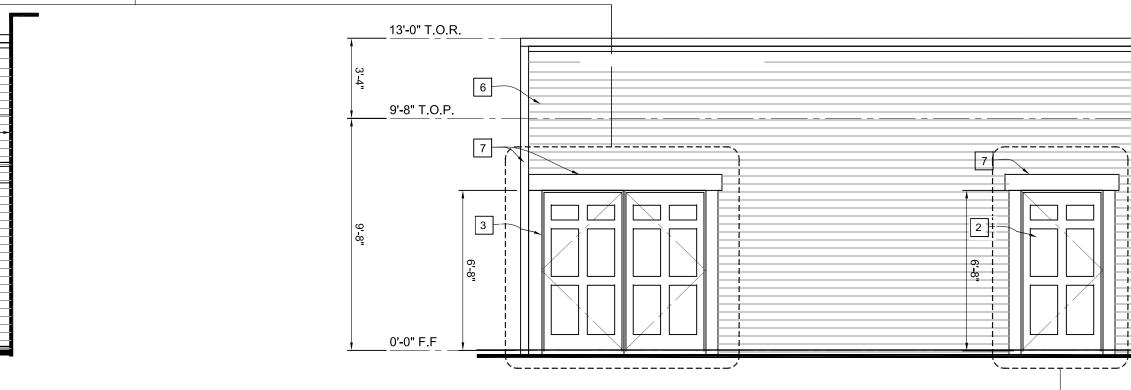

(B) REPLACE SOLID DOOR WITH SINGLE WOOD FRENCH DOOR WITH FROSTED GLAZING. STYLE AND FINISH TO MATCH EXISTING FRONT ENTRY DOORS.

1 - PARTIAL SOUTH ELEVATION - EXISTI SCALE = 1/4" = 1'-0"

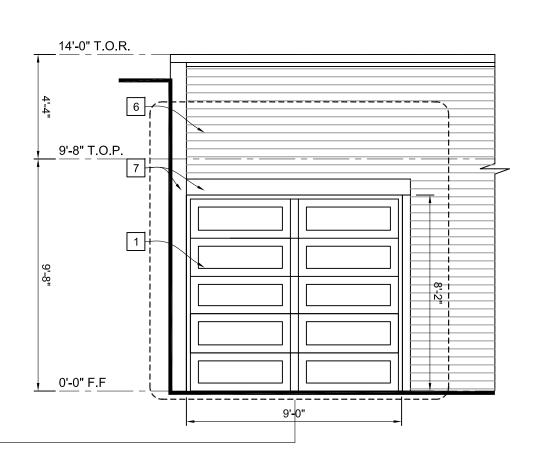


2 - PARTIAL EAST ELEVATION - EXIST SCALE: 1/4" = 1' - 0"



5 - REAR PERSPECTIVE - EXISTING

(A) REPLACE OVERHEAD ROLL-UP DOOR WITH NANAWALL SLIDE AND STACK WINDOW SYSTEM. WINDOW FRAME TO BE PAINTED WOOD TO MATCH OTHER WINDOWS AND DOORS. + ADD AWNING WITH WOOD FASCIA. REFER TO DETAILS ON A105.

		MCCLEAN DESIGN 190 S GLASSELL ST, #203 ORANGE, CA 92866	
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		714-505-05 714-532-25	
		PROJECT	
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		0 1 0	- 12
 (E) ROLL-UP DOOR (E) EXIT DOOR - SOLID (E) UTILITY OF COST DATE DOODD - COLUD 		50	, XTE
 3. (E) UTILITY CLOSET PAIR DOORS - SOLID 4. (N) WOOD FRENCH DOOR - STYLE AND FINISH TO MATCH EXISTING FRONT ENTRY DOORS 			Ш
5. (N) PAIR WOOD FRENCH DOORS - OPENING WILL REMAIN THE SAME SIZE AS EXISTING. STYLE AND FINISH TO MATCH EXISTING FRONT ENTRY DOORS	0		
 6. (E) PAINTED WOOD SIDING TO REMAIN IN PLACE. 7. (E) PAINTED WOOD TRIM TO REMAIN IN PLACE. 	Ш		
 8. (N) PAINTED WOOD SIDING TO MATCH EXISTING. 9. (N) PAINTED WOOD TRIM TO MATCH EXISTING. 10. (N) POOP OVERHANC WITH WOOD FASCIA TO MATCH OVERHANC AND FASCIA AT 	L	C.F.	DARCAN
 10. (N) ROOF OVERHANG WITH WOOD FASCIA. TO MATCH OVERHANG AND FASCIA AT FRONT ELEVATION 11. (N) NANAWALL SLIDE AND STACK WINDOW SYSTEM. WINDOW FRAME TO BE PAINTED WOOD. 		SCENDE SCENDE	N. MCCLEAN
12. (N) WOOD PANEL WITH 1X5 TRIM BOARD.		× C	-36197 ★
		State	to the state
KEYNOTES			F CALI
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	0	Δ	103
NOTE : WHEN SHEET IS PRINTED AT HALF SIZE (12X18) ALL SCALES WILL BE REDUCED BY HALF.	N	/ \	

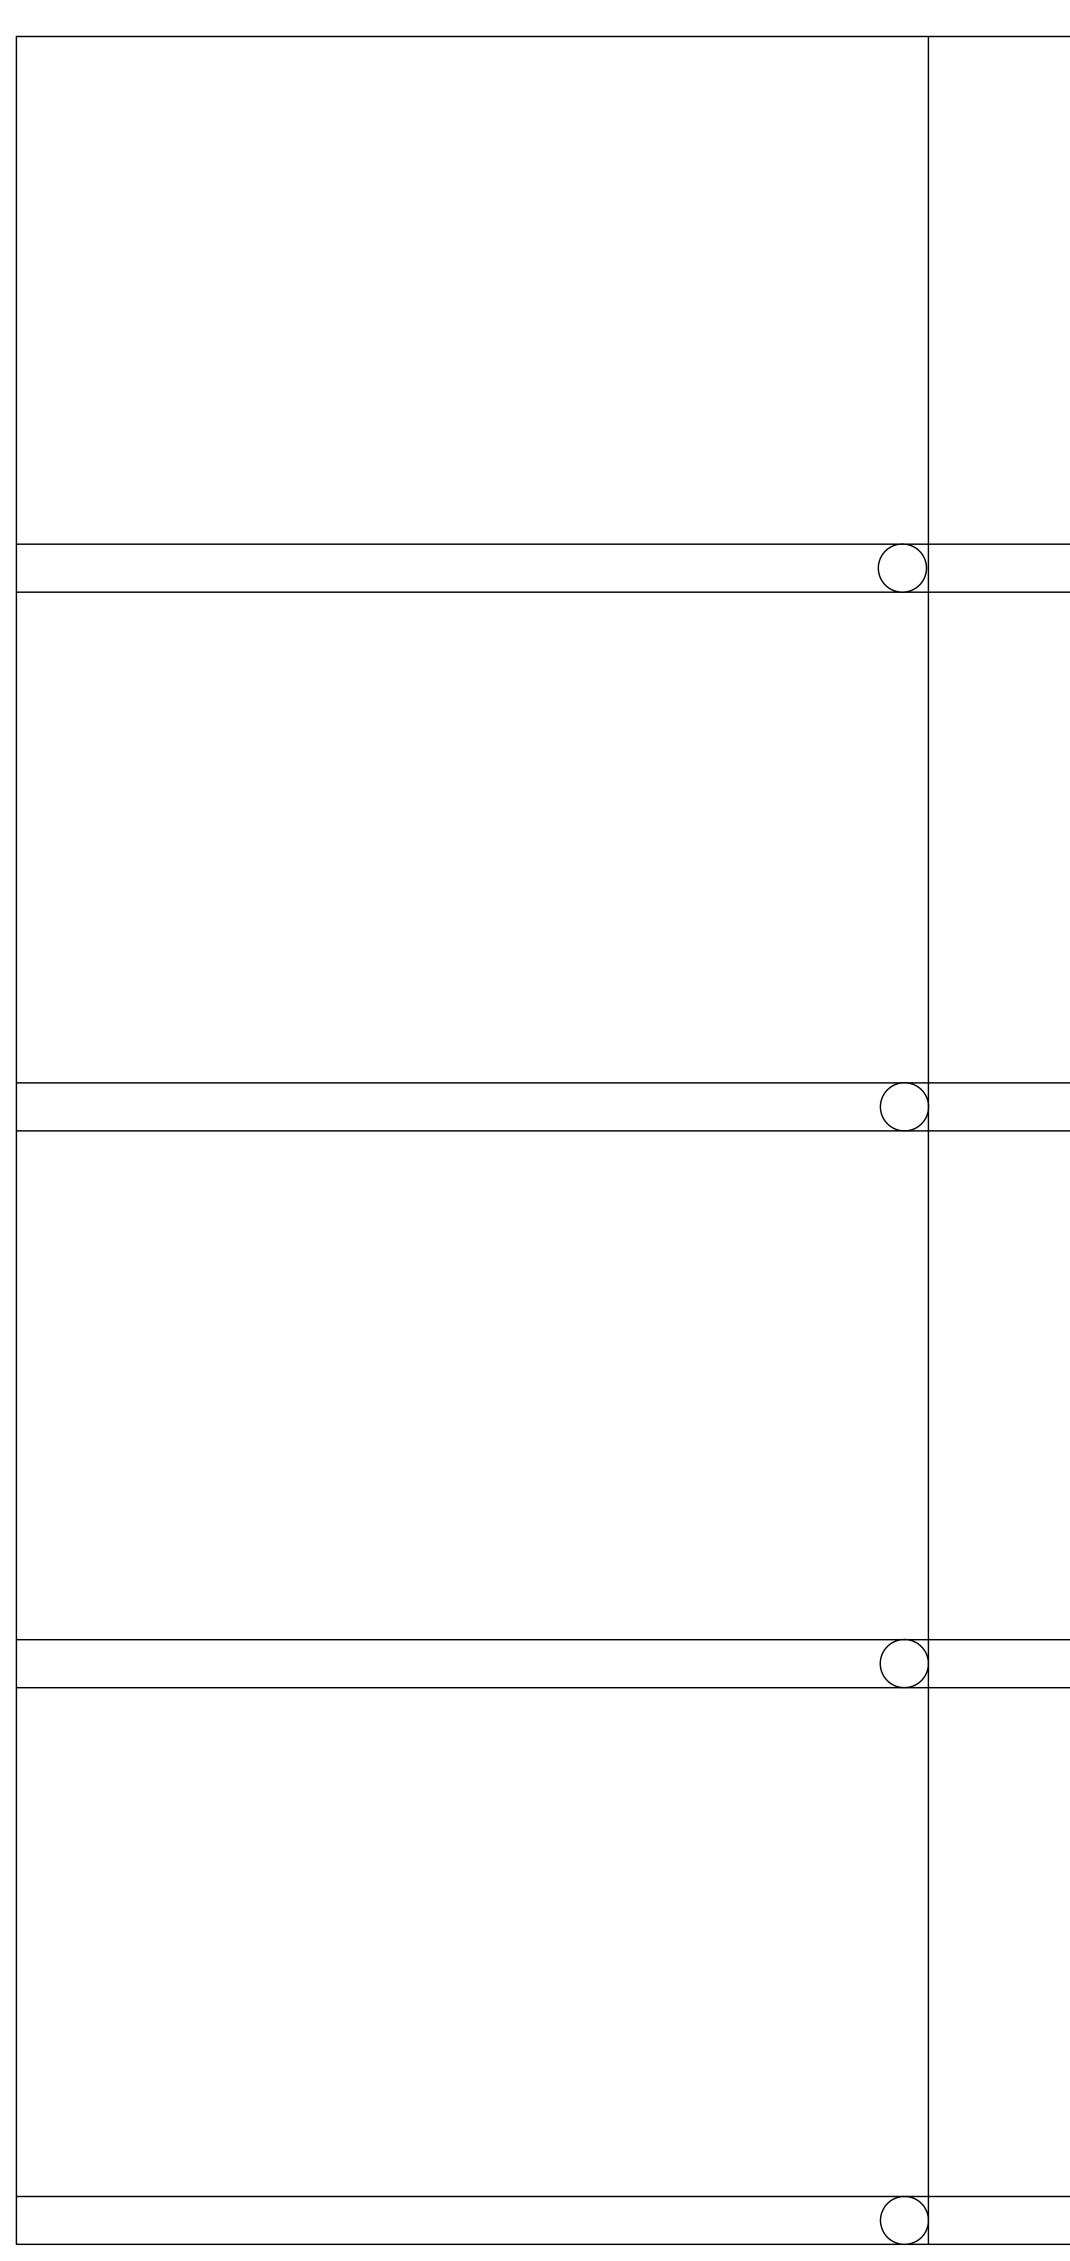

NANAWALL WD-65 SLID
AND STACK WINDON SYSTEN
(N) 1X WOOD SIL
(N) 1X5 WOOD TRI
(N) 1/2 WOOD PANE
PLYWOOD SHEATHIN
WINDOW JAMB DETAI
(E)WOOD LAP S TO RI
(E)1X4 WOOD TRIM B TO RE (N)1X1 WOOD TRIM B
(N) MOIST STOP CONTINUOUS BITUTI FLAS
(N) NANAWALL WE SLIDE AND STACK WIN SY
WINDOW JAMB DETAI
BUILT UP ROOFING PER
PLYWOOD
N) METAL DRIP PANEL TO MATCH
MATCH
(N) 1X8 WOOD FASCIA
WINDOW HEAD / ROO

