



16327 Willowmist Ct. Chino Hills, Ca 91709

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SHEET INDEX GEN. NOTES & **PROJECT**

/11/18 PRELIMINARY REVIEW 7/10/18 FIRE DEPT. REVIEW 9/12/18 LAND USE REVIEW 11/15/18 Planning Corrections 08/30/19 Planning Corrections 10/01/19 Planning Corrections 10/29/19 PLANNING CORRECTIONS 03/12/20 SMART CORRECTIONS 04/23/20 SMART CORRECTIONS 02/19/21 SMART CORRECTIONS 04/08/21 SMART CORRECTIONS 05/27/21 SMART CORRECTIONS



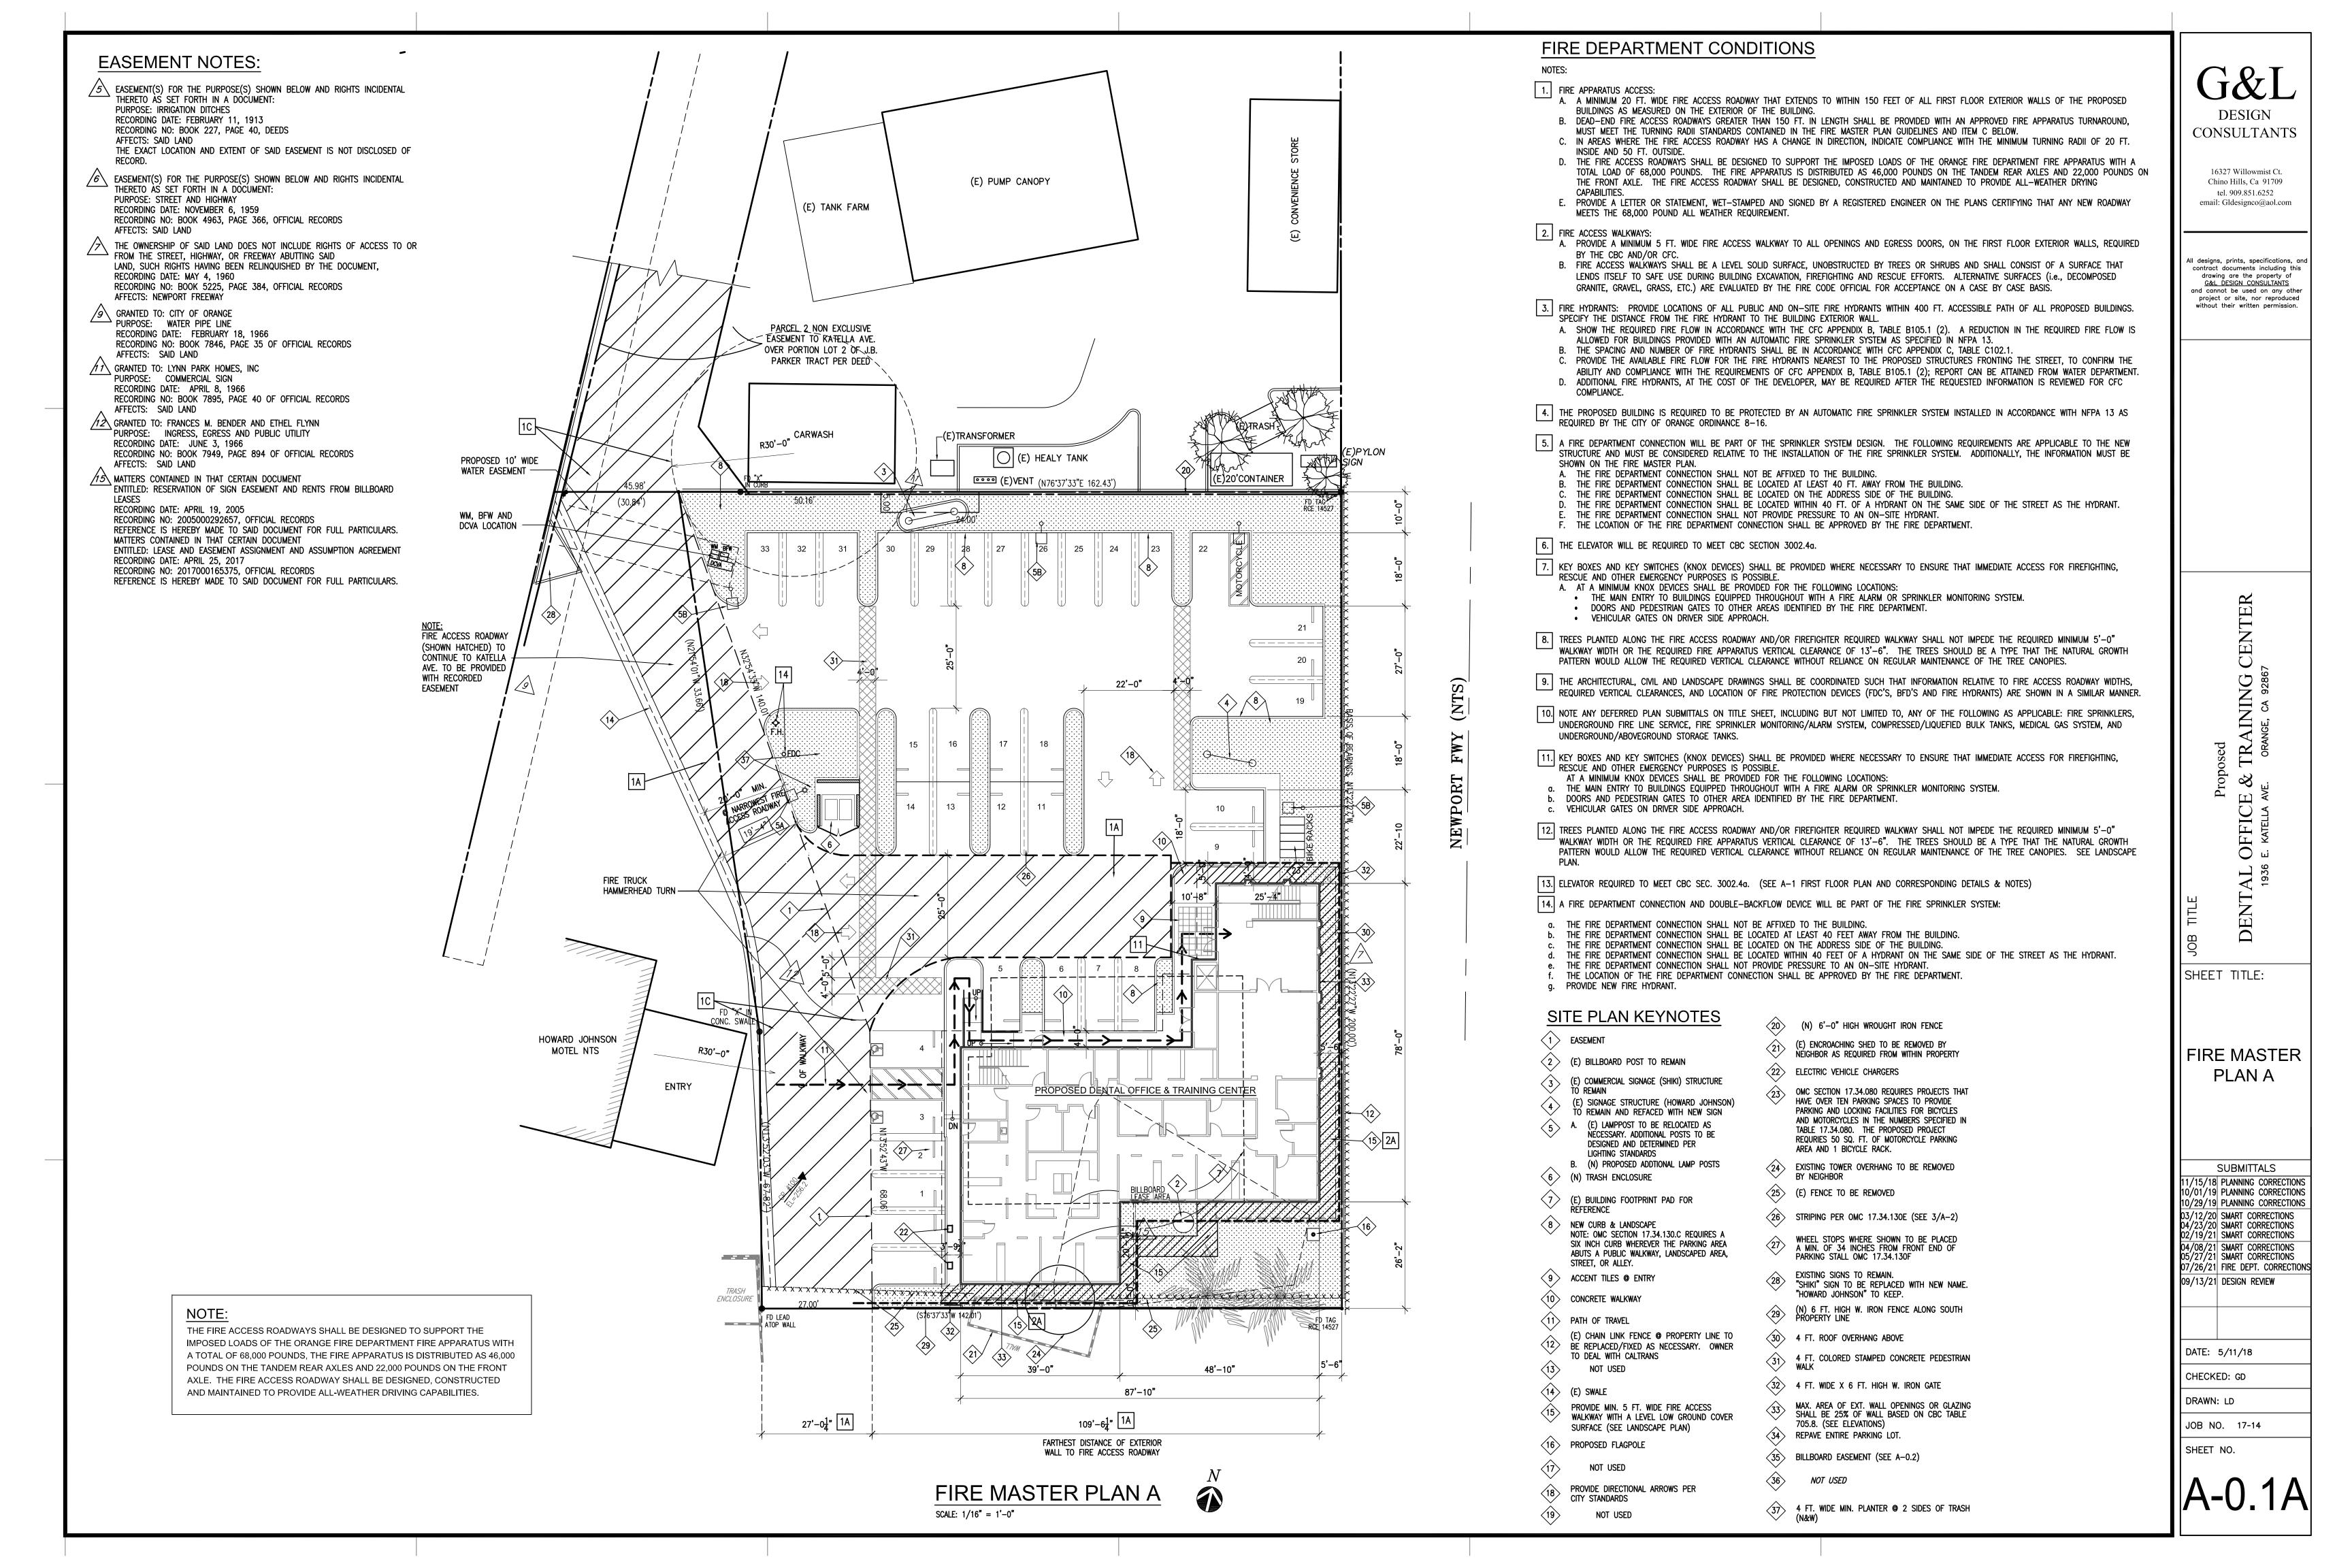

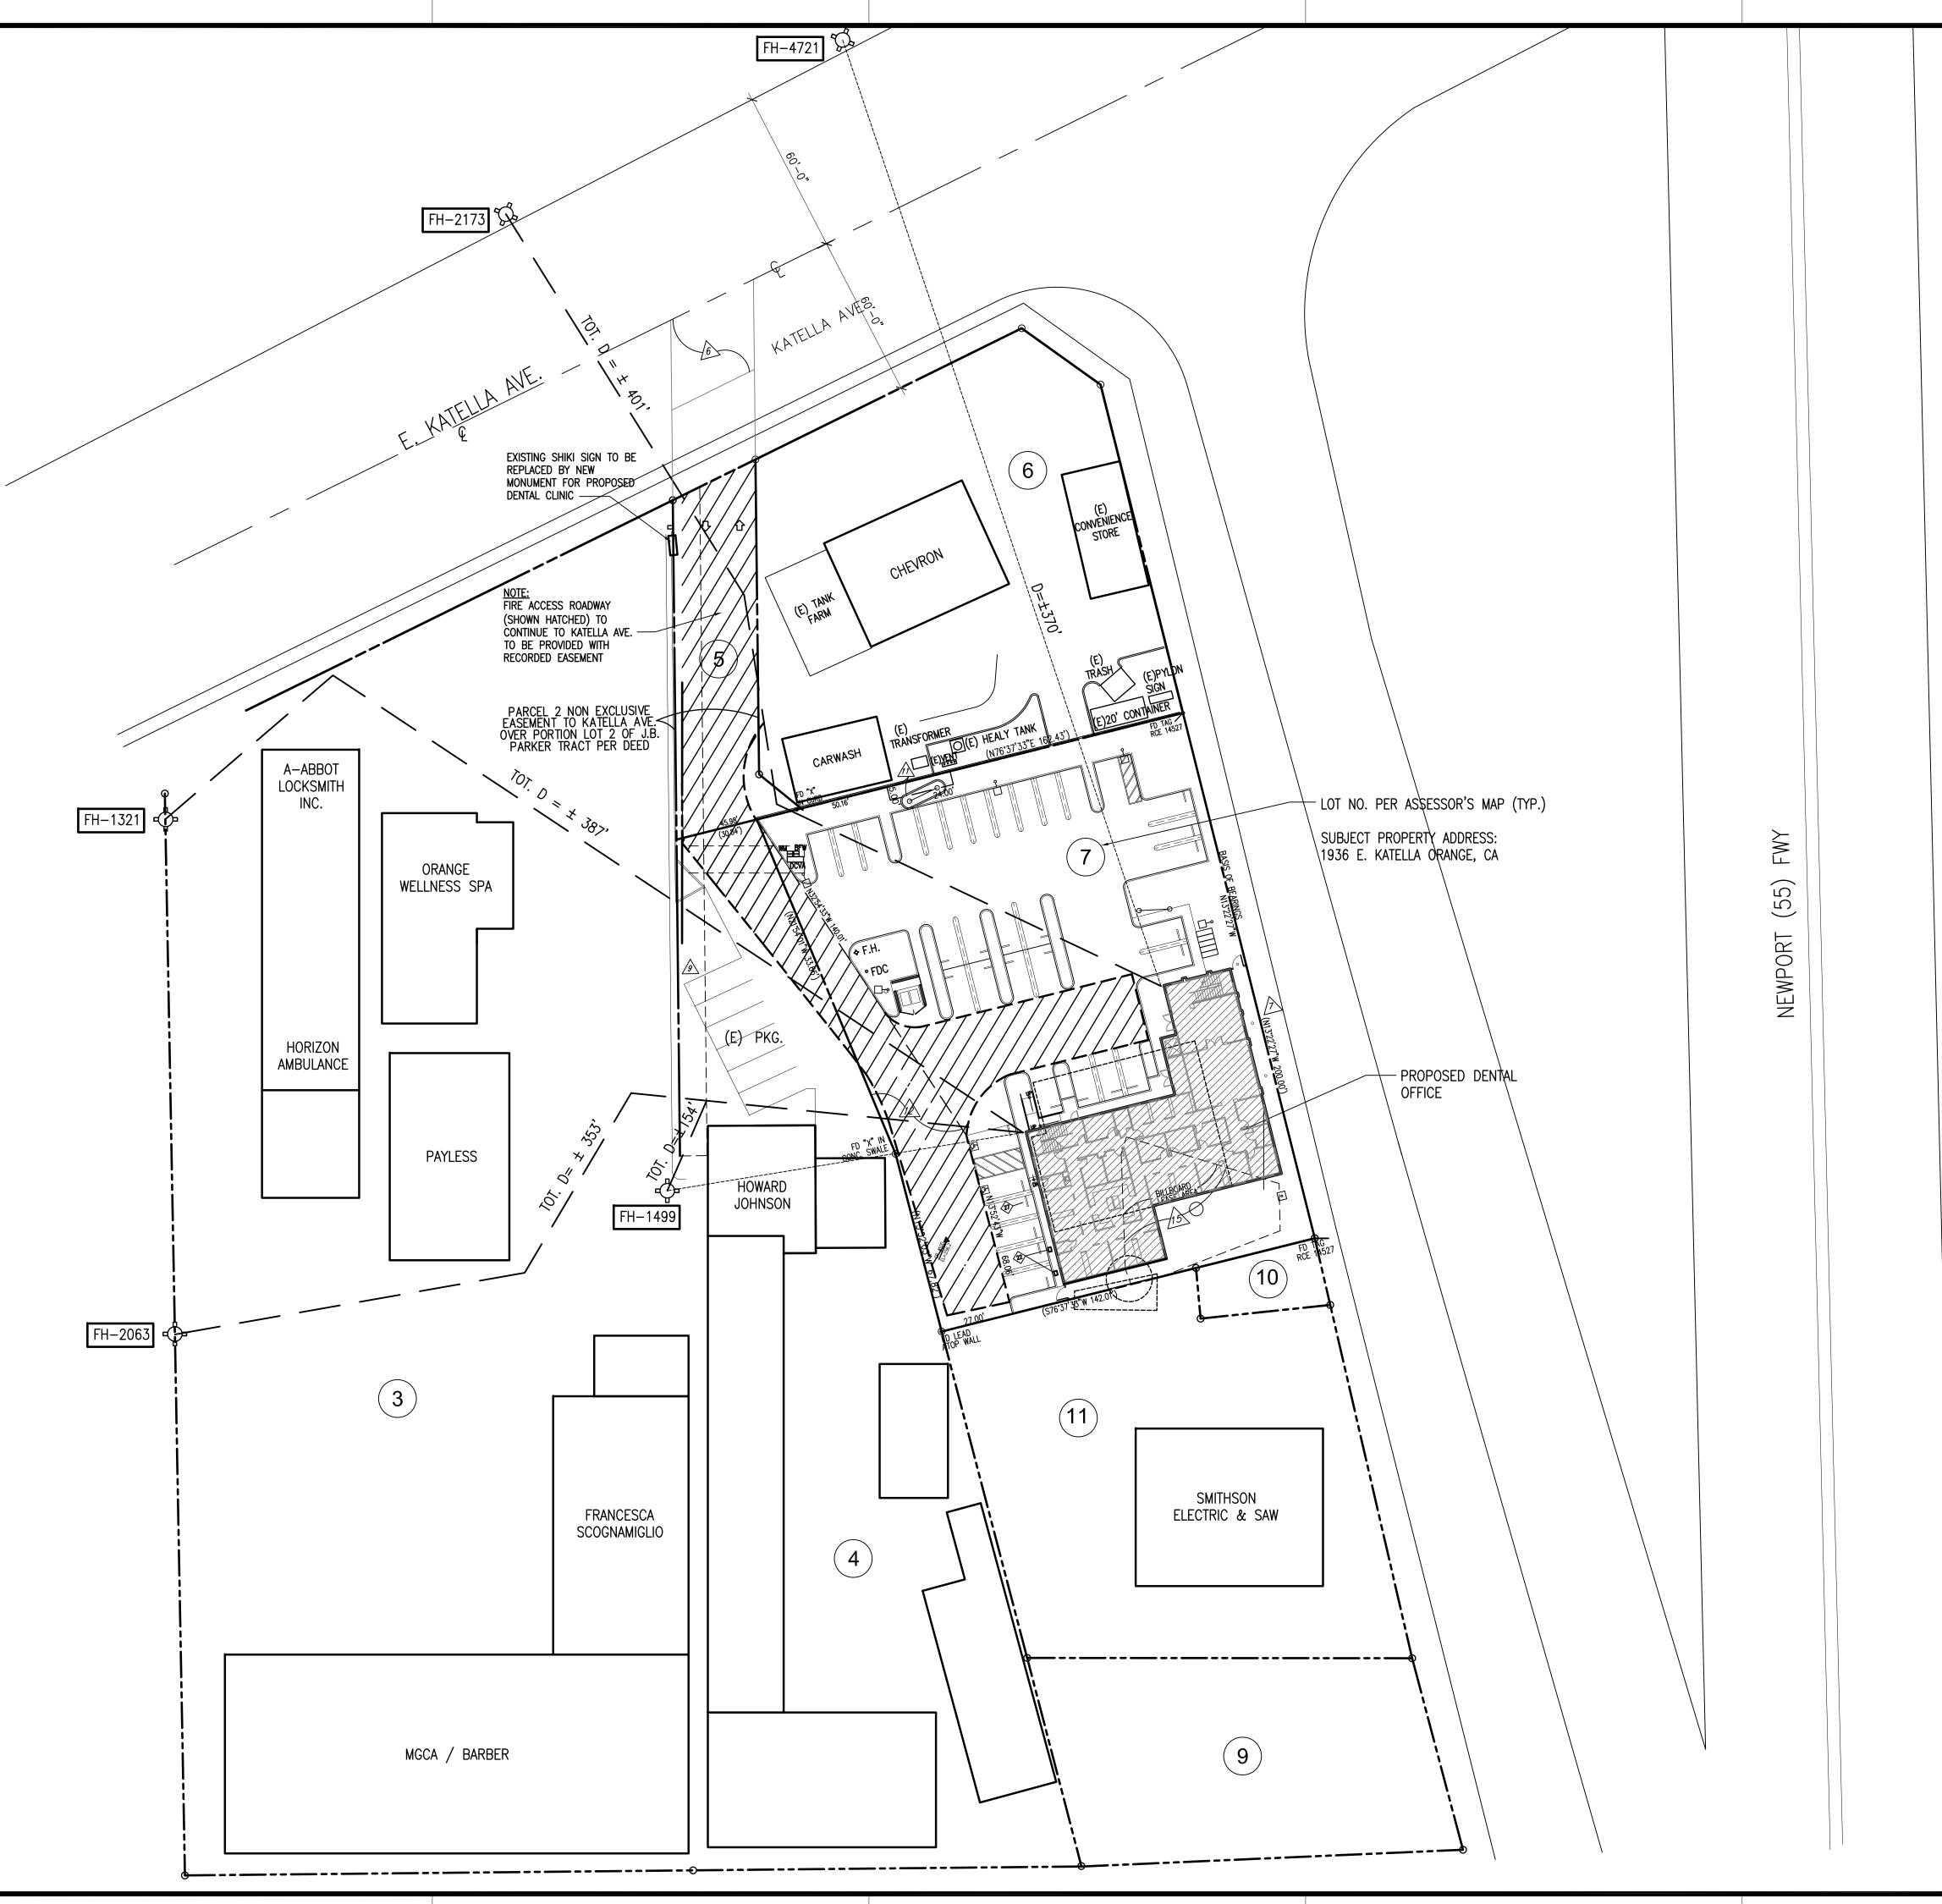FIRE HYDRANT (FH) FLOW CHART

Hydrant #	Test Performed (Month-YY)	Static Pressure (PSI)	Residual Pressure (PSI)	Observed Flow (GPM)	Flow at 20 PSI (GPM)	Time Flush (Min)	Actual Gallon
1321	Jan-2019	64	56	1257.196882	3156.451696	1	1257.197
1499	Jan-2019	52	50	1187.939392	5309.077616	1	1187.939
2063	Jan-2019	65	58	1279.449882	3494.66133	1	1279.45
2173	Jan-2019	52	50	1187.939392	5309.077616	1	1187.939
4721	Jan-2019	50	48	1163.938143	5023.647756	1	1163.938

Junie Vuong, E.I.T. | Assistant Engineer City of Orange - Public Works, Water Division 189 S Water St | Orange, CA 92866 Email: JVuong@CityofOrange.org

FIRE DEPT. NOTES

- 1. THE REQUIRED FIRE FLOW SHALL BE IN ACCORDANCE WITH THE CFC APPENDIX B, TABLE B105.1 (2). A REDUCTION IN THE REQUIRED FIRE FLOW IS ALLOWED FOR BUILDINGS PROVIDED WITH AN AUTOMATIC FIRE SPRINKLER SYSTEM AS SPECIFIED IN NFPA 13.
- 2. THE SPACING AND NUMBER OF FIRE HYDRANTS SHALL BE IN ACCORDANCE WITH CFC APPENDIX C, TABLE C102.1.
- 3. ADDITIONAL FIRE HYDRANTS, AT THE COST OF THE DEVELOPER, MAY BE REQUIRED UPON REVIEW FOR CFC COMPLIANCE.

EASEMENT NOTES:

EASEMENT(S) FOR THE PURPOSE(S) SHOWN BELOW AND RIGHTS INCIDENTAL THERETO AS SET FORTH IN A DOCUMENT: PURPOSE: IRRIGATION DITCHES RECORDING DATE: FEBRUARY 11, 1913 RECORDING NO: BOOK 227, PAGE 40, DEEDS AFFECTS: SAID LAND THE EXACT LOCATION AND EXTENT OF SAID EASEMENT IS NOT DISCLOSED OF

EASEMENT(S) FOR THE PURPOSE(S) SHOWN BELOW AND RIGHTS INCIDENTAL THERETO AS SET FORTH IN A DOCUMENT: PURPOSE: STREET AND HIGHWAY RECORDING DATE: NOVEMBER 6, 1959 RECORDING NO: BOOK 4963, PAGE 366, OFFICIAL RECORDS AFFECTS: SAID LAND

THE OWNERSHIP OF SAID LAND DOES NOT INCLUDE RIGHTS OF ACCESS TO OR FROM THE STREET, HIGHWAY, OR FREEWAY ABUTTING SAID LAND, SUCH RIGHTS HAVING BEEN RELINQUISHED BY THE DOCUMENT, RECORDING DATE: MAY 4, 1960 RECORDING NO: BOOK 5225, PAGE 384, OFFICIAL RECORDS AFFECTS: NEWPORT FREEWAY

GRANTED TO: CITY OF ORANGE ² PURPOSE: WATER PIPE LINE RECORDING DATE: FEBRUARY 18, 1966 RECORDING NO: BOOK 7846, PAGE 35 OF OFFICIAL RECORDS AFFECTS: SAID LAND

// GRANTED TO: LYNN PARK HOMES, INC PURPOSE: COMMERCIAL SIGN RECORDING DATE: APRIL 8, 1966 RECORDING NO: BOOK 7895, PAGE 40 OF OFFICIAL RECORDS AFFECTS: SAID LAND

GRANTED TO: FRANCES M. BENDER AND ETHEL FLYNN PURPOSE: INGRESS, EGRESS AND PUBLIC UTILITY RECORDING DATE: JUNE 3, 1966 RECORDING NO: BOOK 7949, PAGE 894 OF OFFICIAL RECORDS AFFECTS: SAID LAND

MATTERS CONTAINED IN THAT CERTAIN DOCUMENT ENTITLED: RESERVATION OF SIGN EASEMENT AND RENTS FROM BILLBOARD RECORDING DATE: APRIL 19, 2005 RECORDING NO: 2005000292657, OFFICIAL RECORDS

REFERENCE IS HEREBY MADE TO SAID DOCUMENT FOR FULL PARTICULARS. MATTERS CONTAINED IN THAT CERTAIN DOCUMENT ENTITLED: LEASE AND EASEMENT ASSIGNMENT AND ASSUMPTION AGREEMENT RECORDING DATE: APRIL 25, 2017 RECORDING NO: 2017000165375, OFFICIAL RECORDS REFERENCE IS HEREBY MADE TO SAID DOCUMENT FOR FULL PARTICULARS.



FIRE MASTER PLAN B

SCALE: 1" = 30'-0"

FULL SITE SHOWING NEIGHBORING PARCELS/ **PROPERTIES**

DESIGN

CONSULTANTS

16327 Willowmist Ct. Chino Hills, Ca 91709 tel. 909.851.6252 email: Gldesignco@aol.com

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FIRE MASTER PLAN B

SHEET TITLE:


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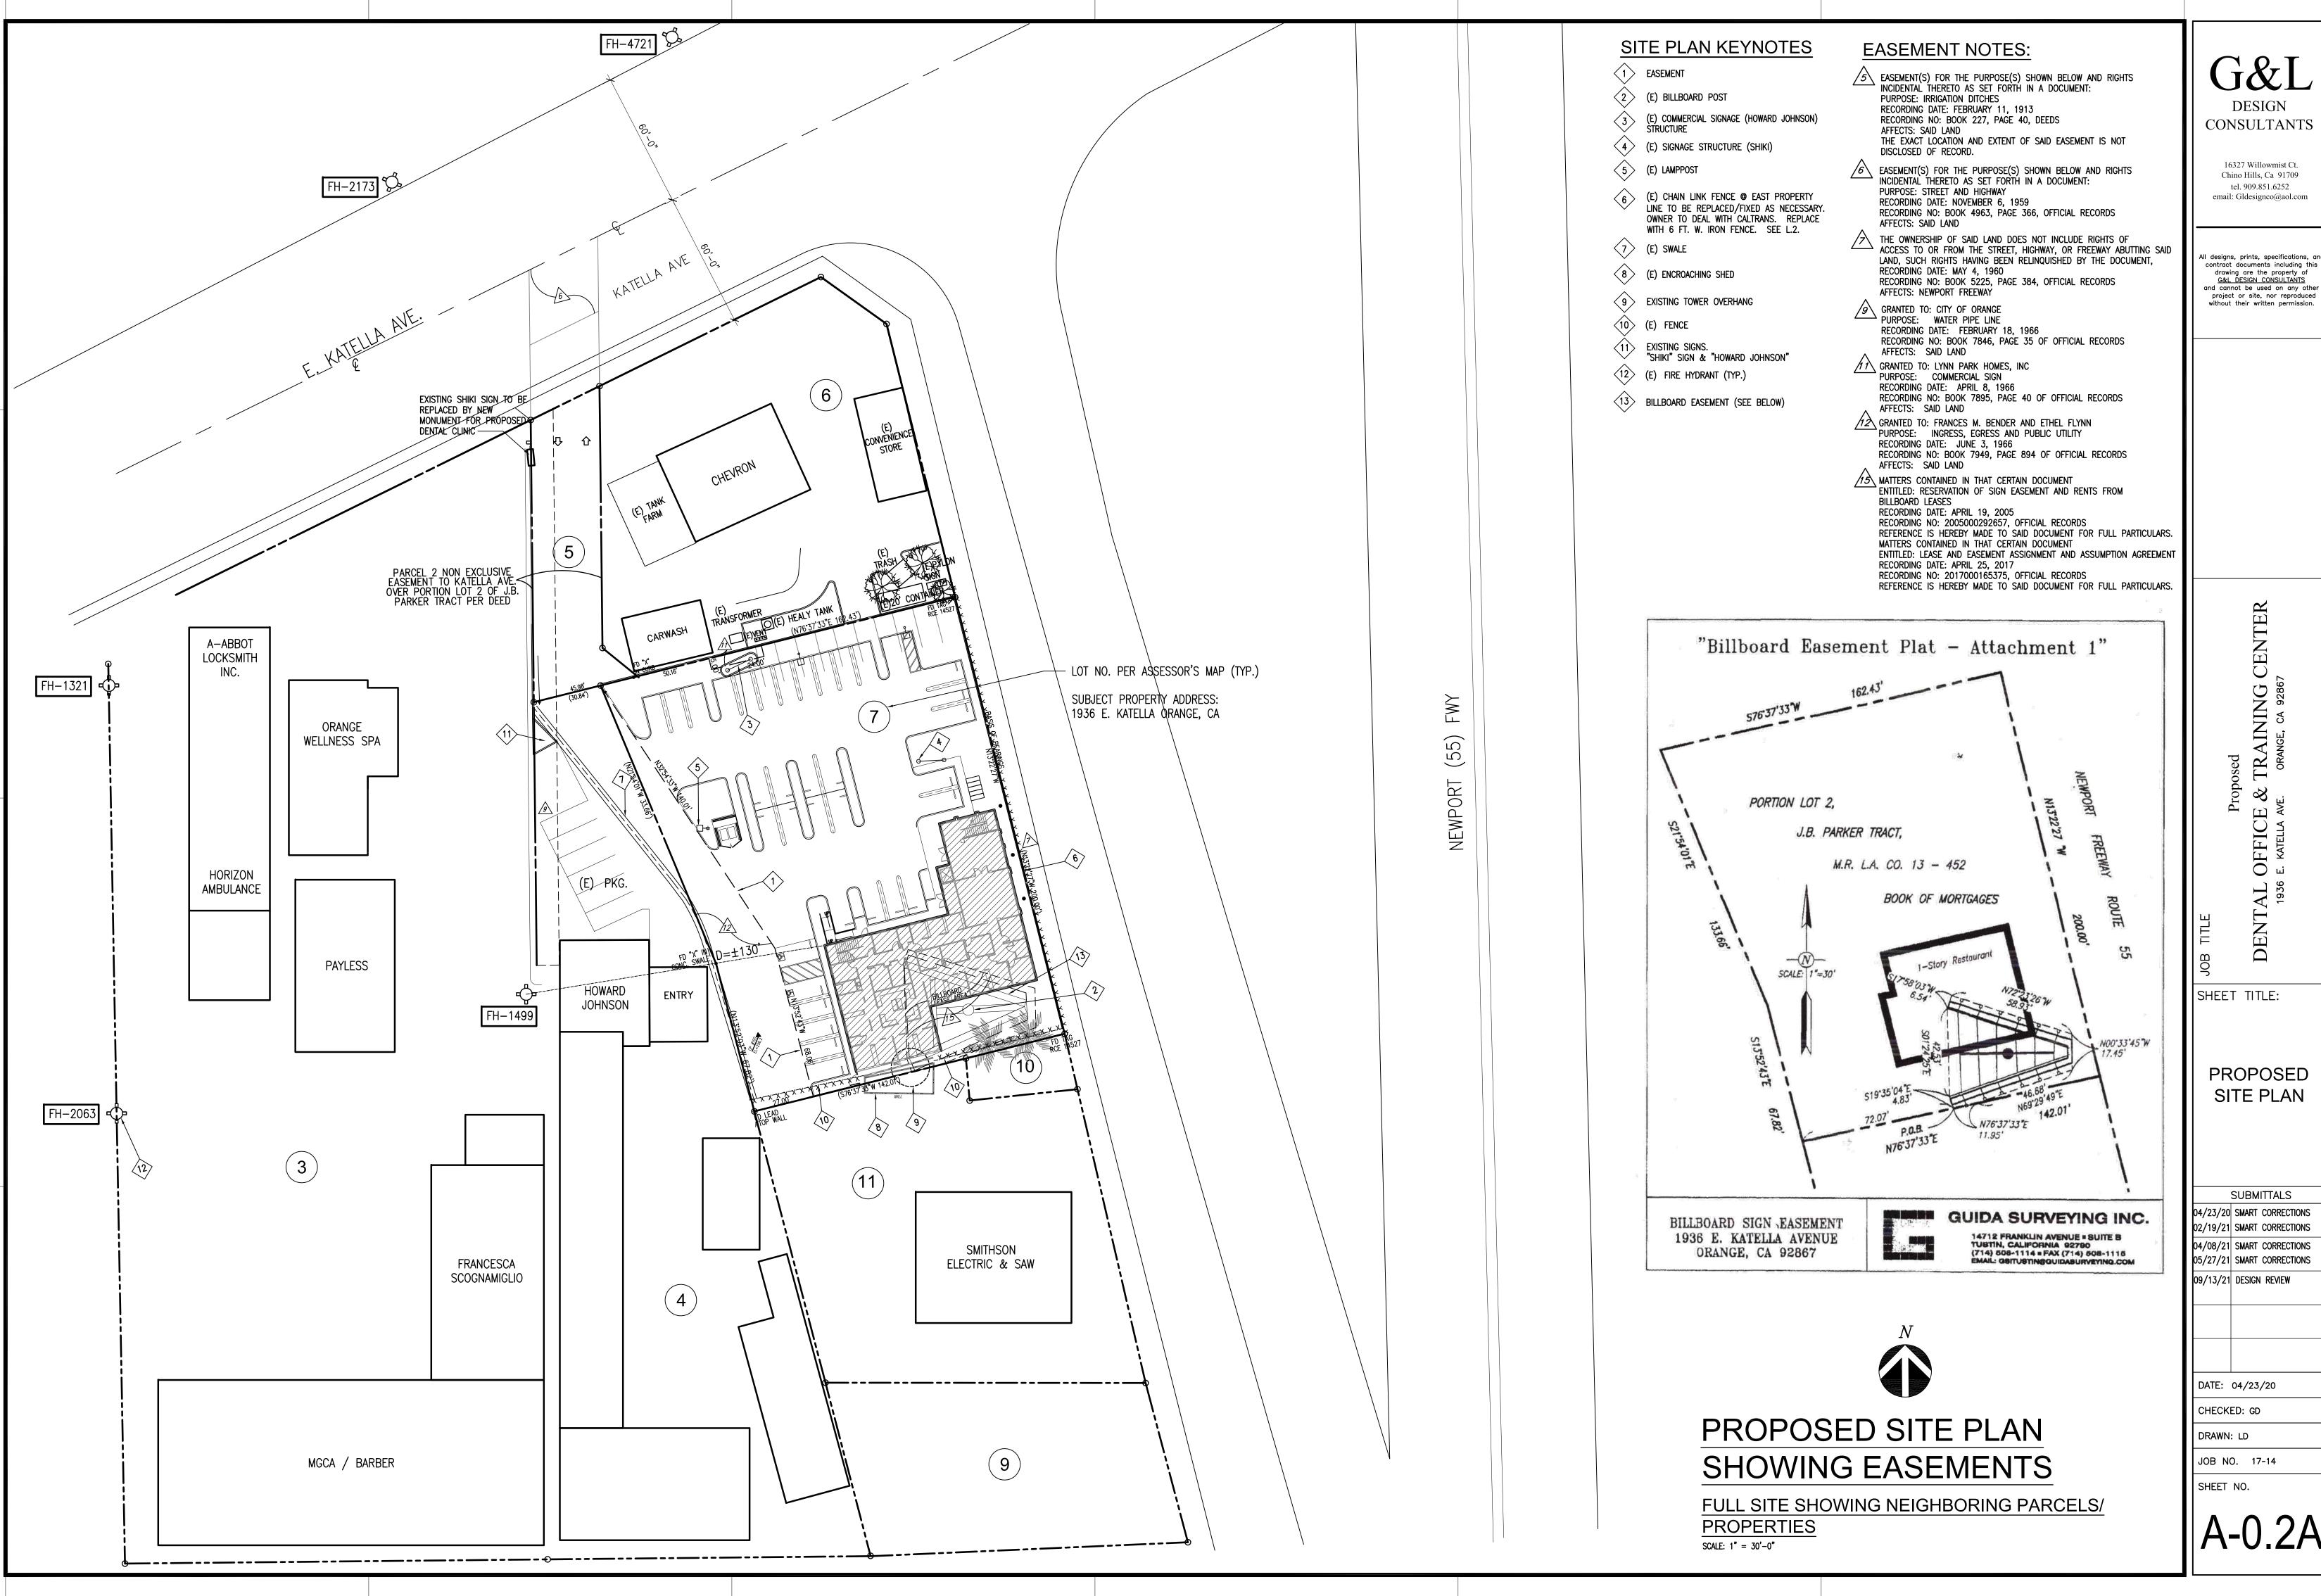
02/19/21 SMART CORRECTIONS 04/08/21 SMART CORRECTIONS 05/27/21 SMART CORRECTIONS 07/26/21 FIRE DEPT. CORRECTIONS 09/13/21 DESIGN REVIEW

DATE: 03/12/20 CHECKED: GD


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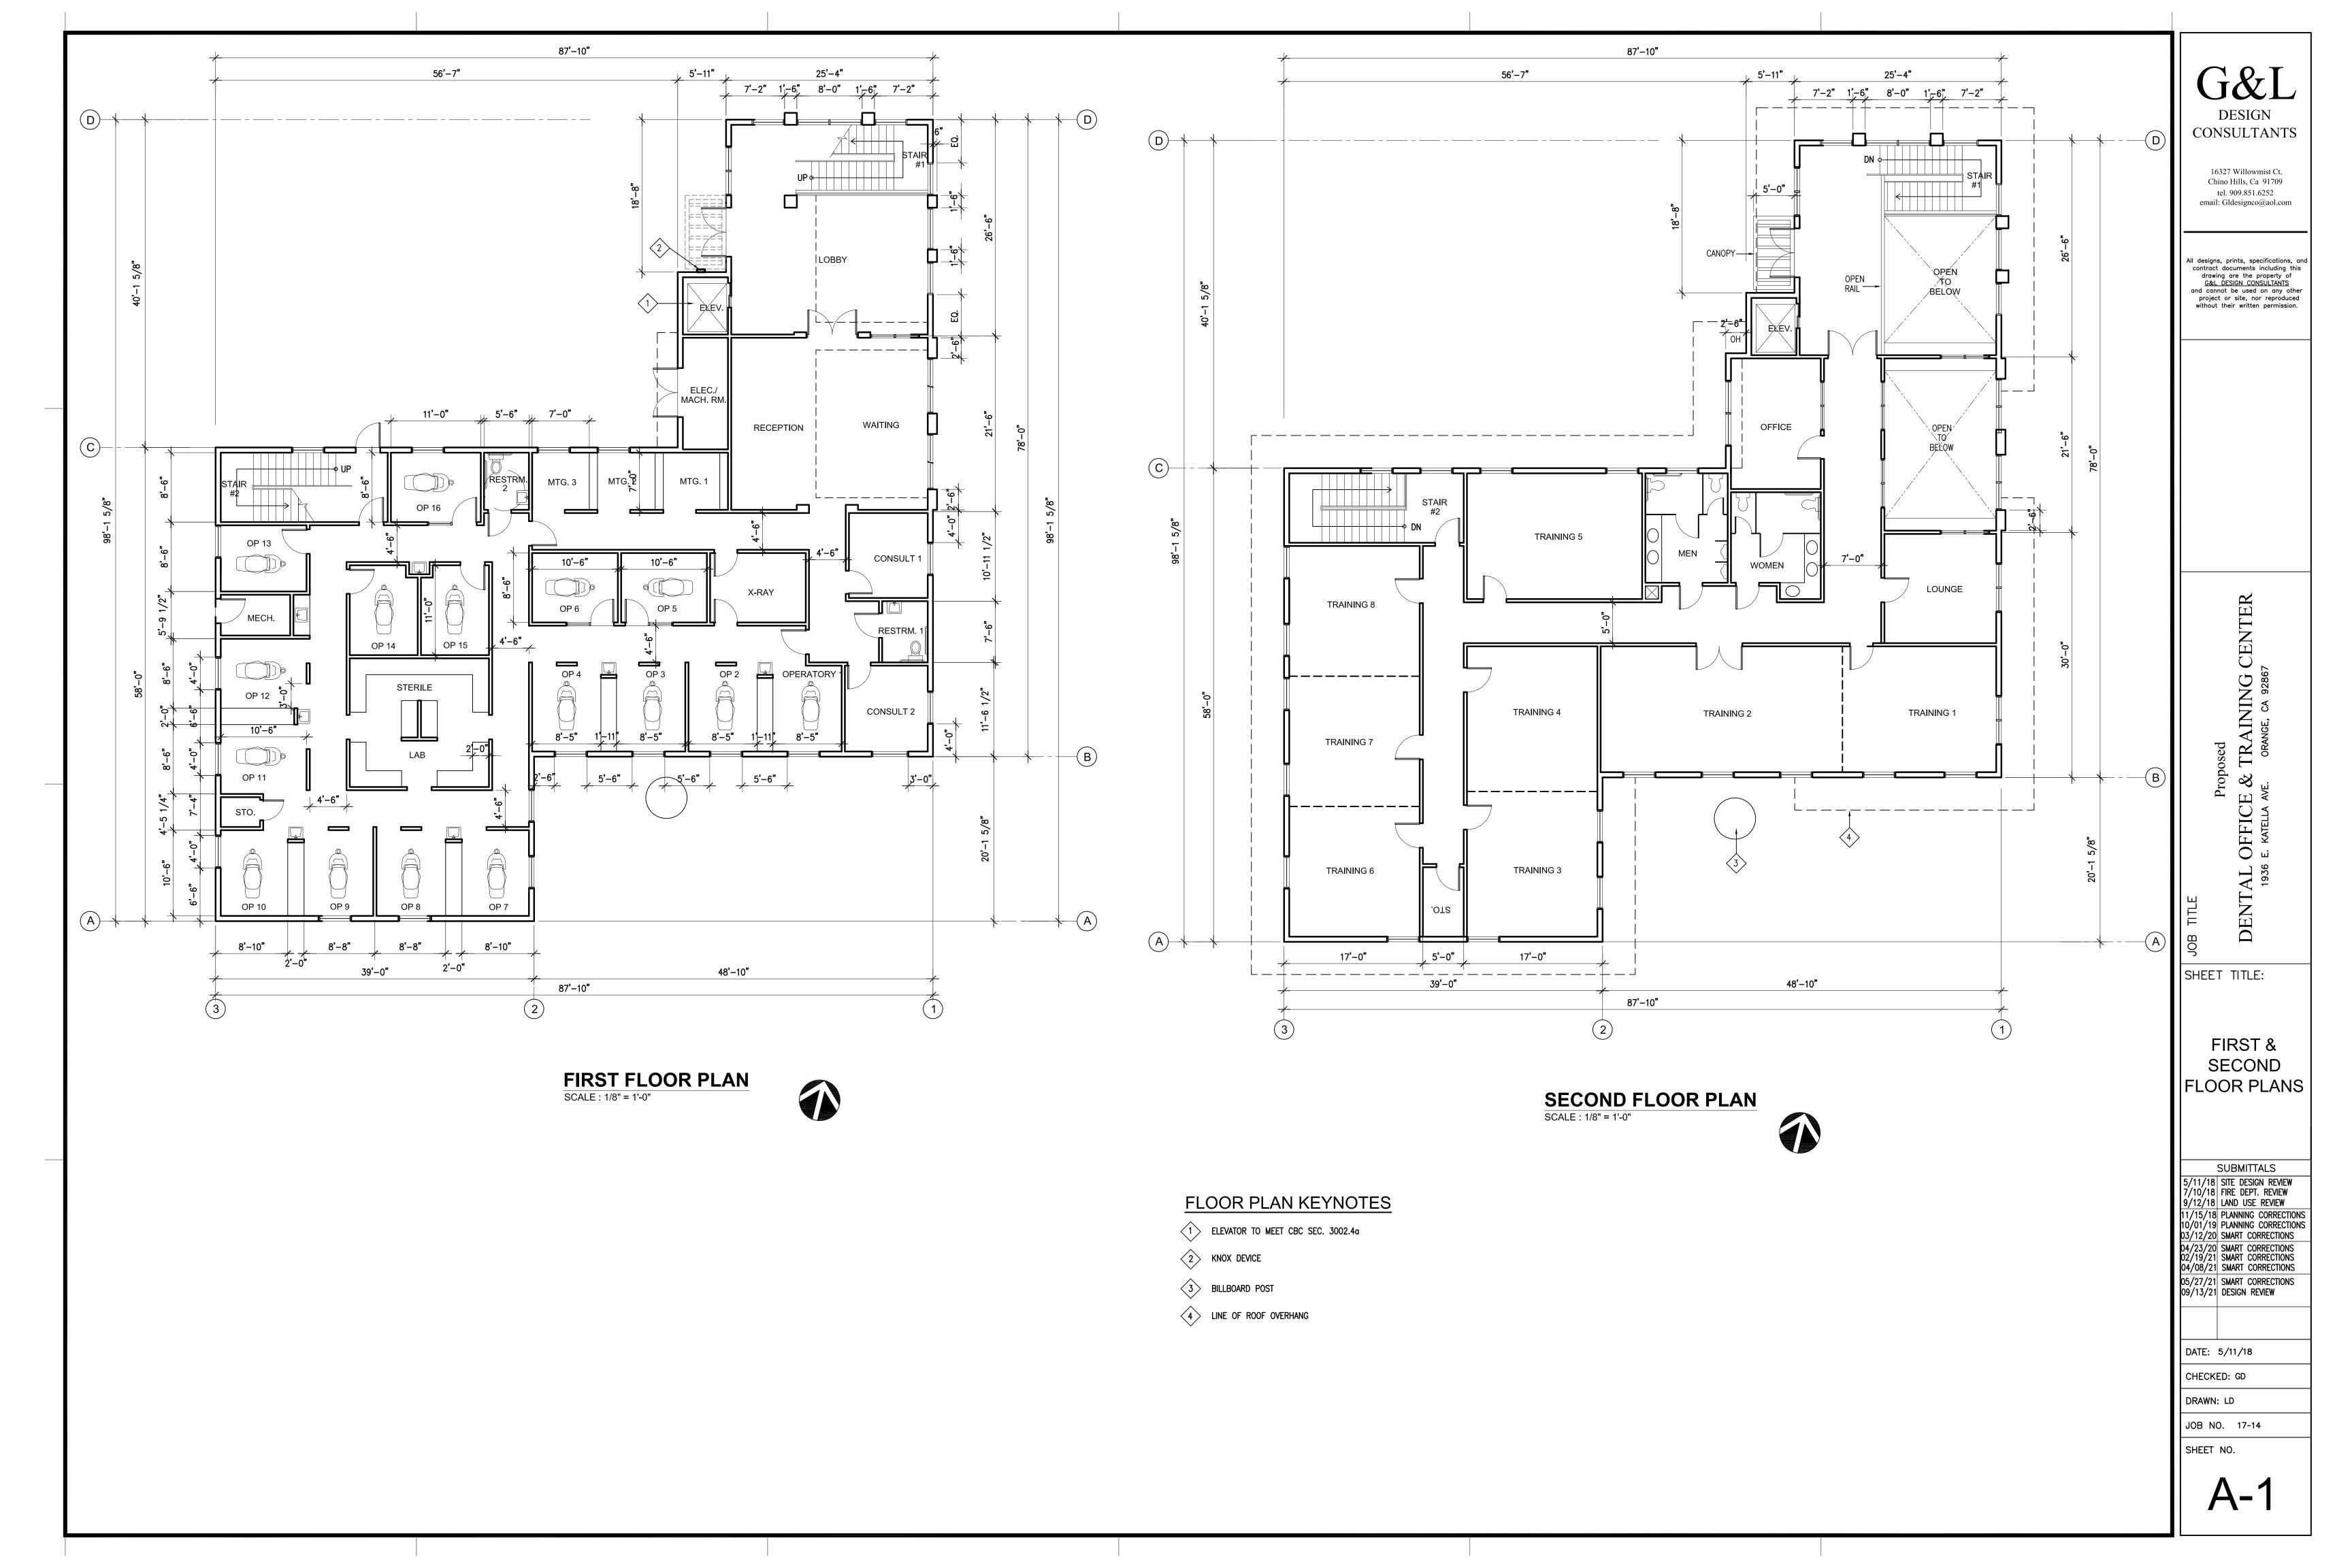
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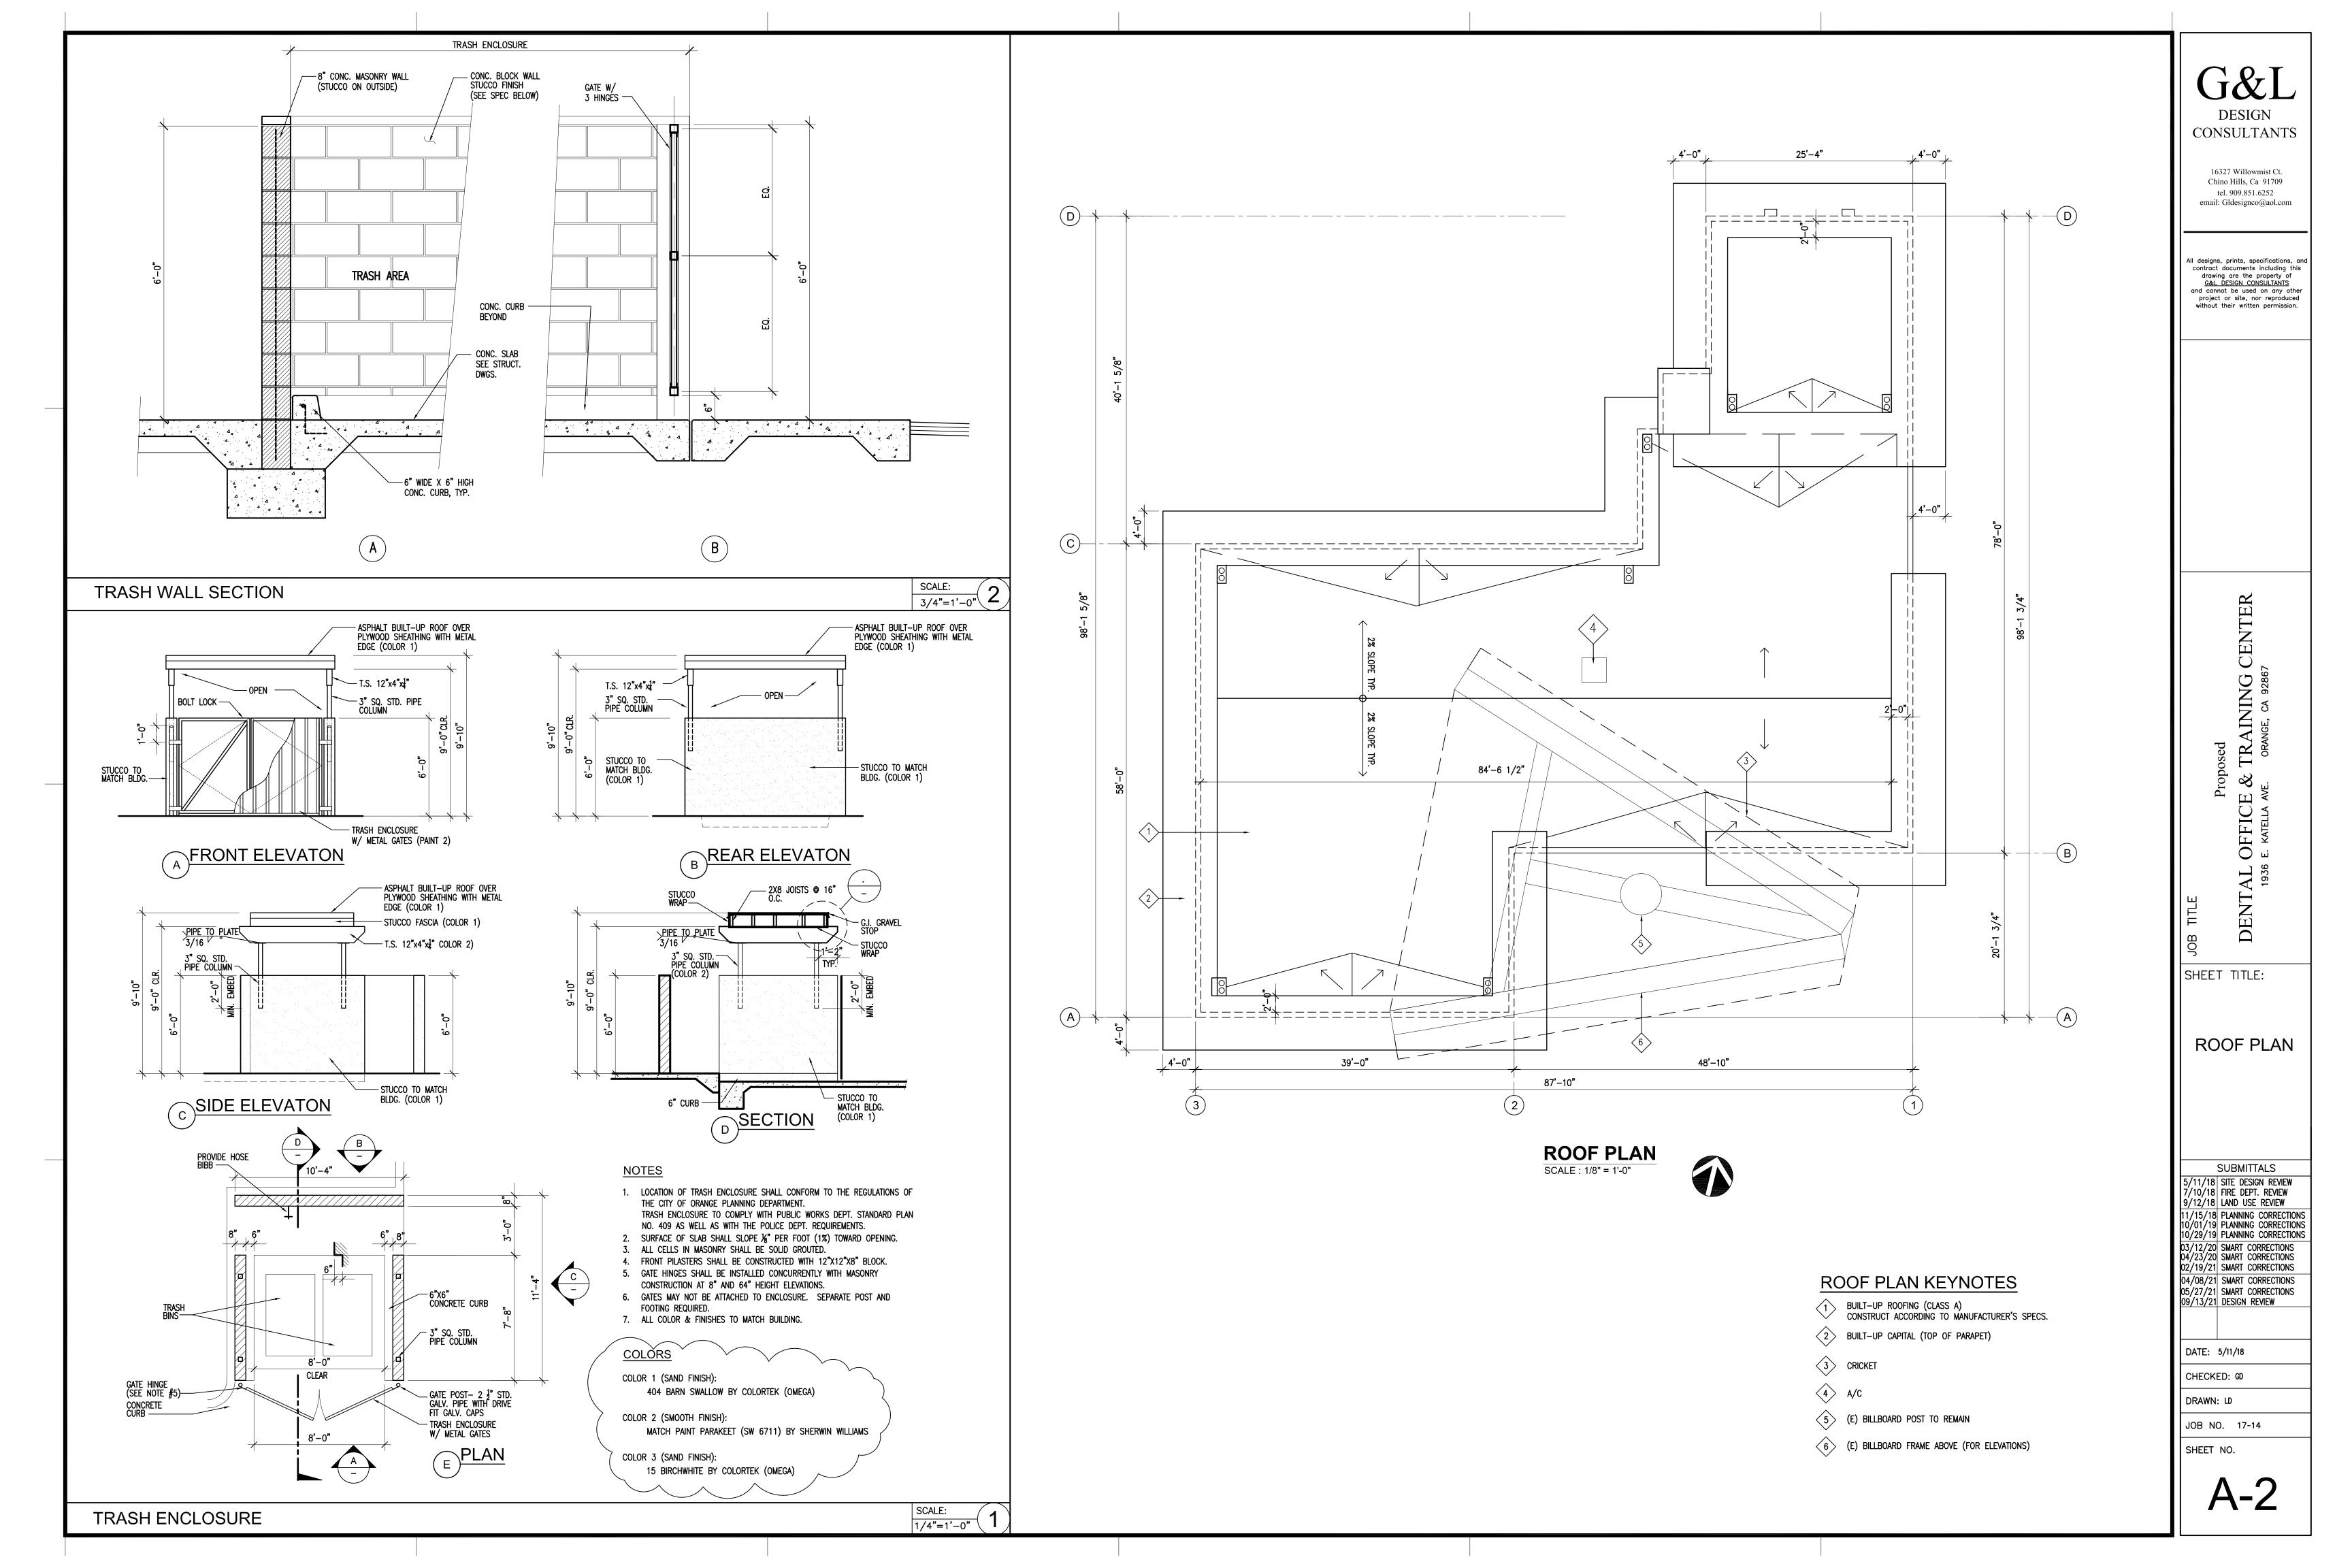





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THE LAND REFERRED TO HEREIN BELOW IS SITUATED IN THE CITY OF ORANGE, IN THE COUNTY OF ORANGE, STATE OF CALIFORNIA, AND IS DESCRIBED AS FOLLOWS: PARCEL 1:

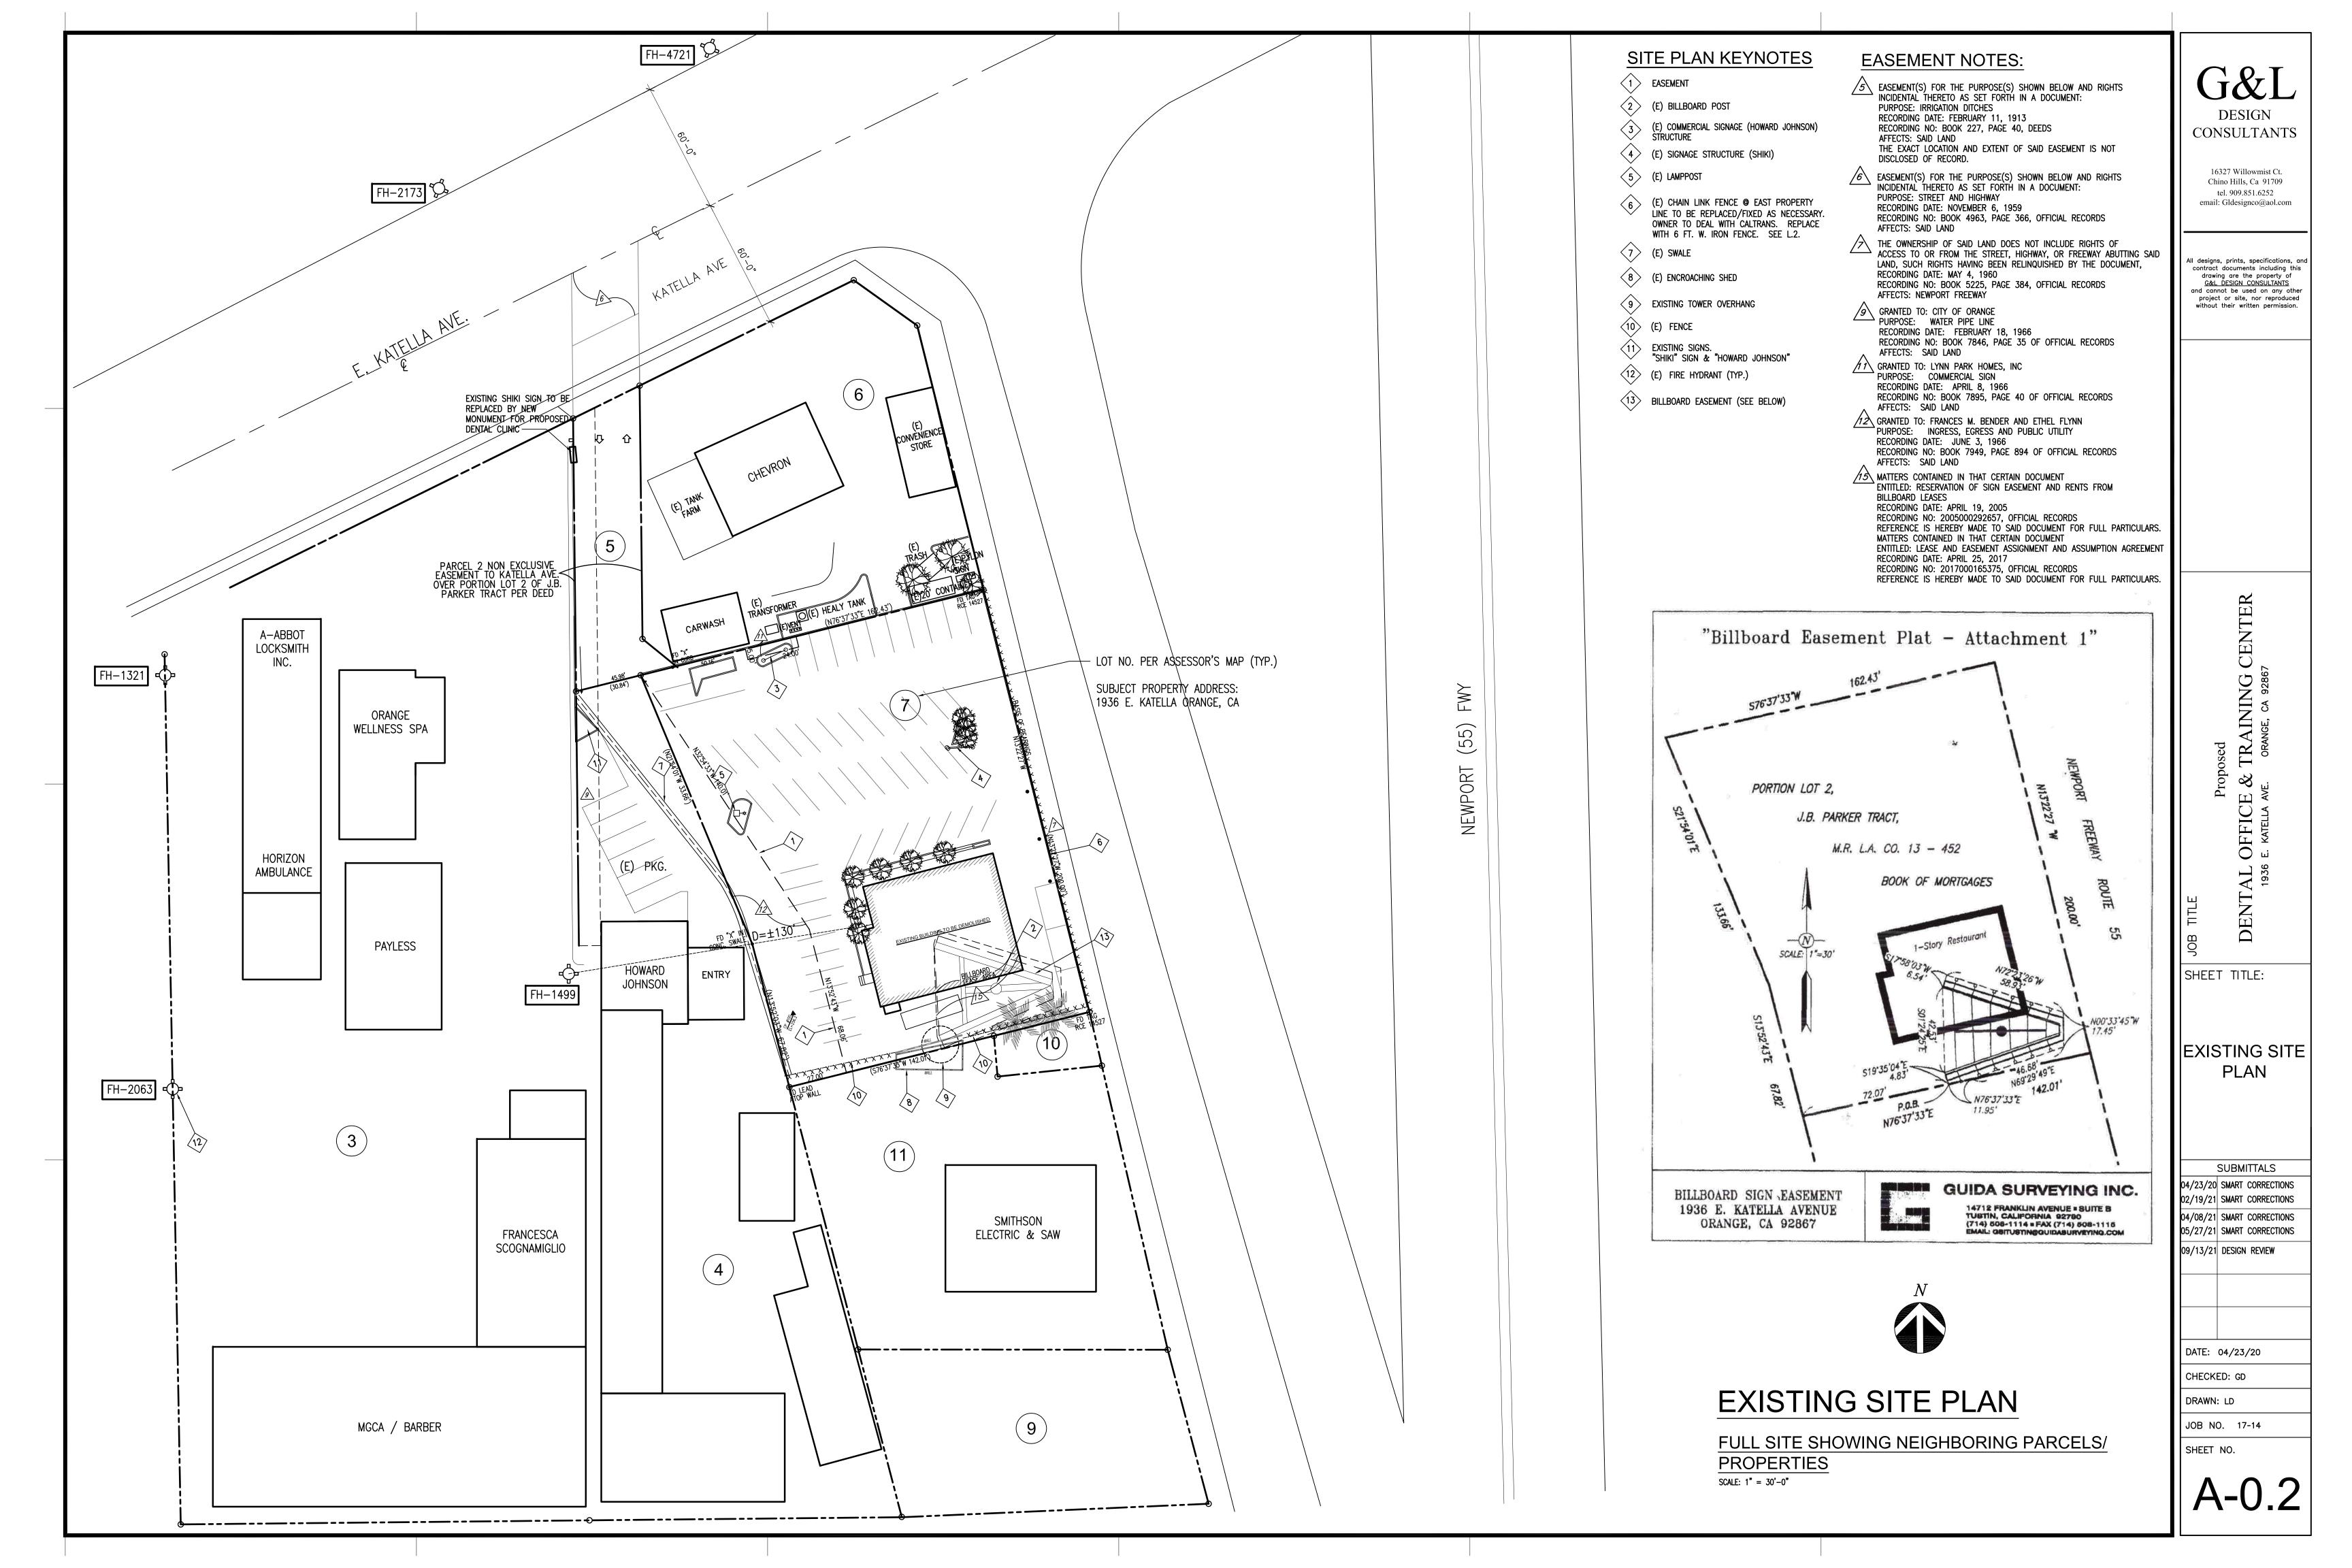THAT PORTION OF LOT 2 OF THE J.B. PARKER TRACT, IN THE CITY OF ORANGE, COUNTY OF ORANGE, STATE OF CALIFORNIA, AS PER MAP RECORDED NOVEMBER 19, 1874 IN BOOK 13 PAGE 452 OF MORTGAGES, RECORDS OF LOS ANGELES COUNTY, CALIFORNIA DESCRIBED AS FOLLOWS: COMMENCING AT A POINT IN THE WESTERLY LINE OF THE LAND DESCRIBED IN DEED TO THE STATE OF CALIFORNIA, RECORDED MAY 4, 1960 IN BOOK 5225 PAGE 384 OF OFFICIAL RECORDS, SAID POINT BEING NORTH 13° 22' 27" WEST 77.00 FEET FROM THE POINT OF INTERSECTION OF SAID WESTERLY LINE WITH THE SOUTHERLY LINE OF SAID LOT 2; THENCE NORTH 89° 16' 05" WEST PARALLEL WITH SAID SOUTHERLY LINE 145.30 FEET; THENCE NORTH 13° 52' 43" WEST 124.71 FEET TO THE TRUE POINT OF BEGINNING; THENCE CONTINUING NORTH 13° 52' 03" WEST 67.82 FEET TO A POINT IN A LINE THAT IS PARALLEL WITH AND DISTANT NORTHERLY 261.00 FEET FROM SAID SOUTHERLY LINE AND A POINT IN A LINE THAT IS PARALLEL WITH AND DISTANT EASTERLY 275.00 FEET FROM THE WESTERLY LINE OF THE LAND DESCRIBED IN DEED TO MARTIN E. DANNER AND WIFE, RECORDED MAY 4, 1960 IN BOOK 5227, PAGE 49 OF OFFICIAL RECORDS; THENCE NORTH 21° 54' 01" WEST 133.66 FEET TO A POINT IN THE WESTERLY PROLONGATION OF THE SOUTHERLY LINE OF THE LAND DESCRIBED IN PARCEL 1 OF THAT CERTAIN LEASE TO THE AMERICAN OIL COMPANY, RECORDED AUGUST 30, 1964 IN BOOK 7647 PAGE 813 OF OFFICIAL RECORDS, SAID POINT ALSO BEING A POINT IN A LINE THAT IS PARALLEL WITH AND DISTANT EASTERLY 225.00 FEET FROM SAID WESTERLY LINE OF THE LAND OF DANNER; THENCE NORTH 76° 37' 33" EAST ALONG SAID WESTERLY PROLONGATION AND ALONG SAID SOUTHERLY LINE 162.43 FEET TO A POINT IN SAID WESTERLY LINE OF THE LAND OF THE STATE OF CALIFORNIA; THENCE SOUTH 13° 22' 27" EAST ALONG SAID WESTERLY LINE 200.00 FEET TO A POINT IN A LINE THAT BEARS NORTH 76° 37' 33" EAST FROM THE TRUE POINT OF BEGINNING; THENCE SOUTH 76° 37' 33" WEST PARALLEL WITH SAID SOUTHERLY LINE OF THE LAND LEASED TO THE AMERICAN OIL COMPANY 142.01 FEET TO THE TRUE POINT OF BEGINNING. PARCEL 2:

A NON-EXCLUSIVE EASEMENT FOR INGRESS AND EGRESS OVER THAT PORTION OF LOT 2 OF THE J.B. PARKER TRACT, IN THE CITY OF ORANGE, COUNTY OF ORANGE, STATE OF CALIFORNIA, AS PER MAP RECORDED NOVEMBER 19, 1874 IN BOOK 13 PAGE 452 OF MORTGAGES, RECORDS OF LOS ANGELES COUNTY, CALIFORNIA, DESCRIBED AS FOLLOWS: COMMENCING AT A POINT IN THE WESTERLY LINE OF THE LAND DESCRIBED IN DEED TO THE STATE OF CALIFORNIA RECORDED MAY 4, 1960 IN BOOK 5225, PAGE 384 OF OFFICIAL RECORDS, SAID POINT BEING NORTH 13° 22' 27" WEST 77.00 FEET FROM THE POINT OF INTERSECTION OF SAID WESTERLY LINE WITH THE SOUTHERLY LINE OF SAID LOT 2; THENCE NORTH 89° 16' 05' WEST PARALLEL WITH SAID SOUTHERLY LINE 145.30 FEET THENCE NORTH 1 3° 52'43" WEST 192.53 FEET TO A POINT IN A LINE THAT IS PARALLEL WITH AND DISTANT NORTHERLY 261.00 FEET FROM SAID SOUTHERLY LINE AND A POINT IN A LINE THAT IS PARALLEL WITH AND DISTANT EASTERLY 275.00 FEET FROM THE WESTERLY LINE OF THE LAND DESCRIBED IN DEED TO MARTIN E. DANNER AND WIFE, RECORDED MAY 4, 1960 IN BOOK 5227 PAGE 49 OF OFFICIAL RECORDS, SAID POINT BEING THE TRUE POINT OF BEGINNING; THENCE NORTH 21° 54' 01" WEST 133.66 FEET TO A POINT IN THE WESTERLY PROLONGATION OF THE SOUTHERLY LINE OF THE LAND DESCRIBED IN PARCEL 1 OF THAT CERTAIN LEASE TO THE AMERICAN OIL COMPANY, RECORDED AUGUST 30, 1965 IN BOOK 7647 PAGE 813 OF OFFICIAL RECORDS, SAID POINT ALSO BEING A POINT IN A LINE THAT IS PARALLEL WITH AND DISTANT EASTERLY 225.00 FEET FROM SAID WESTERLY LINE OF THE LAND OF DANNER; THENCE SOUTH 76° 37' 33" WEST ALONG THE WESTERLY PROLONGATION OF SAID LAST MENTIONED SOUTHERLY LINE 30.84 FEET TO A POINT IN A LINE THAT IS PARALLEL WITH AND DISTANT EASTERLY 195.00 FEET FROM SAID WESTERLY LINE OF THE LAND OF DANNER; THENCE SOUTH 0° 03' 59" WEST PARALLEL WITH SAID WESTERLY LINE OF DANNER, 115.86 FEET TO A POINT IN A LINE THAT IS PARALLEL WITH AND DISTANT NORTHERLY 261.00 FEET FROM SAID SOUTHERLY LINE OF LOT 2; THENCE SOUTH 89° 16' 05" EAST PARALLEL WITH SAID SOUTHERLY LINE OF LOT 2, A DISTANCE OF 80.00 FEET TO THE TRUE POINT OF BEGINNING.

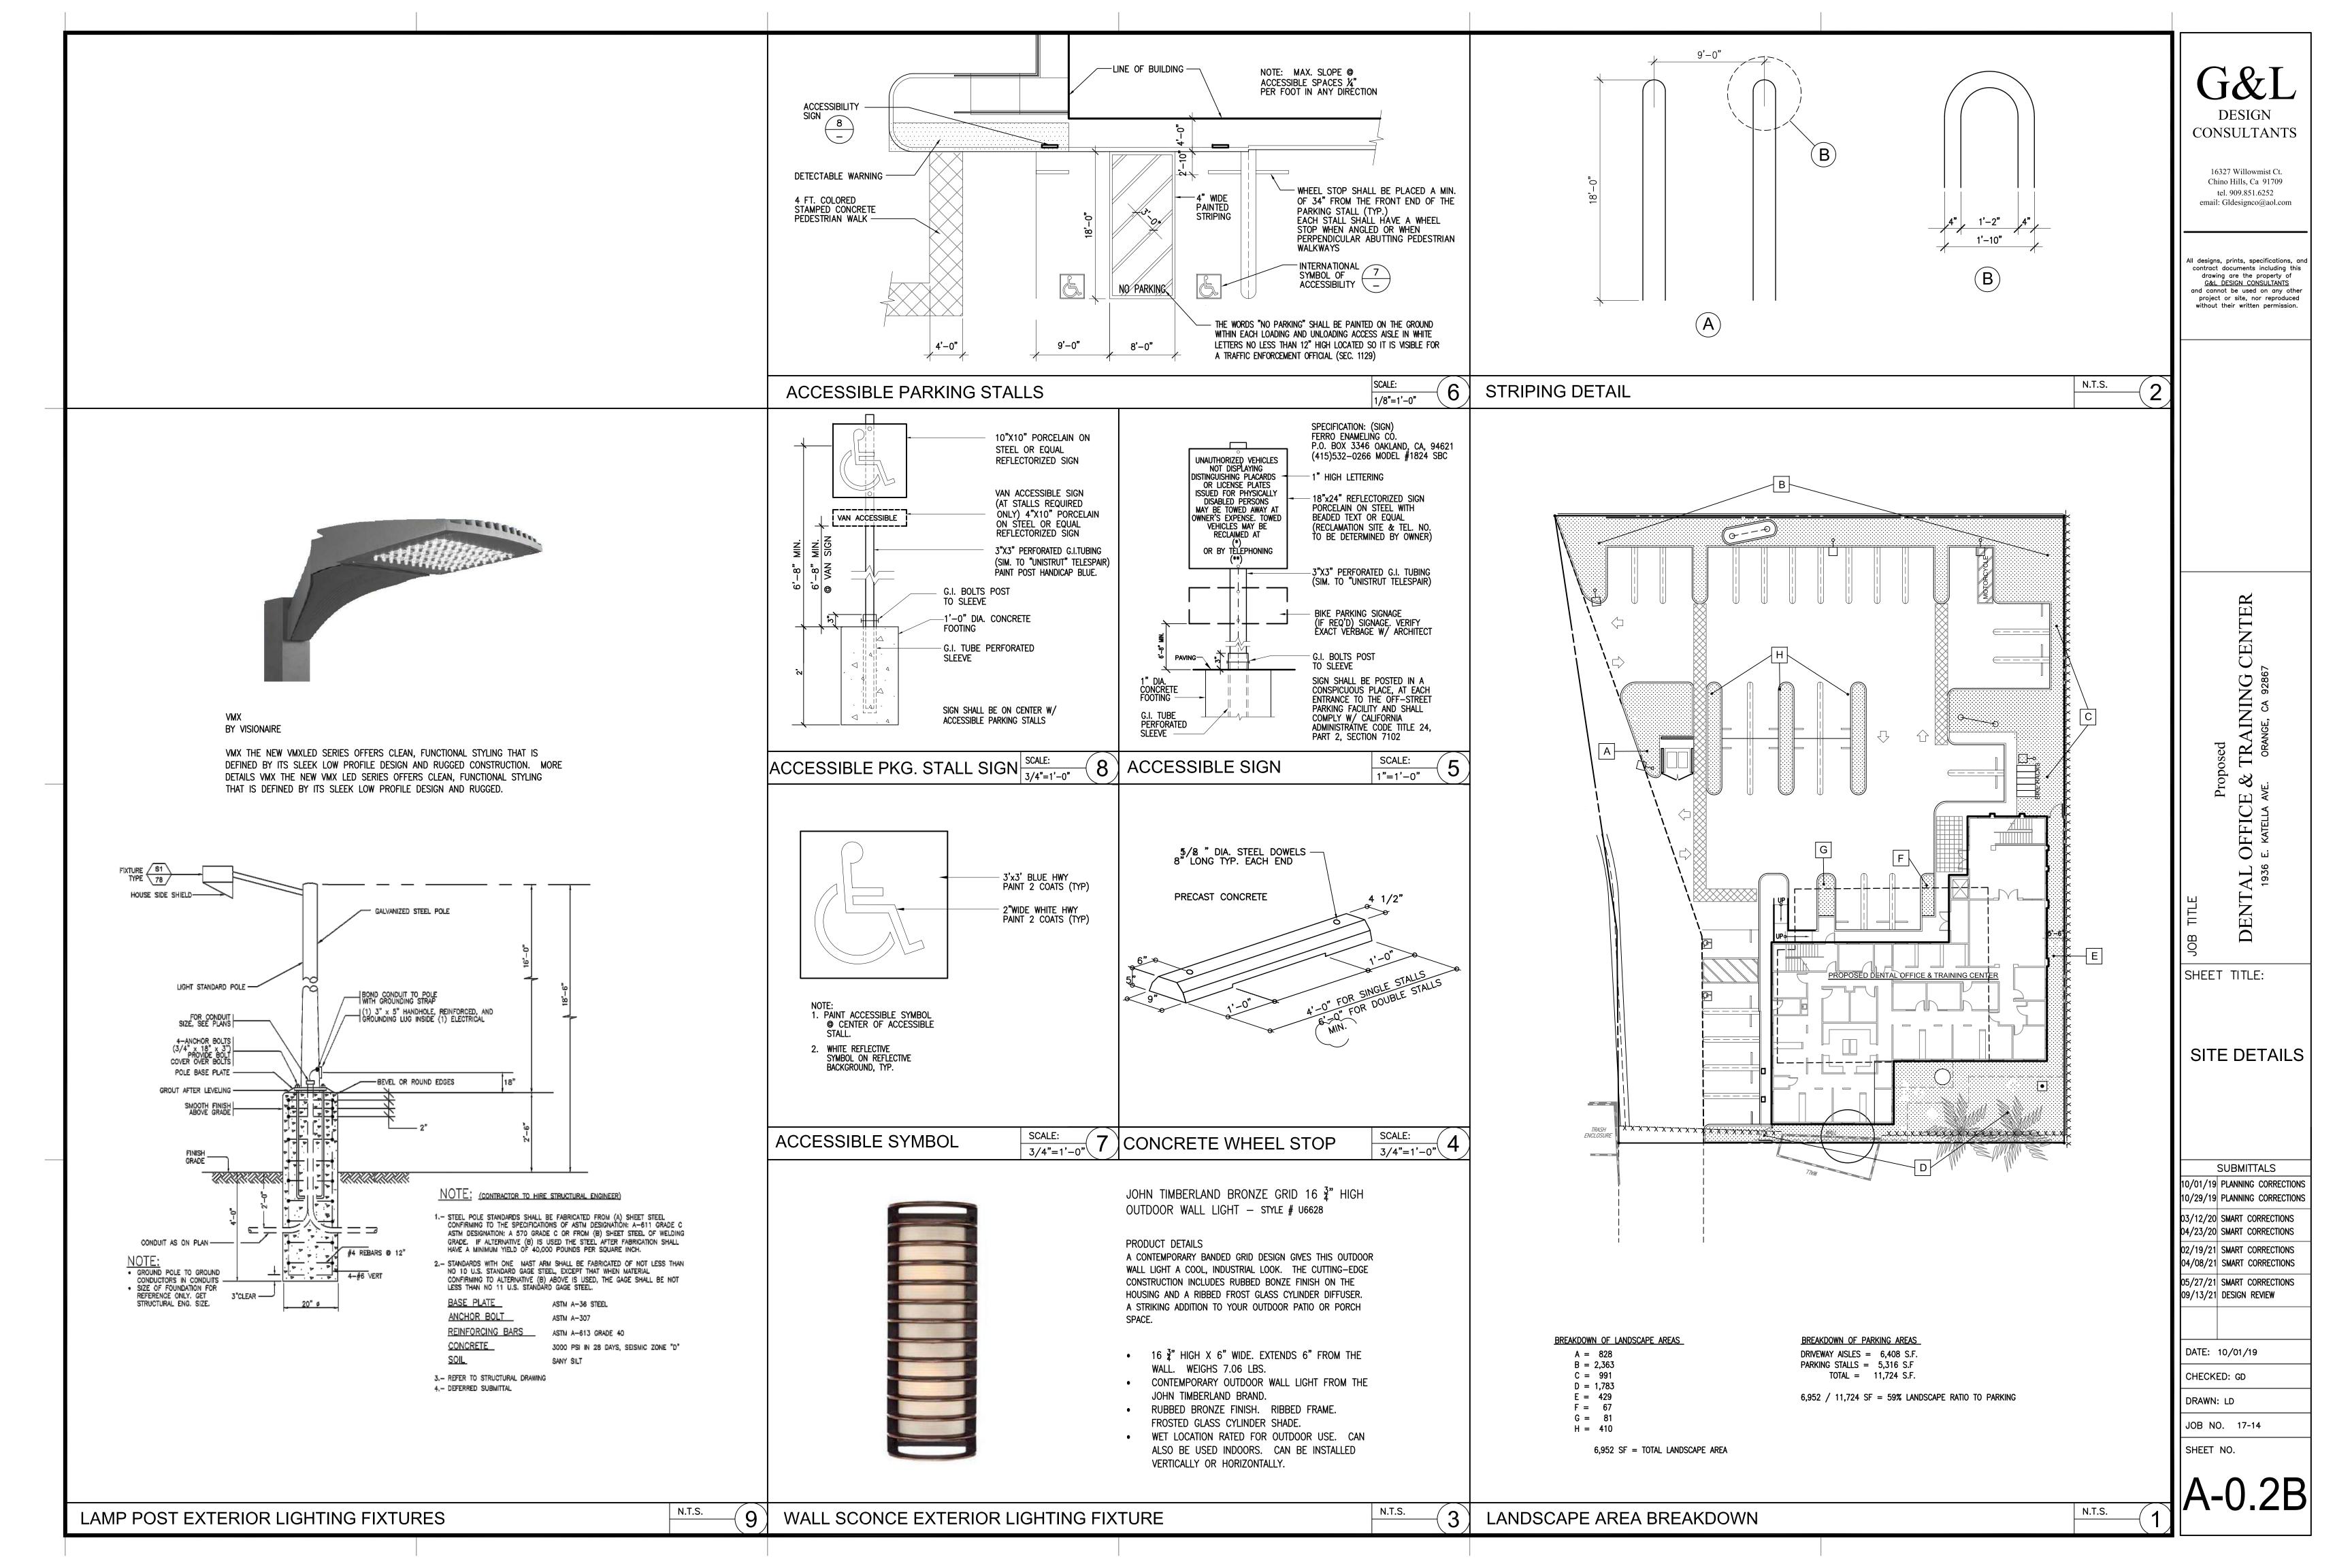PARCEL 3: A NON-EXCLUSIVE EASEMENT FOR INGRESS AND EGRESS AND FOR PUBLIC UTILITY PURPOSES OVER THAT PORTION OF LOT 2 OF THE J.B. PARKER TRACT, IN THE CITY OF ORANGE, COUNTY OF ORANGE, STATE OF CALIFORNIA, AS PER MAP RECORDED NOVEMBER 19, 1874 IN BOOK 13 PAGE 452, OF MORTGAGES, RECORDS OF LOS ANGELES COUNTY, DESCRIBED AS FOLLOWS: COMMENCING AT A POINT IN THE WESTERLY LINE OF THE LAND DESCRIBED IN DEED TO THE STATE OF CALIFORNIA, RECORDED MAY 4, 1960, IN BOOK 5225, PAGE 384 OF OFFICIAL RECORDS, SAID POINT BEING NORTH 13° 22' 27" WEST 77.00 FEET FROM THE POINT OF INTERSECTION OF SAID WESTERLY LINE WITH THE SOUTHERLY LINE OF SAID LOT 2; THENCE NORTH 89° 16' 05" WEST PARALLEL WITH SAID SOUTHERLY LINE 145.30 FEET; THENCE NORTH 13° 52' 43" WEST 192.53 FEET TO A POINT IN A LINE THAT IS PARALLEL WITH AND DISTANT NORTHERLY 261.00 FEET FROM SAID SOUTHERLY LINE AND A POINT IN A LINE THAT IS PARALLEL WITH AND DISTANT EASTERLY 275.00 FEET FROM THE WESTERLY LINE OF THE LAND DESCRIBED IN DEED TO MARTIN E. DANNER AND WIFE, RECORDED MAY 4, 1960 IN BOOK 5227, PAGE 49 OF OFFICIAL RECORDS; THENCE NORTH 21° 54' 01" WEST 133.66 FEET TO A POINT IN THE WESTERLY PROLONGATION OF THE SOUTHERLY LINE OF THE LAND DESCRIBED IN PARCEL 1 OF THAT CERTAIN LEASE TO THE AMERICAN OIL COMPANY, RECORDED AUGUST 30, 1965 IN BOOK 7647 PAGE 813 OF OFFICIAL RECORDS, SAID POINT ALSO BEING A POINT IN A LINE THAT IS PARALLEL WITH AND DISTANT EASTERLY 225.00 FEET FROM SAID WESTERLY LINE OF THE LAND OF DANNER, SAID POINT BEING THE TRUE POINT OF BEGINNING; THENCE SOUTH 76° 37' 33" WEST ALONG SAID WESTERLY PROLONGATION 30.84 FEET TO A POINT IN A LINE THAT IS PARALLEL WITH AND DISTANT EASTERLY 195.00 FEET FROM SAID WESTERLY LINE OF DANNER; THENCE NORTH 0° 03' 50" EAST PARALLEL WITH SAID WESTERLY LINE OF THE LAND OF DANNER, 191.37 FEET TO A POINT IN THE CENTERLINE OF THE STRIP OF LAND 60.00 FEET IN WIDTH DESCRIBED IN DEED TO THE COUNTY OF ORANGE, OCTOBER 15, 1959 IN BOOK 4928, PAGE 561 OF OFFICIAL RECORDS; THENCE NORTH 64° 30' 14" EAST ALONG SAID CENTERLINE 33.26 FEET; THENCE SOUTHERLY TO THE POINT OF BEGINNING.

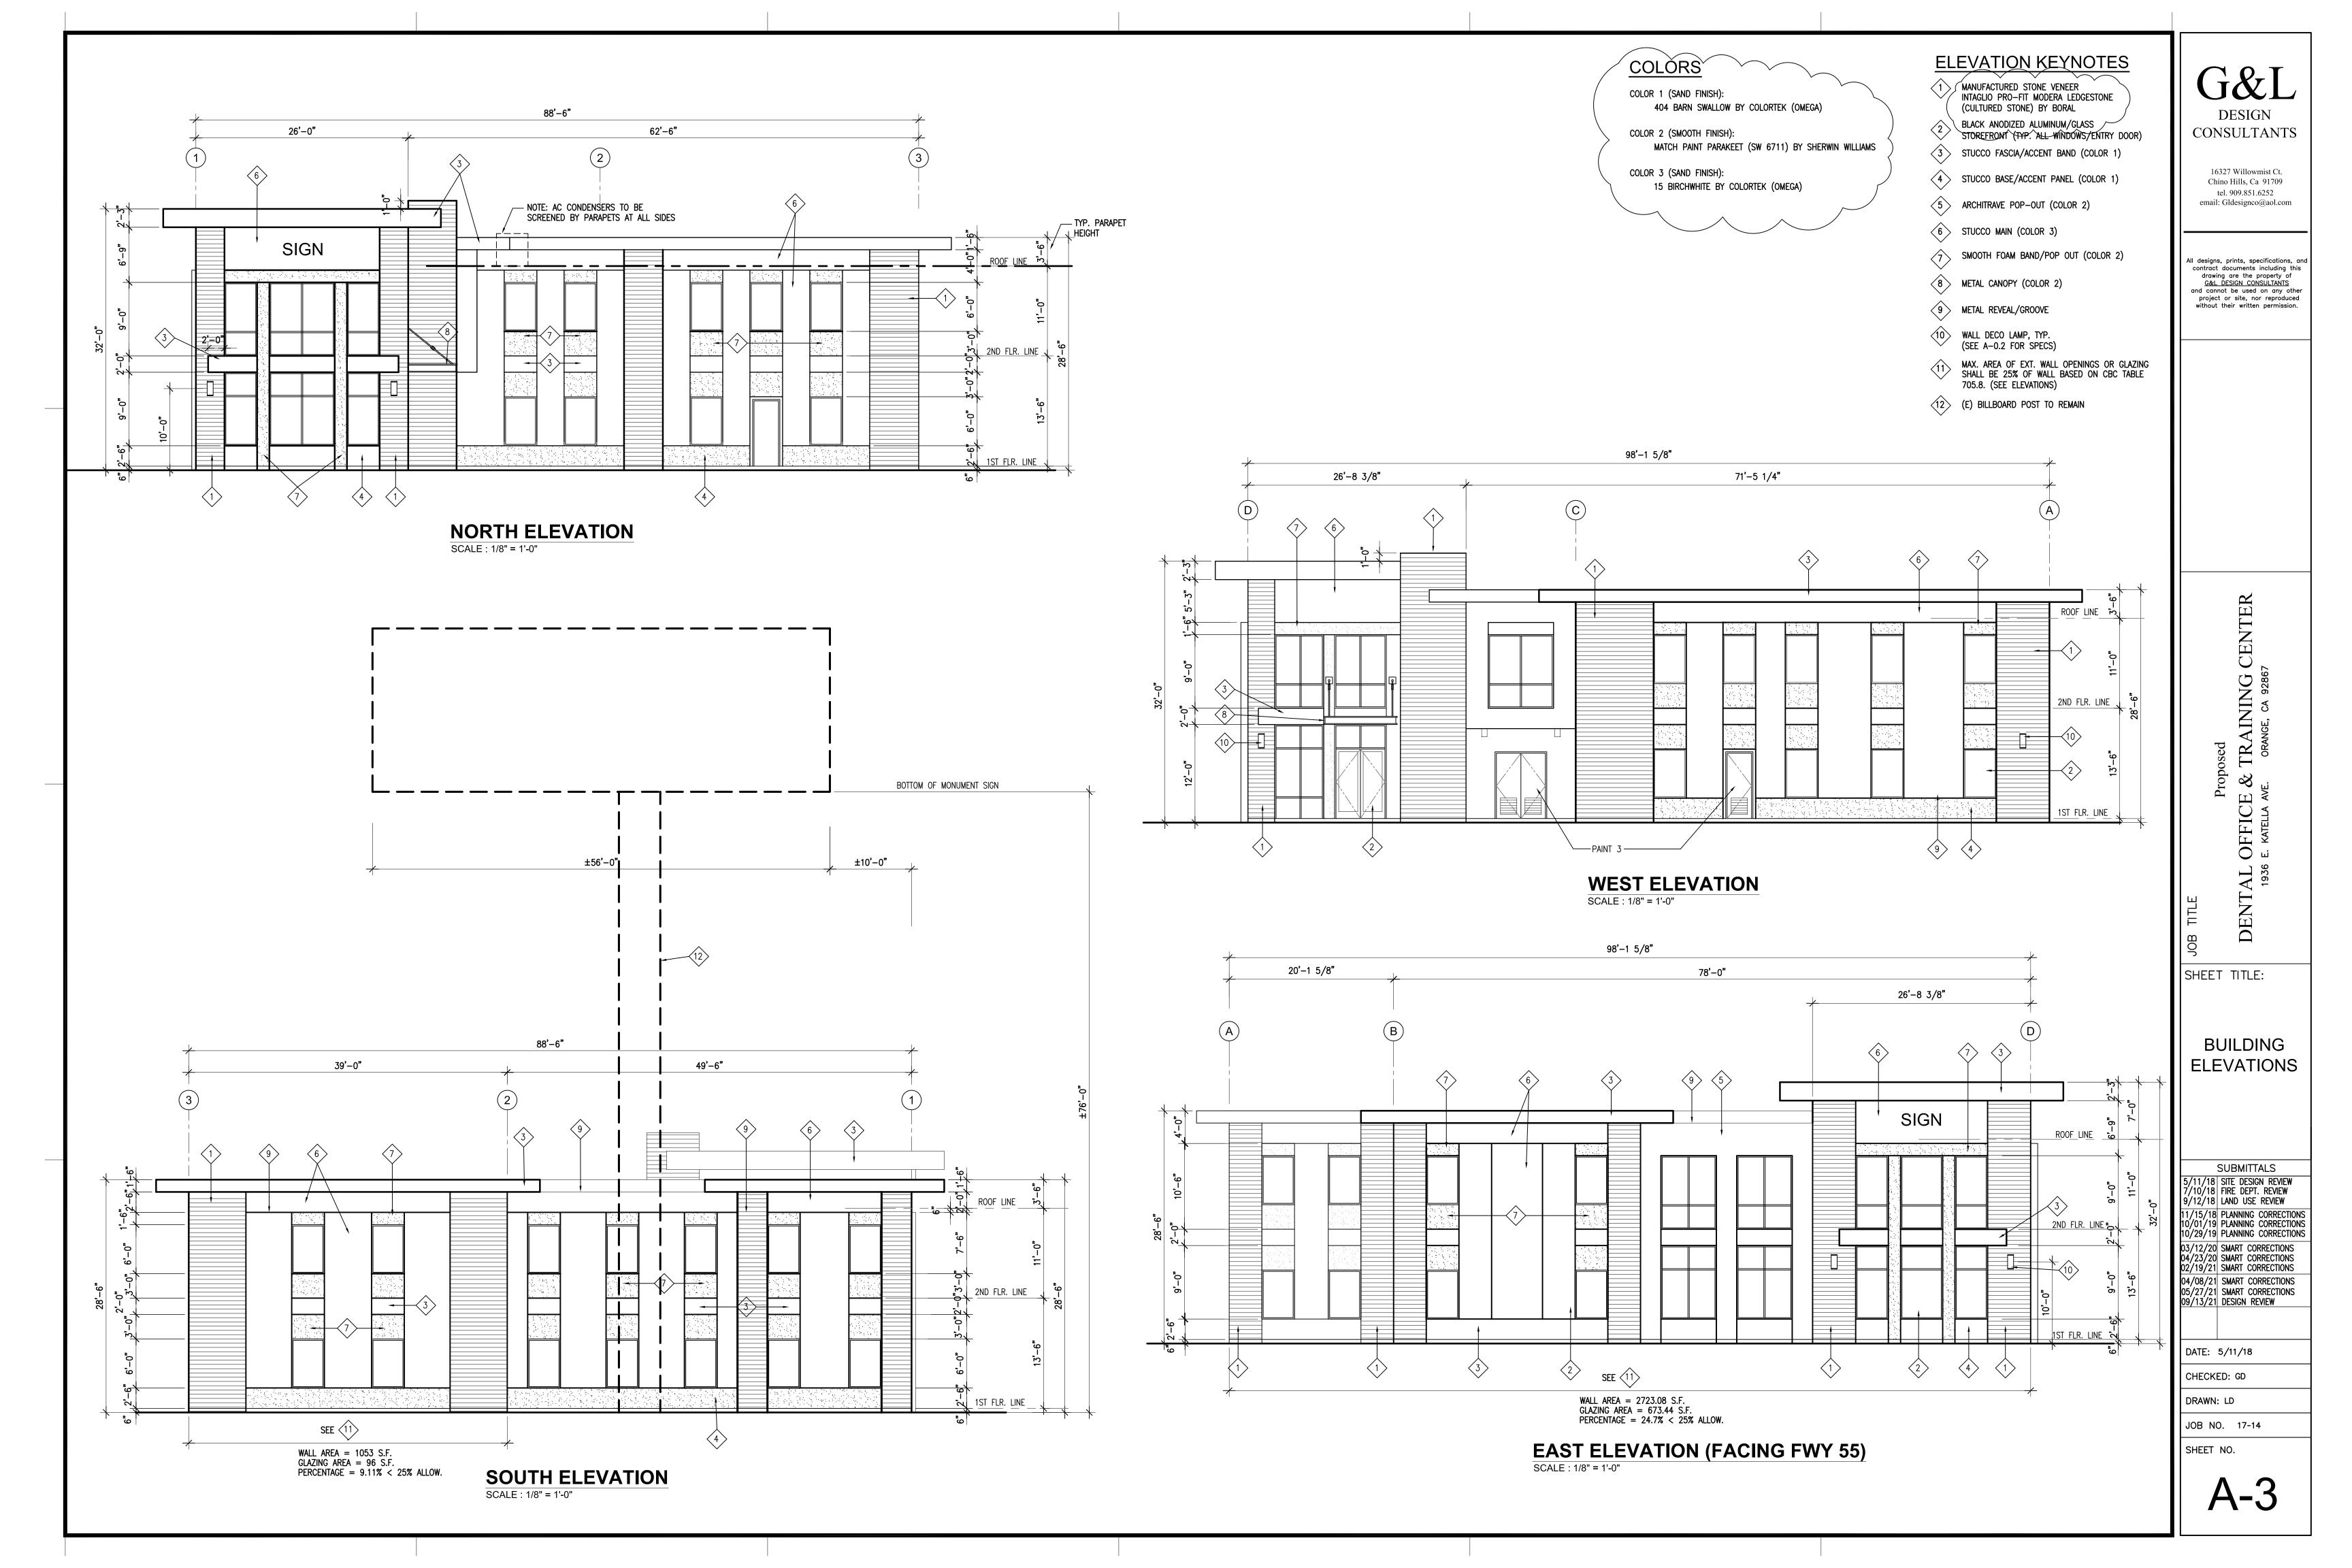5 EASEMENT(S) FOR THE PURPOSE(S) SHOWN BELOW AND RIGHTS INCIDENTAL THERETO AS SET FORTH IN A DOCUMENT: PURPOSE: IRRIGATION DITCHES RECORDING DATE: FEBRUARY 11, 1913 RECORDING NO: BOOK 227, PAGE 40, DEEDS AFFECTS: SAID LAND THE EXACT LOCATION AND EXTENT OF SAID EASEMENT IS NOT DISCLOSED OF

RECORD. 6 EASEMENT(S) FOR THE PURPOSE(S) SHOWN BELOW AND RIGHTS INCIDENTAL THERETO ÀS SET FORTH IN A DOCUMENT: PURPOSE: STREET AND HIGHWAY RECORDING DATE: NOVEMBER 6, 1959 RECORDING NO: BOOK 4963, PAGE 366, OFFICIAL RECORDS

AFFECTS: SAID LAND THE OWNERSHIP OF SAID LAND DOES NOT INCLUDE RIGHTS OF ACCESS TO OR FROM THE STREET, HIGHWAY, OR FREEWAY ABUTTING SAID LAND, SUCH RIGHTS HAVING BEEN RELINQUISHED BY THE DOCUMENT, RECORDING DATE: MAY 4, 1960 RECORDING NO: BOOK 5225, PAGE 384, OFFICIAL RECORDS

/9\ GRANTED TO: CITY OF ORANGE $\overset{ldot}{}$ purpose: Water Pipe Line RECORDING DATE: FEBRUARY 18, 1966 RECORDING NO: BOOK 7846, PAGE 35 OF OFFICIAL RECORDS AFFECTS: SAID LAND

AFFECTS: NEWPORT FREEWAY

/11\ GRANTED TO: LYNN PARK HOMES, INC

PURPOSE: COMMERCIAL SIGN RECORDING DATE: APRIL 8, 1966 RECORDING NO: BOOK 7895, PAGE 40 OF OFFICIAL RECORDS AFFECTS: SAID LAND

/12\ GRANTED TO: FRANCES M. BENDER AND ETHEL FLYNN PURPOSE: INGRESS, EGRESS AND PUBLIC UTILITY RECORDING DATE: JUNE 3, 1966 RECORDING NO: BOOK 7949, PAGE 894 OF OFFICIAL RECORDS


AFFECTS: SAID LAND 15 MATTERS CONTAINED IN THAT CERTAIN DOCUMENT ENTITLED: RESERVATION OF SIGN EASEMENT AND RENTS FROM BILLBOARD LEASES

RECORDING DATE: APRIL 19, 2005 RECORDING NO: 2005000292657, OFFICIAL RECORDS REFERENCE IS HEREBY MADE TO SAID DOCUMENT FOR FULL PARTICULARS. MATTERS CONTAINED IN THAT CERTAIN DOCUMENT ENTITLED: LEASE AND EASEMENT ASSIGNMENT AND ASSUMPTION AGREEMENT RECORDING DATE: APRIL 25, 2017 RECORDING NO: 2017000165375, OFFICIAL RECORDS

REFERENCE IS HEREBY MADE TO SAID DOCUMENT FOR FULL PARTICULARS.

SHEET INDEX OVERALL SITE PLAN C-2 C-3

CONCEPTUAL GRADING PLAN DETAIL SHEET ADA DETAILS C-4 C-5 EROSION CONTROL PLAN

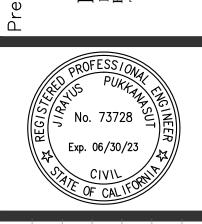



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Sheet No.

CONCEPTUAL GRADING & DRAINAGE PLAN

DENTAL OFFICE & TRAINING CENTER 1936 E. KATELLA AVE, ORANGE, CA

A PRE-CONSTRUCTION MEETING IS REQUIRED PRIOR TO BEGINNING ANY GRADING OR CONSTRUCTION. CALL CITY INSPECTOR 714-744-5526 TO ARRANGE MEETING TIME. 2. ALL GRADING SHALL BE DONE IN ACCORDANCE WITH THE CITY OF ORANGE MANUAL OF GRADING AND STANDARD PLANS AND SPECIFICATIONS (AVAILABLE ON CITY WEBSITE OR AT

3. CITY APPROVAL OF PLANS DOES NOT RELIEVE THE DEVELOPER FROM RESPONSIBILITY FOR THE CORRECTION OF ANY ERROR AND/OR OMISSION DISCOVERED DURING THE CONSTRUCTION. ANY SUBSTANTIAL CHANGES TO THE APPROVED GRADING PLAN OCCASIONED BY FIELD CONDITIONS, SITE PLAN CHANGES, ETC. SHALL BE ACCOMPLISHED PRIOR TO FINAL GRADING, AND SHALL BE REVIEWED AND APPROVED BY THE CITY ENGINEER PRIOR TO

4. RETAINING WALLS WILL BE REQUIRED WHERE CUTTING OR FILLING ALONG PROPERTY LINES 💍 MAY CAUSE DAMAGE, BUT ALWAYS WHERE THE CUT OR FILL EXCEEDS ONE (1) VERTICAL

5. FREE STANDING AND RETAILING WALLS SHOWN ON THIS PLAN ARE FOR LOCATION AND ELEVATION CONTOURS ONLY. APPROVAL OF THIS PLAN DOES NOT CONSTITUTE STRUCTURAL APPROVAL OF ANY WALLS OR RETAINING DEVICES SHOWN HEREON. A SEPARATE PLAN CHECK AND PERMIT MUST BE OBTAINED FROM THE CITY BUILDING DIVISION BEFORE THE

ALL ON-SITE SLOPES SHALL NOT EXCEED A GRADE OF TWO (2) HORIZONTAL TO ONE (1) VERTICAL (2:1), UNLESS STEEPER SLOPES ARE AUTHORIZED BY THE SOILS ENGINEER

CONDUCTING ANY GRADING, CLEARING, BRUSHING, OR GRUBBING ON NATURAL OR EXISTING GRADE THAT IS PREPARATORY

IN WRITING TO THE CITY ENGINEER AND SHALL BE SIGNED AND STAMPED BY A LICENSED PROFESSIONAL ENGINEER, LAND SURVEYOR, SOILS OR GEOTECHNICAL ENGINEER, AND GRADING CONTRACTOR. THESE CERTIFICATIONS SHALL BE FILED WITH THE CITY PRIOR TO THE

LANDSCAPING AND IRRIGATION PLANS, AS REQUIRED, SHALL BE APPROVED BY THE CITY 10. PROVIDE STREET TREES AS REQUIRED BY THE CITY. NOTIFY DEPARTMENT OF PUBLIC WORKS, MAINTENANCE DIVISION, 714-532-6480 FOR STREET TREE LOCATION AND PLANTING

11. ALL FILL ONE (1) FOOT OR GREATER SHALL BE TESTED AND CERTIFIED AS TO RELATIVE

12. FILL SLOPES THREE (3) FEET OR GREATER IN HEIGHT SHALL BE COMPACTED TO THE FACE. THE SOILS ENGINEER SHALL INCLUDE SLOPE COMPACTION TESTS IN THE FINAL

13. ALL UTILITY TRENCH BACKFILLS SHALL BE IN ACCORDANCE WITH THE RECOMMENDATIONS

14. ALL FILL SHALL BE COMPACTED IN ACCORDANCE WITH THE CURRENT VERSION OF THE CALIFORNIA BUILDING CODE ADOPTED BY THE CITY OR RESPONSIBLE ENGINEERING RECOMMENDATIONS.

ENGINEER, OR ENGINEERING GEOLOGIST WHO IS RESPONSIBLE FOR THE PROFESSIONAL SUPERVISION OF THAT PORTION OF THE GRADING WHICH IS WITHIN HIS AREA OF TECHNICAL OTHERWISE TERMINATES HIS DUTIES PRIOR COMPLETION OF THE WORK SHOWN ON THESE PLANS HE SHALL REPORT THIS FACT IN WRITING TO THE CITY ENGINEER WITHIN 48 HOURS OF HIS TERMINATION. PERSON ASSUMING HIS DUTIES SHALL PERFORM ALL INVESTIGATIONS HE DEEM NECESSARY TO APPROVE THE GRADING PERMIT. ACCEPTANCE OF THE PROJECT BY THE NEW CONSULTANT SHALL BE MADE IN WRITING TO THE CITY, AND SHALL INCLUDE HIS

16. REPAIR OR REPLACE ANY BROKEN OR DETERIORATED ADJACENT PUBLIC INFRASTRUCTURE AND

17. ALL UTILITY LINES FROM PUBLIC STREET AND EASEMENT, INCLUDING POWER LINES AND UNDERGROUND. 18. A SEPARATE ENCROACHMENT PERMIT IS REQUIRED FOR WORK PERFORMED IN PUBLIC

19. A SEPARATE HAUL PERMIT IS REQUIRED FOR IMPORT/EXPORT OF EARTH MATERIAL.

STRIPE ADA PARKING AND LOADING PER DETAIL ON C-4 3) | CONSTRUCT LANDSCAPE PER LANDSCAPE PLAN (4) JOIN EXISTING IMPROVEMENTS, VERIFY ELEVATION PRIOR TO ANY CONSTRUCTION CONSTRUCT PLANTER BOX PER DETAIL 3 ON C-3 (6) ALL ROOF DRAIN TO PLANTER BOX BIO-FILTRATION SAWCUT 2' BEYOND AND REMOVE EXISTING CURB & GUTTER, SIDEWALK, AC PAVEMENT, AND CONCRETE

DUPLEX ZOELLER MODEL 163/4163, 0.5HP PUMP FOR PUMPING TO BMP TREATMENT DETAIL 1 C-3

EXISTING AC PAVEMENT IN FIRE ACCESS ROADWAY SHALL BE TESTED TO CONFIRM THAT IT CAN SUPPORT THE IMPOSED LOADS OF THE ORANGE FIRE DEPARTMENT FIRE APPARATUS WITH A TOTAL OF 68,000 POUNDS. IF NOT IT SHALL BE REMOVED AND REPLACE WITH THE NEW AC PAVEMENT TO SUPPORT 68,000 POUNDS


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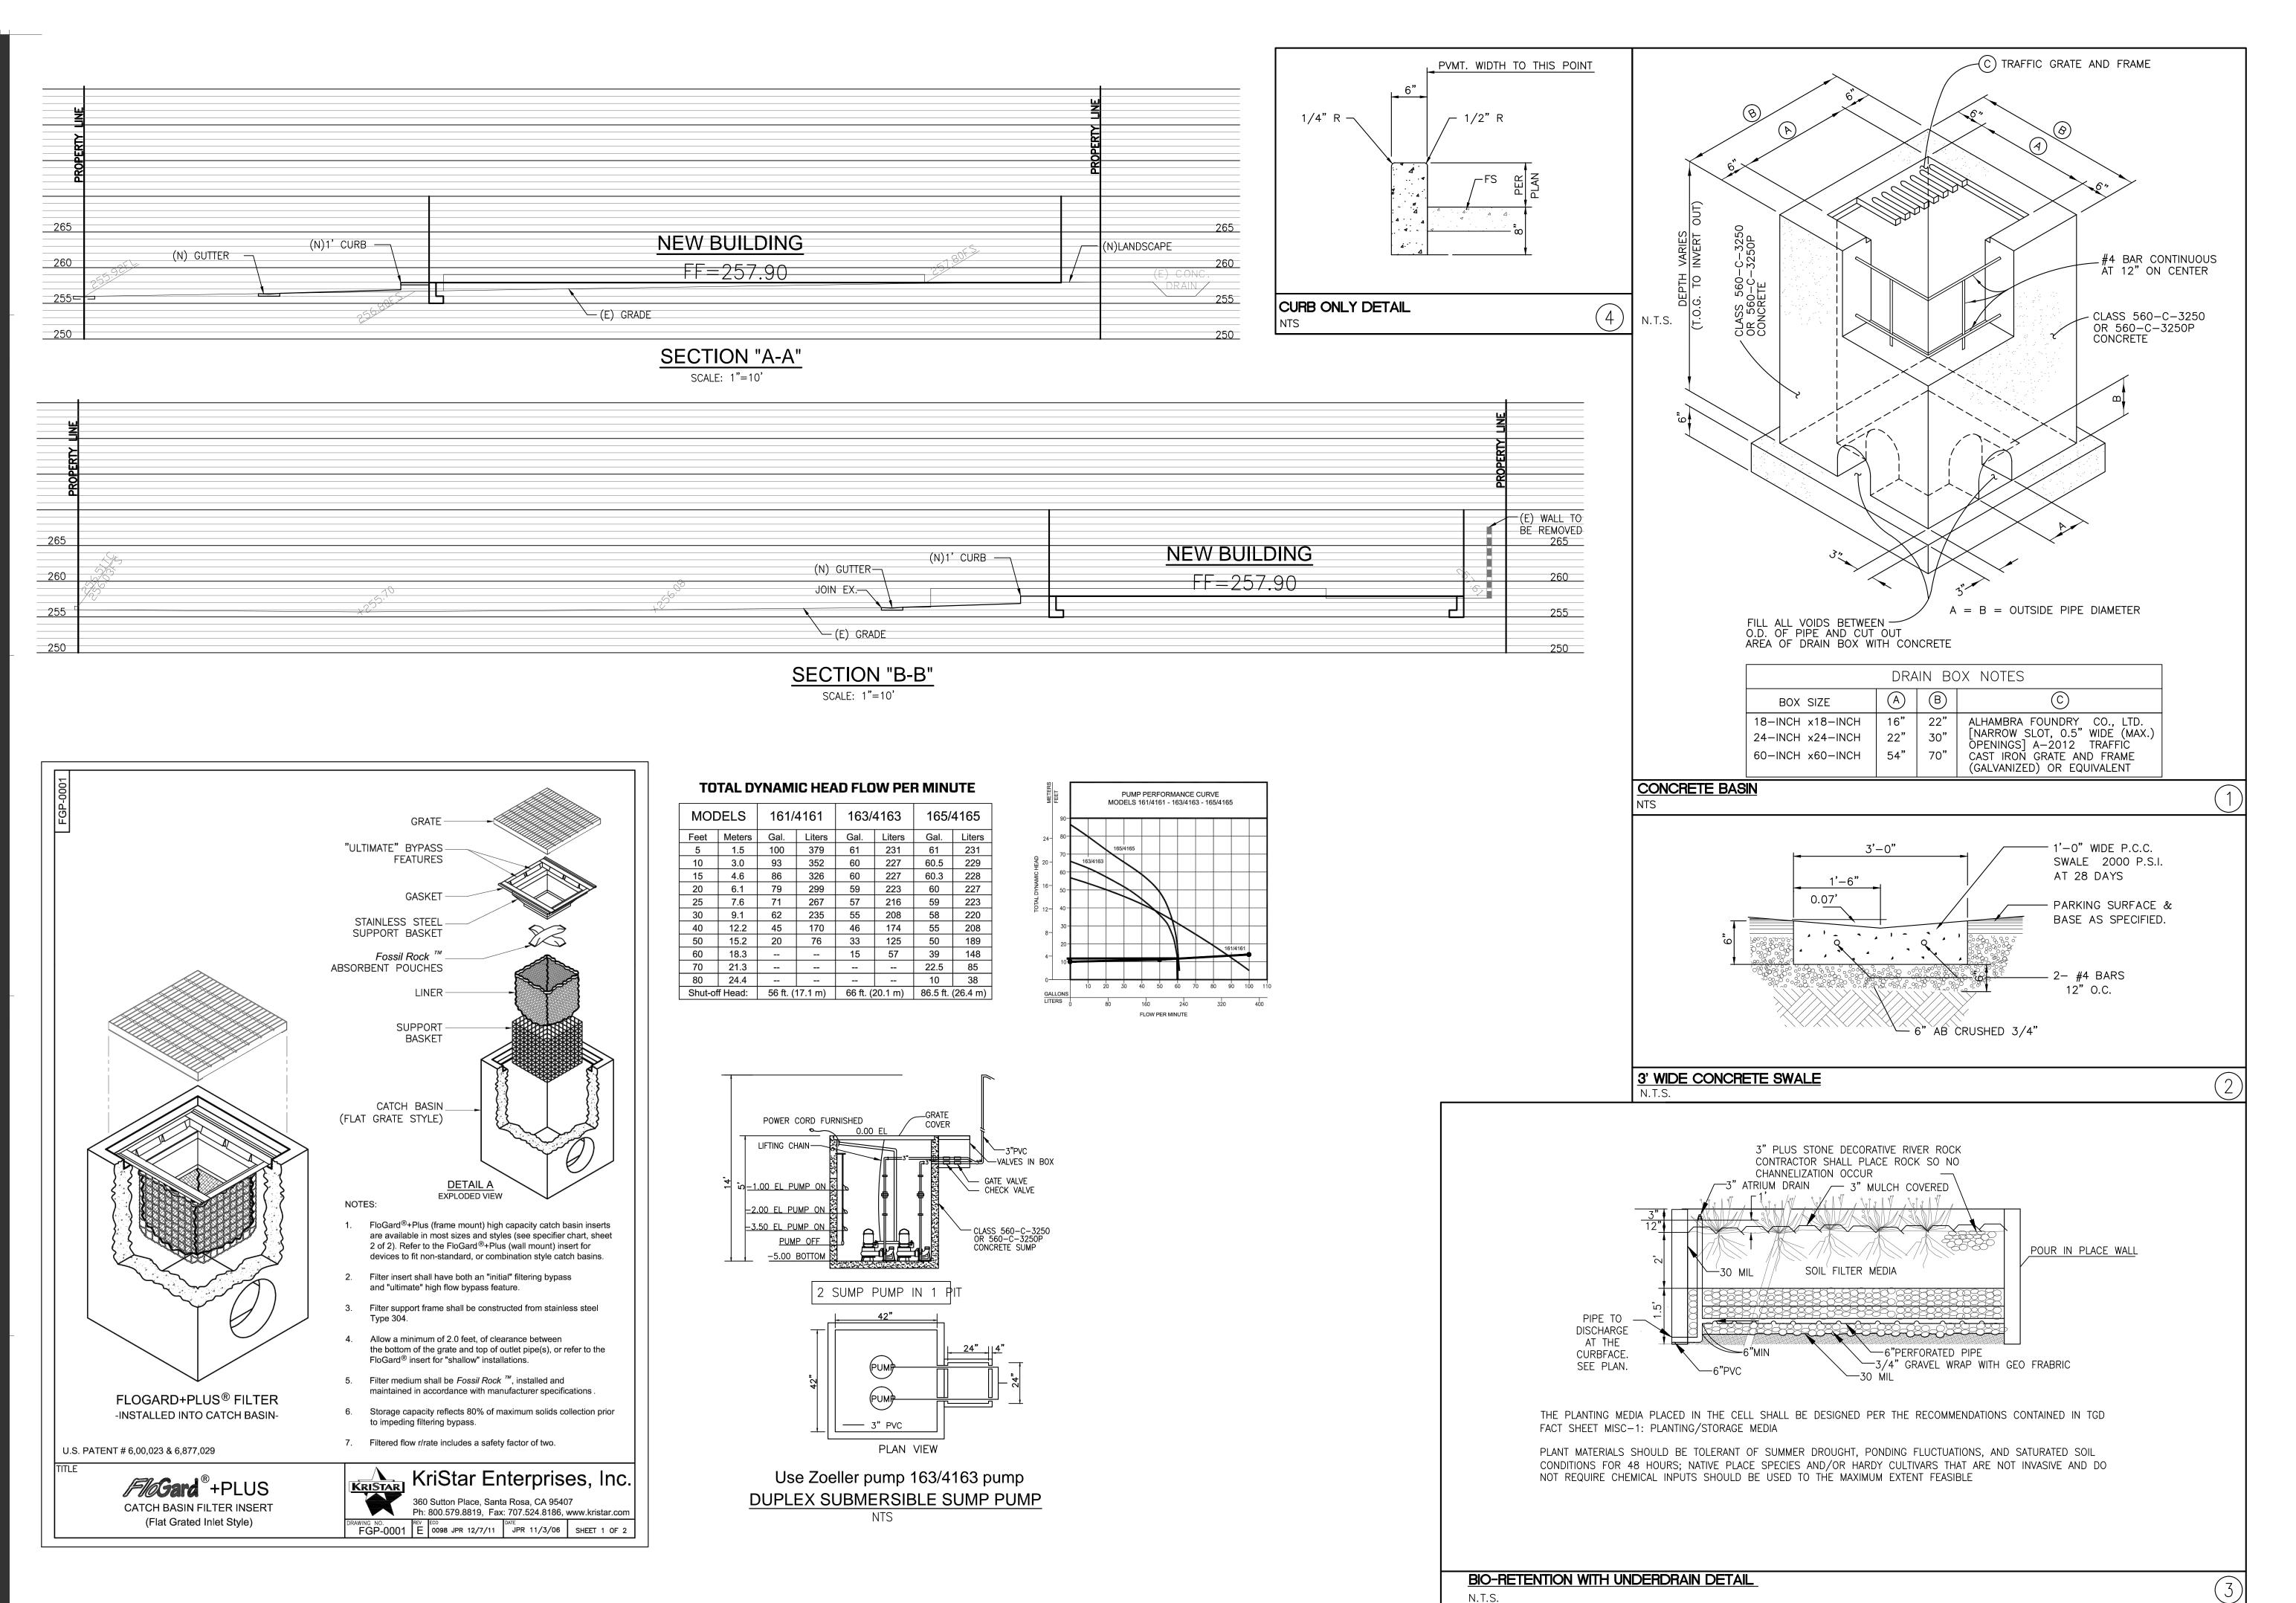
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Scale:

As noted





AN BOVAL 86 E. KATELLA ANGE, CA L: 562-552-1344 1AIL: ALANBOVAL@HOTMAIL.CO

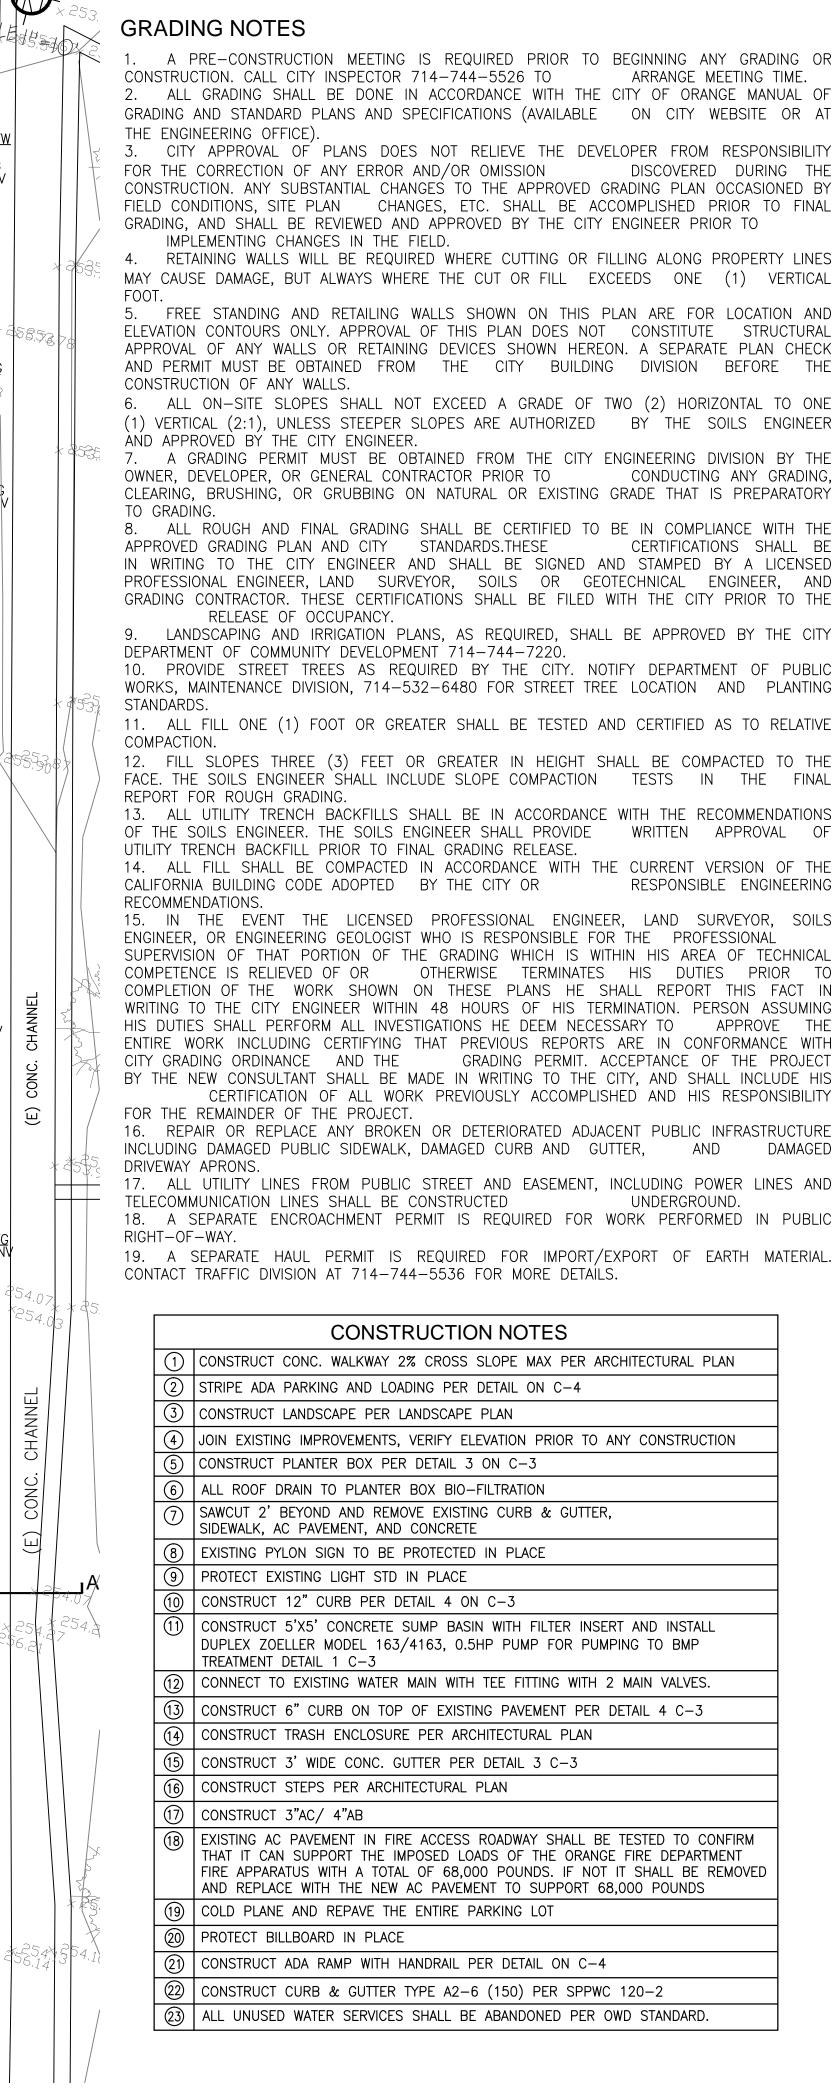DETAIL SHEET
SENTAL OFFICE &
SS TRAINING CENTER

PACIFIC GEOTECH, INC. 1424 ROLLING HILLS DRIVE FULLERTON, CA 92835 TEL (714) 723-9703


PROFESS/ONAL PURTANT CONTROL OF CALLORS AND C

Revisions
o. Date Description

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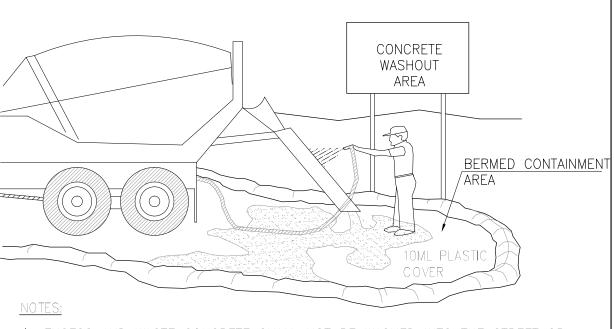
Sheet No.

C-3

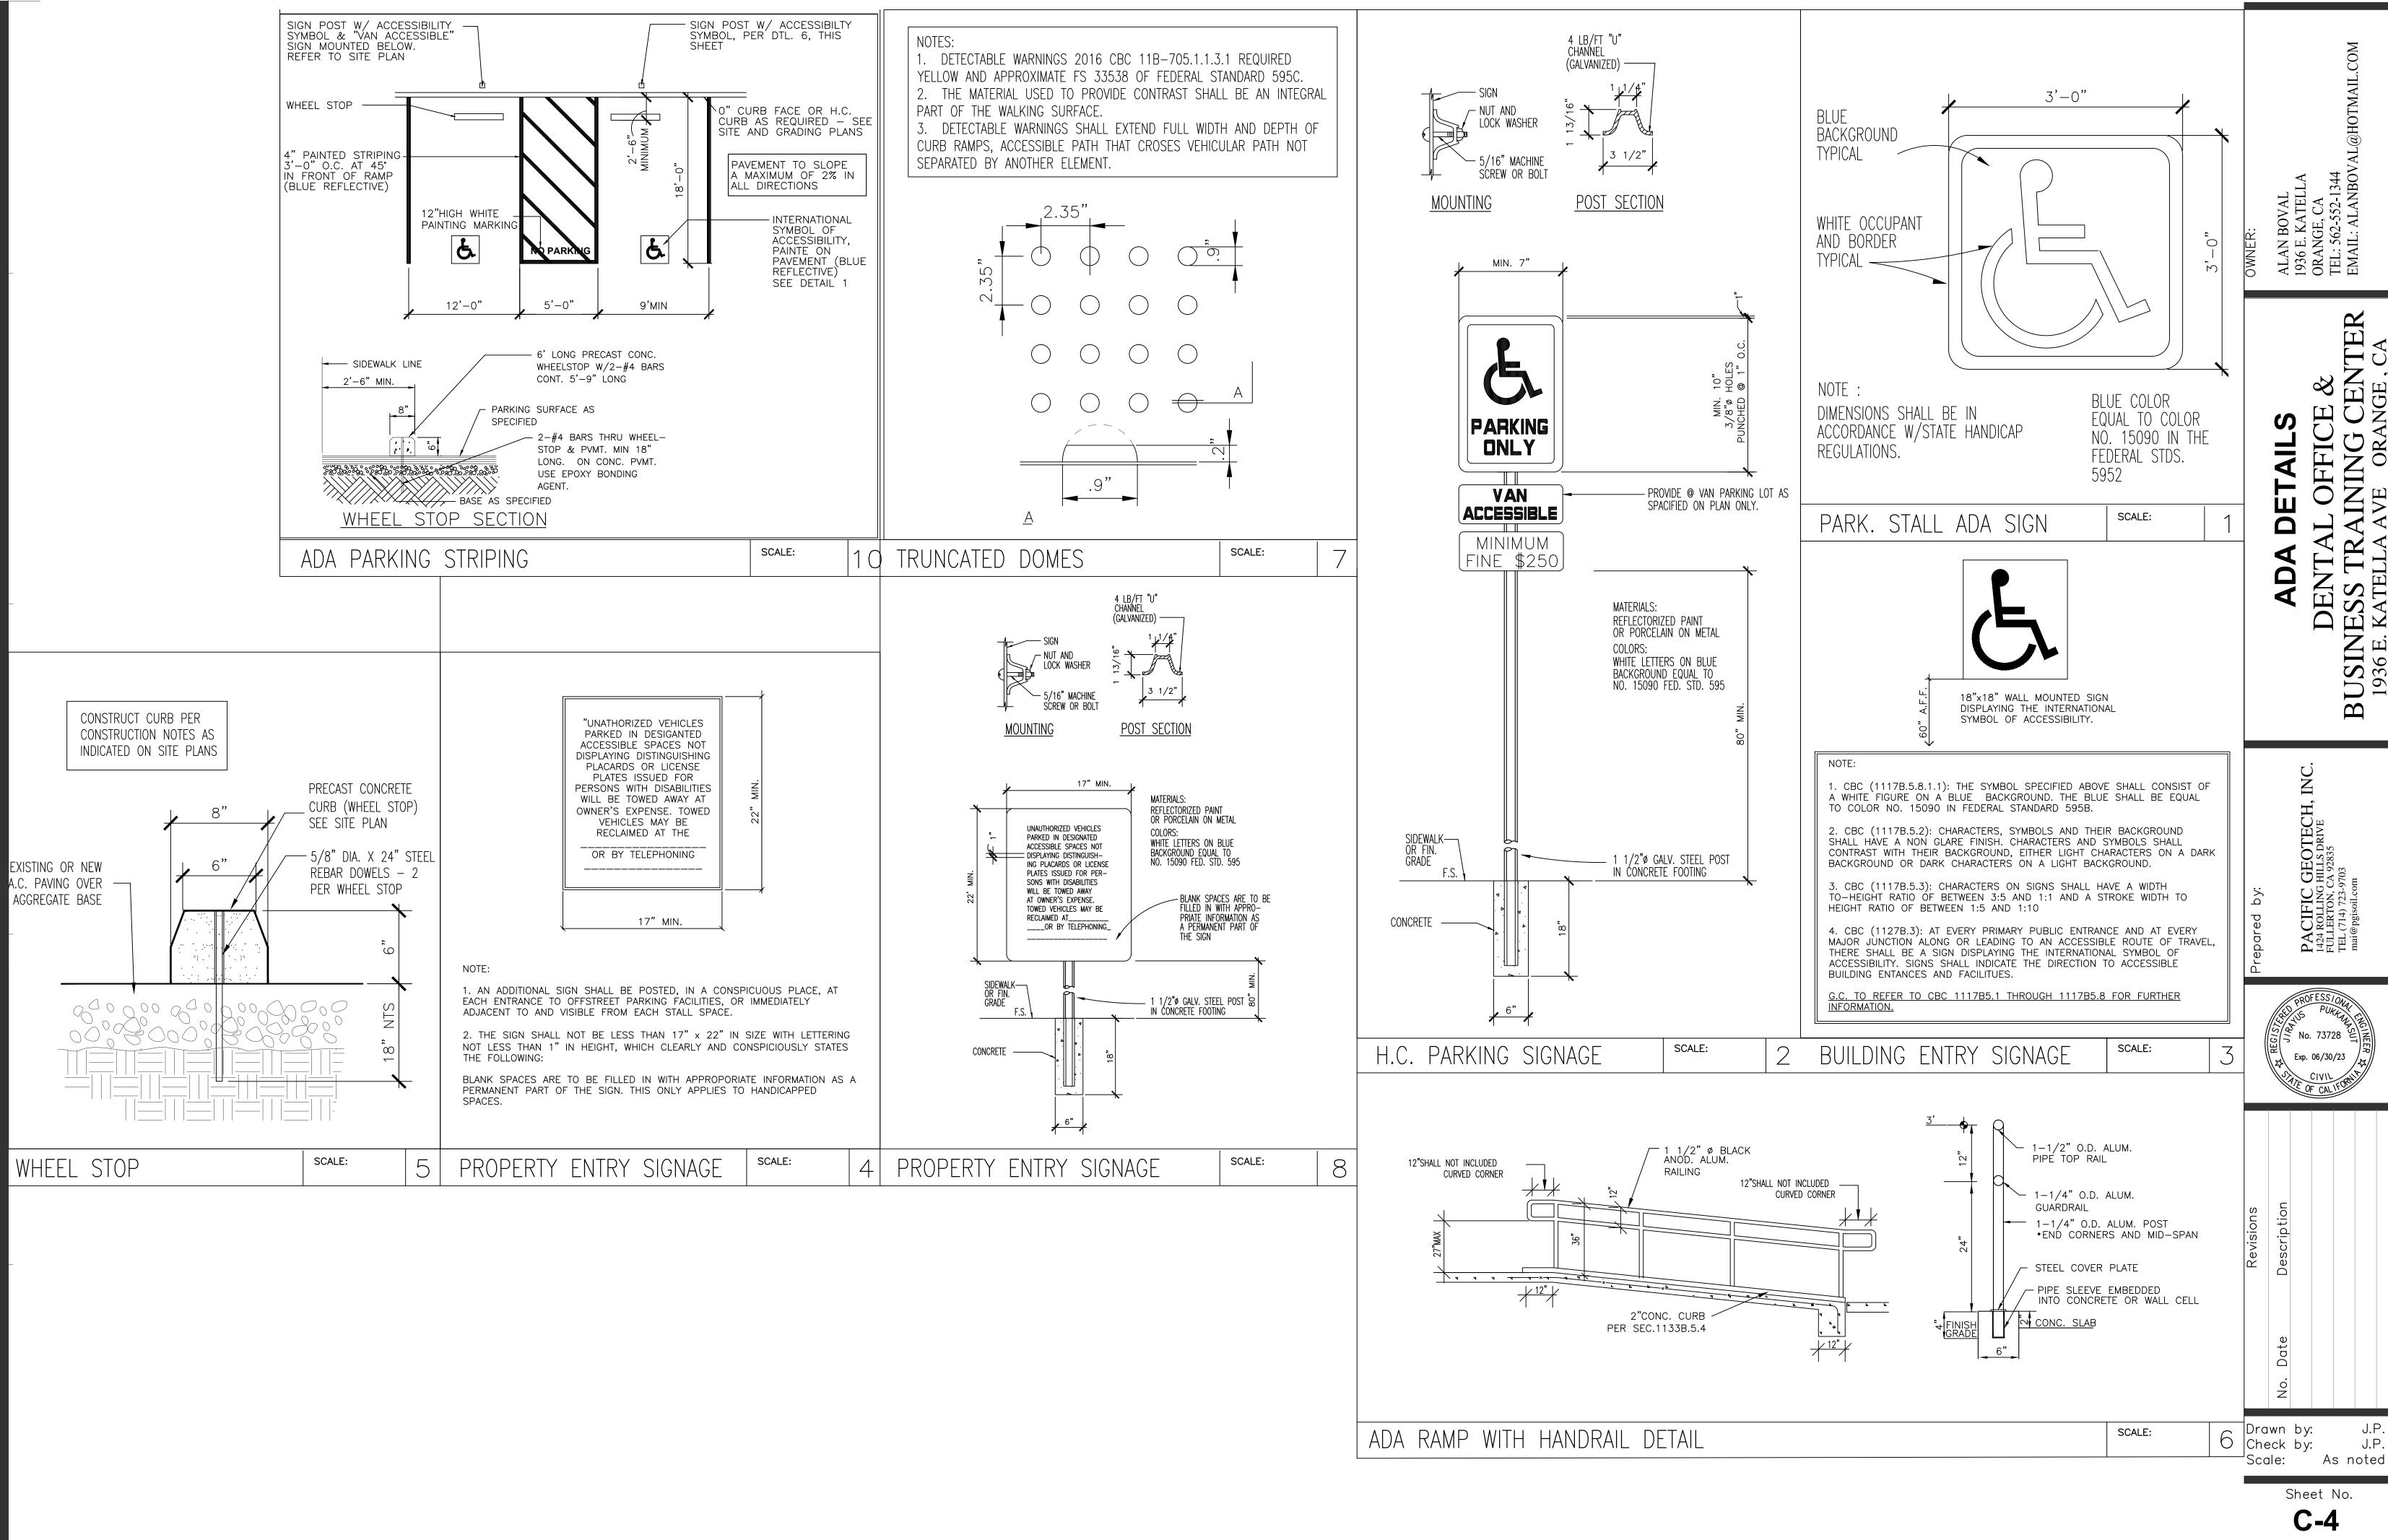


CONSTRUCTION NOTES

- (50) INSTALL CHAINLINK FENCE WITH GREEN FILTER FABRIC AS SHOWN ON PLAN
- (51) INSTALL GRAVEL BAG BERM (SE-6) PER DETAIL HEREON
- (52) INSTALL TIRE WASH PLATE (TC-1) (TC-3)
- (53) INSTALL FABRIC ON TOP OF INLET FOR INLET PROTECTION (SE-10)
- 54) CONCRETE WASHOUT AREA (WM-8)
- SWEEP STREET (SE-7) AS NEEDED TO KEEP SEDIMENT FROM ENTERING PUBLIC RIGHT OF WAY AT ALL TIMES.
- (56) VEHICLE AND EQUIPMENT AREA CLEANING (NS-8)
- (57) SPILL PREVENTION CONTROL (WM-4)



- 1. EXCESS AND WASTE CONCRETE SHALL NOT BE WASHED INTO THE STREET OR INTO A DRAINAGE SYSTEM.
- 2. FOR WASHOUT OF CONCRETE AND MORTAR PRODUCTS, A DESIGNATED CONTAINMENT FACILITY OF SUFFICIENT CAPACITY TO RETAIN LIQUID AND SOLID WASTE SHALL BE PROVIDED ON SITE.
- 3. SLURRY FROM CONCRETE AND ASPHALT SAW CUTTING SHALL BE VACUUMED OR CONTAINED, DRIED, PICKED UP AND DISPOSED OF PROPERLY.

(54) CONCRETE WASTE MANAGEMENT

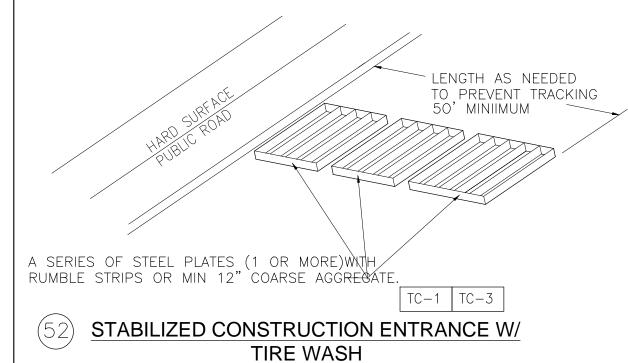

NOTES:

- 1. SEDIMENTS AND OTHER MATERIALS SHALL NOT BE TRACKED FROM THE SITE BY VEHICLE TRAFFIC. THE CONSTRUCTION ENTRANCE ROADWAYS SHALL BE STABILIZED SO AS TO PREVENT SEDIMENTS FROM BEING DEPOSITED INTO THE PUBLIC ROADS. DEPOSITIONS MUST BE SWEPT UP IMMEDIATELY AND SHOULD NOT BE WASHED DOWN BY RAIN OR OTHER MEANS INTO THE STORM DRAIN SYSTEM.
- STABILIZED CONSTRUCTION ENTRANCE SHALL BE:
- A. LOCATED AT ANY POINT WHERE TRAFFIC WILL BE ENTERING OR LEAVING A CONSTRUCTION SITE TO OR FROM A PUBLIC RIGHT OF WAY, STREET, ALLEY, AND SIDEWALK OR PARKING AREA.
 B. A SERIES OF STEEL PLATES WITH "RUMBLE STRIPS", AND/OR MIN 4" COARSE AGGREGATE WITH LENGTH, WIDTH & THICKNESS AS NEEDED TO ADEQUATLY PREVENT ANY TRACKING ONTO PAVED SURFACES.
- ADDING A WASH RACK WITH A SEDIMENT TRAP LARGE ENOUGH TO COLLECT ALL WASH WATER CAN GREATLY IMPROVE EFFICIENCY.
- . ALL VEHICLES ACCESSING THE CONSTRUCTION SITE SHALL UTILIZE THE STABILIZED CONSTRUCTION ENTRANCE SITES.



FIBER ROLL

GRAVEL BAG AROUND CATCH BASIN

STREET MAINTENANCE

- 1. REMOVE ALL SEDIMENT DEPOSITED ON PAVED ROADWAYS IMMEDIATELY.
- 2. SWEEP PAVED AREAS THAT RECEIVE CONSTRUCTION TRAFFIC WHENEVER SEDIMENT BECOMES VISIBLE.

PRIVATE ENGINEER'S NOTICE TO CONTRACTORS

THE CONTRACTOR AGREES THAT HE SHALL ASSUME SOLE AND COMPLETE RESPONSIBILITY FOR JOB SITE CONDITIONS DURING THE COURSE OF CONSTRUCTION OF THIS PROJECT, INCLUDING SAFETY OF ALL PERSONS AND PROPERTY: THAT THIS REQUIREMENT SHALL APPLY CONTINUOUSLY AND NOT BE LIMITED TO NORMAL WORKING HOURS; AND THAT THE CONTRACTOR SHALL DEFEND, INDEMNIFY, AND HOLD THE OWNER AND THE ENGINEER HARMLESS FROM ANY AND ALL LIABILITY, REAL OR ALLEGED, IN CONNECTION WITH THE PERFORMANCE OF WORK ON THIS PROJECT, EXCEPTING FOR LIABILITY ARISING FROM THE SOLE NEGLIGENCE OF THE OWNER OR THE ENGINEER.

SANDBAGS STACKED MIN. 3 HIGH


FINISHED OR
EXISTING GRADE

SANDBAG STACKING
NO SCALE

TROL PLA

PACIFIC GEOTECH, I 1424 ROLLING HILLS DRIVE FULLERTON, CA 92835 TEL (714) 723-9703

B

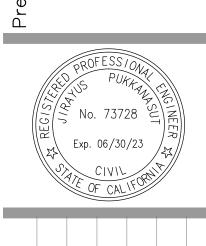

Revisions Date Description

Drawn by: J.P.
Check by: J.P.
Scale: As noted

Sheet No.

C-:

Date 7-28-2021

SCALE || = 10:



SOUTH ELEVATION



EAST ELEVATION (FACING FWY 55)

ALAN BOVAL (OWNER)

G&L Design Consultants 16327 Willowmist Ct Chino Hills CA 91709 (909)851-6252 GLDesignco@aol.com



NORTH ELEVATION




PROPOSED DENTAL AND TRAINING CENTER 1936 E. Katella Ave Orange CA 92867

ALAN BOVAL (OWNER)

G&L Design Consultants 16327 Willowmist Ct Chino Hills CA 91709 (909)851-6252 GLDesignco@aol.com

YMBOL	BOTANICAL NAME	COMMON NAME	SIZE	QUANTITY	NOTES	
	TREES				TOTAL TREES = 28	
CE	CERCIS CANADENSIS 'OKLAHOMA'	OKLAHOMA REDBUD	24" BOX	9	REFER TO DETAIL FOR TYPICAL TREE INSTALLATION	
СН	CHITALPA TASHKENTENSIS 'PINK DAWN'	PINK DAWN CHITALPA	24" BOX	4	REFER TO DETAIL FOR TYPICAL TREE INSTALLATION	
GJ	GEIJERA PARVIFLORA	AUSTRALIAN WILLOW	24" BOX	6	REFER TO DETAIL FOR TYPICAL TREE INSTALLATION	
OL	OLEA EUROPAEA MONHER	MAJESTIC BEAUTY FRUITLESS OLIVE TREE	24" BOX	6	REFER TO DETAIL FOR TYPICAL TREE INSTALLATION	
UM	UMBELLULARIA CALIFORNICA	CALIFORNIA BAY TREE	24" BOX	4	REFER TO DETAIL FOR TYPICAL TREE INSTALLATION	
	SHRUBS					
Ag	AGAVE OVATIFOLIA	WHALES TONGUE AGAVE	5 GAL	2	REFER TO DETAIL FOR TYPICAL SHRUB INSTALLATION	
A1	ANIGOZANTHOS 'BUSH RANGER'	DWARF KANGAROO PAW	1 GAL	10	REFER TO DETAIL FOR TYPICAL SHRUB INSTALLATION	
A2	ANIGOZANTHOS 'ORANGE CROSS'	ORANGE KANGAROO PAW	5 GAL	13	REFER TO DETAIL FOR TYPICAL SHRUB INSTALLATION	
At	ARTEMESIA 'POWIS CASTLE'	POWIS CASTLE WORMWOOD	5 GAL	12	REFER TO DETAIL FOR TYPICAL SHRUB INSTALLATION	
Ca	CALAMAGROSTIS x ACUTIFLORA 'KARL FOERSTER'	FEATHER REED GRASS	5 GAL	6	REFER TO DETAIL FOR TYPICAL SHRUB INSTALLATION	
CI	CALOTHAMNUS QUADRIFIDUS 'SEASIDE'	SEASIDE ONE-SIDED BOTTLEBRUSH	5 GAL	3	REFER TO DETAIL FOR TYPICAL SHRUB INSTALLATION	
Cn1	CHONDROPETALUM ELEPHANTINUM	LARGE CAPE RUSH	5 GAL	2	REFER TO DETAIL FOR TYPICAL SHRUB INSTALLATION	
Cn2	CHONDROPETALUM TECTORUM	SMALL CAPE RUSH	5 GAL	2	REFER TO DETAIL FOR TYPICAL SHRUB INSTALLATION	
Gp	GREVILLEA LANIGERA 'PROSTRATE'	PROSTRATE WOOLLY GREVILLEA	1 GAL	14	REFER TO DETAIL FOR TYPICAL SHRUB INSTALLATION	
Gr	GREVILLEA 'LONG JOHN'	LONG JOHN GREVILLEA	5 GAL	8	REFER TO DETAIL FOR TYPICAL SHRUB INSTALLATION	
He	HESPERALOE PARVIFLORA	RED YUCCA	5 GAL	3	REFER TO DETAIL FOR TYPICAL SHRUB INSTALLATION	
L1	LAVANDULA STOECHAS	SPANISH LAVENDER	1 GAL	22	REFER TO DETAIL FOR TYPICAL SHRUB INSTALLATION	
La2	LAVANDULA x INTERMEDIA 'PROVENCE'	BLUE LAVANDER	1 GAL	25	REFER TO DETAIL FOR TYPICAL SHRUB INSTALLATION	
Le	LEONOTIS LEONURUS	LION'S TAIL	5 GAL	4	REFER TO DETAIL FOR TYPICAL SHRUB INSTALLATION	
Ly	LEUCOPHYLLUM LANGMANIAE 'BRAVE RIVER'	BRAVE RIVER TEXAS RANGER	5 GAL	19	REFER TO DETAIL FOR TYPICAL SHRUB INSTALLATION	
Ns	NASSELLA TENUISSIMA	MEXICAN FEATHER GRASS	1 GAL	13	REFER TO DETAIL FOR TYPICAL SHRUB INSTALLATION	
Ph1	PHORMIUM 'FITO1' PLANT PATENT	BLACK ADDER FLAX	5 GAL	3	REFER TO DETAIL FOR TYPICAL SHRUB INSTALLATION	
Ph2	PHORMIUM 'RAINBOW MAIDEN'	RAINBOW MAIDEN NEW ZEALAND FLAX	5 GAL	11	REFER TO DETAIL FOR TYPICAL SHRUB INSTALLATION	
We1	WESTRINGIA FRUTICOSA MUNDI	LOW COAST ROSEMARY	1 GAL	7	REFER TO DETAIL FOR TYPICAL SHRUB INSTALLATION	
We2	WESTRINGIA 'WYNYABBIE GEM'	COAST ROSEMARY	5 GAL	4	REFER TO DETAIL FOR TYPICAL SHRUB INSTALLATION	
	GROUND COVER					
dy	DYMONDIA MARGARETAE	SILVER CARPET	FLATS		TRIANGULAR SPACING @ 12" ON CENTER	
my	MYOPORUM PARVIFOLIUM 'FINE LEAF FORM'	FINE-LEAF GROUND COVER MYOPORUM	FLATS		TRIANGULAR SPACING @ 24" ON CENTER	
os	OSCULARIA DELTOIDES	PINK ICEPLANT	FLATS		TRIANGULAR SPACING @ 18" ON CENTER	
sd	SEDUM RUPESTRE 'ANGELINA'	GOLDEN SEDUM	FLATS		TRIANGULAR SPACING @ 12" ON CENTER	
sn	SENECIO MANDRALISCAE	KLEINIA	FLATS		TRIANGULAR SPACING @ 12" ON CENTER	

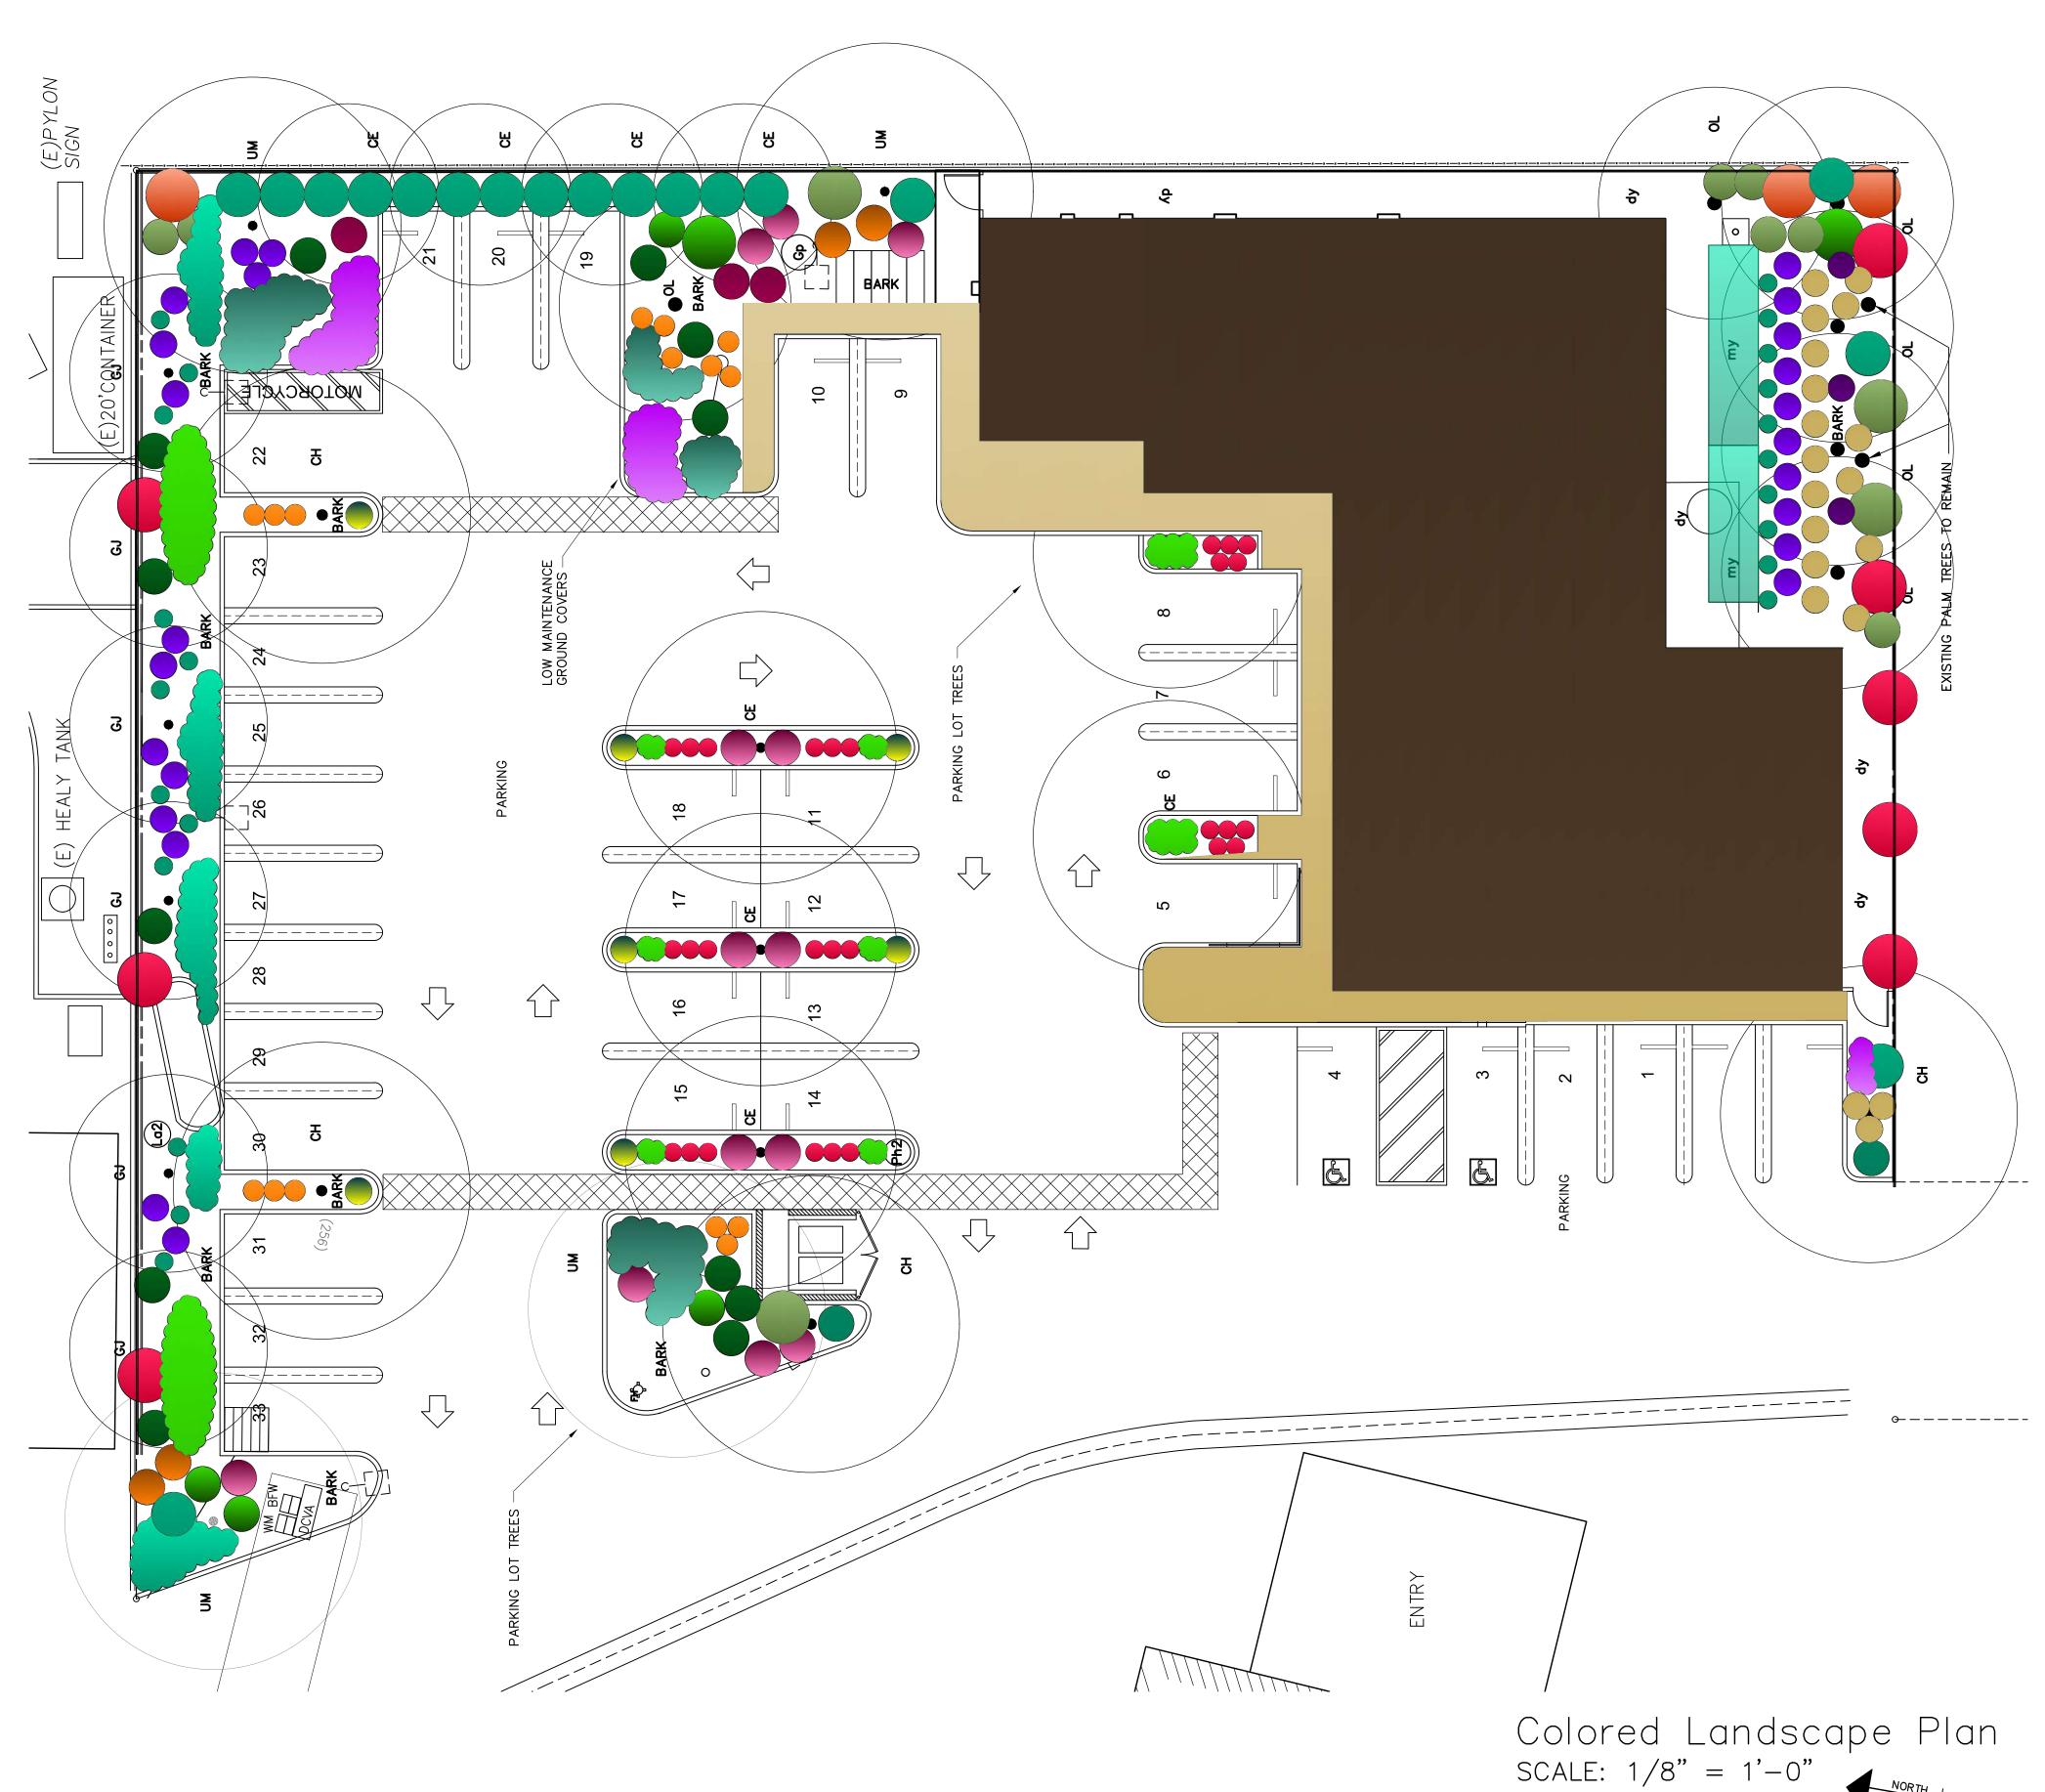


Contractors shall verify all field conditions for conformance to drawings before starting construction. All measurements are subject to verification by the contractor and he shall notify Environmental Design Sysytems, Inc. of any discrepancies prior to fabrication or construction.

Dental Office

1936 E. Katella Ave. Orange, CA 92867

Job Title - Address Owner - Address

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LeisureLand

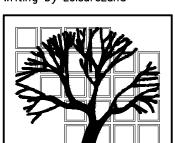Landscape

Architecture Construction Management


2131 Minoru Drive Altadena, CA 91001

Phone (818) 437-5254 rleisureland@gmail.com

Consultants These drawings are to be con—sidered preliminary and are not approved for construction until the owner and the Landscape Architect have signed below. These drawings are not to be used for construction by the contractor until the contractor has signed below. Signatures below by Owner and Contractor indicate a complete review and knowledge of the scope, contents, and conditions as set forth in these documents.

Landscape Architect


Revisions

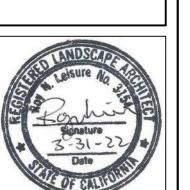

E. Katella

September 10, 2021

Colored Landscape Plan Sheet Title Sheet Number

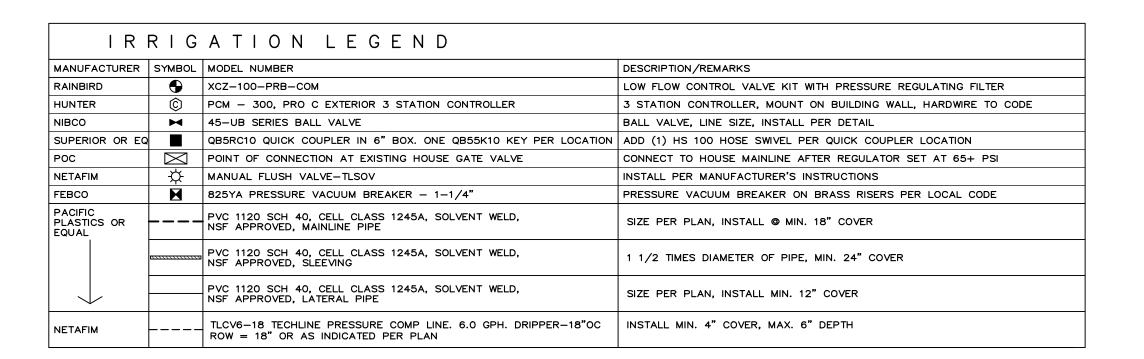

IRRIGATION NOTES:

DETAIL.

1. IRRIGATION SYSTEM IS DESIGNED AT A MINIMUM PRESSURE OF 60 PSI AND MAXIMUM OF 120 PSI. POINT OF CONNECTION SHALL BE AT NEW WATER METER - LOCATION TO BE DETERMINED. REFER TO ARCHITECTS DRAWINGS.

CAUTION: VERIFY PRESSURE DURING INSTALLATION AND CONTACT ARCHICTECT FOR PRESSURE OUTSIDE OF DESIGNED RANGE

2. PLANS ARE DIAGRAMMATIC. PLACE ALL MAINLINES AND LATERALS IN PLANTER OR LAWN AREAS <u>INSIDE</u> PROPERTY LINE OR APPROVED AREAS WITHIN THE PUBLIC RIGHT OF WAY. LOCATION OF PRIVATE DRIVE PAVING SHALL BE VERIFIED PRIOR TO INSTALLATION AND FIELD ADJUSTMENTS SHALL BE MADE TO PROTECT IRRIGATION

PLACE ALL VALVES, HOSE BIBS AND PVBS IN PLANTER AREAS. ALL CONTROL VALVES SHALL BE INSTALLED IN VALVE BOXES PER

3. ALL IRRIGATION SYSTEMS SHALL BE INSTALLED AND ADJUSTED TO MINIMIZE OVERSPRAY ON WALLS AND PAVING. MODIFICATIONS TO IRRIGATION SYSTEMS MUST BE APPROVED BY THE LANDSCAPE ARCHITECT.

4. GENERAL CONTRACTOR SHALL SUPPLY GFI ELECTRICAL OUTLET FOR WALL MOUNTED IRRIGATION CONTROLLER CONNECTION. LANDSCAPE CONTRACTOR SHALL HARDWIRE CONTROLLER PER LOCAL CODES. VERIFY LOCATION IN FIELD.

TITLE 23 NOTES:

1. I AGREE TO COMPLY WITH THE REQUIREMENTS OF THE WATER EFFICIENT LANDSCAPE ORDINANCE AND SUBMIT A COMPLETE LANDSCAPE DOCUMENTATION PACKAGE.

2. I HAVE COMPLIED WITH THE CRITERIA OF THE ORDINACNCE AND APPLIED THEM FOR THE EFFICIENT USE OF WATER IN THE LANDSCAPE DESIGN PLANS.


3. A CERTIFICATE OF COMPLETION SHALL BE FILLED OUT AND CERTIFIED BY EITHER THE DESIGNER OF THE LANDSCAPE PLANS, IRRIGATION PLANS, OR THE LICENSED LANDSCAPE CONTRACTOR FOR THE PROJECT.


3. RECIRCULATING WATER SYSTEMS SHALL BE USED FOR WATER FEATURES.

4. A MINIMUM 3 INCH LAYER OF MULCH SHALL BE APPLIED ON ALL EXPOSED SOIL SURFACES OF PLANTING AREAS EXCEPT TURF AREAS, CREEPING OR ROOTING GROUND COVERS, OR DIRECT SEEDING APPLICATIONS WHERE MULCH IS CONTRAINDICATED.

5. FOR SOILS LESS THAN 6% ORGANIC MATTER IN THE TOP 6 INCHES OF SOIL, COMPOST AT AT RATE OF A MINIMUM OF FOUR CUBIC YARDS PER 1.000 SQUARE FEET OF PERMEABLE AREA SHALL BE INCORPORATED TO A DEPTH OF 6 INCHES INTO THE SOIL.



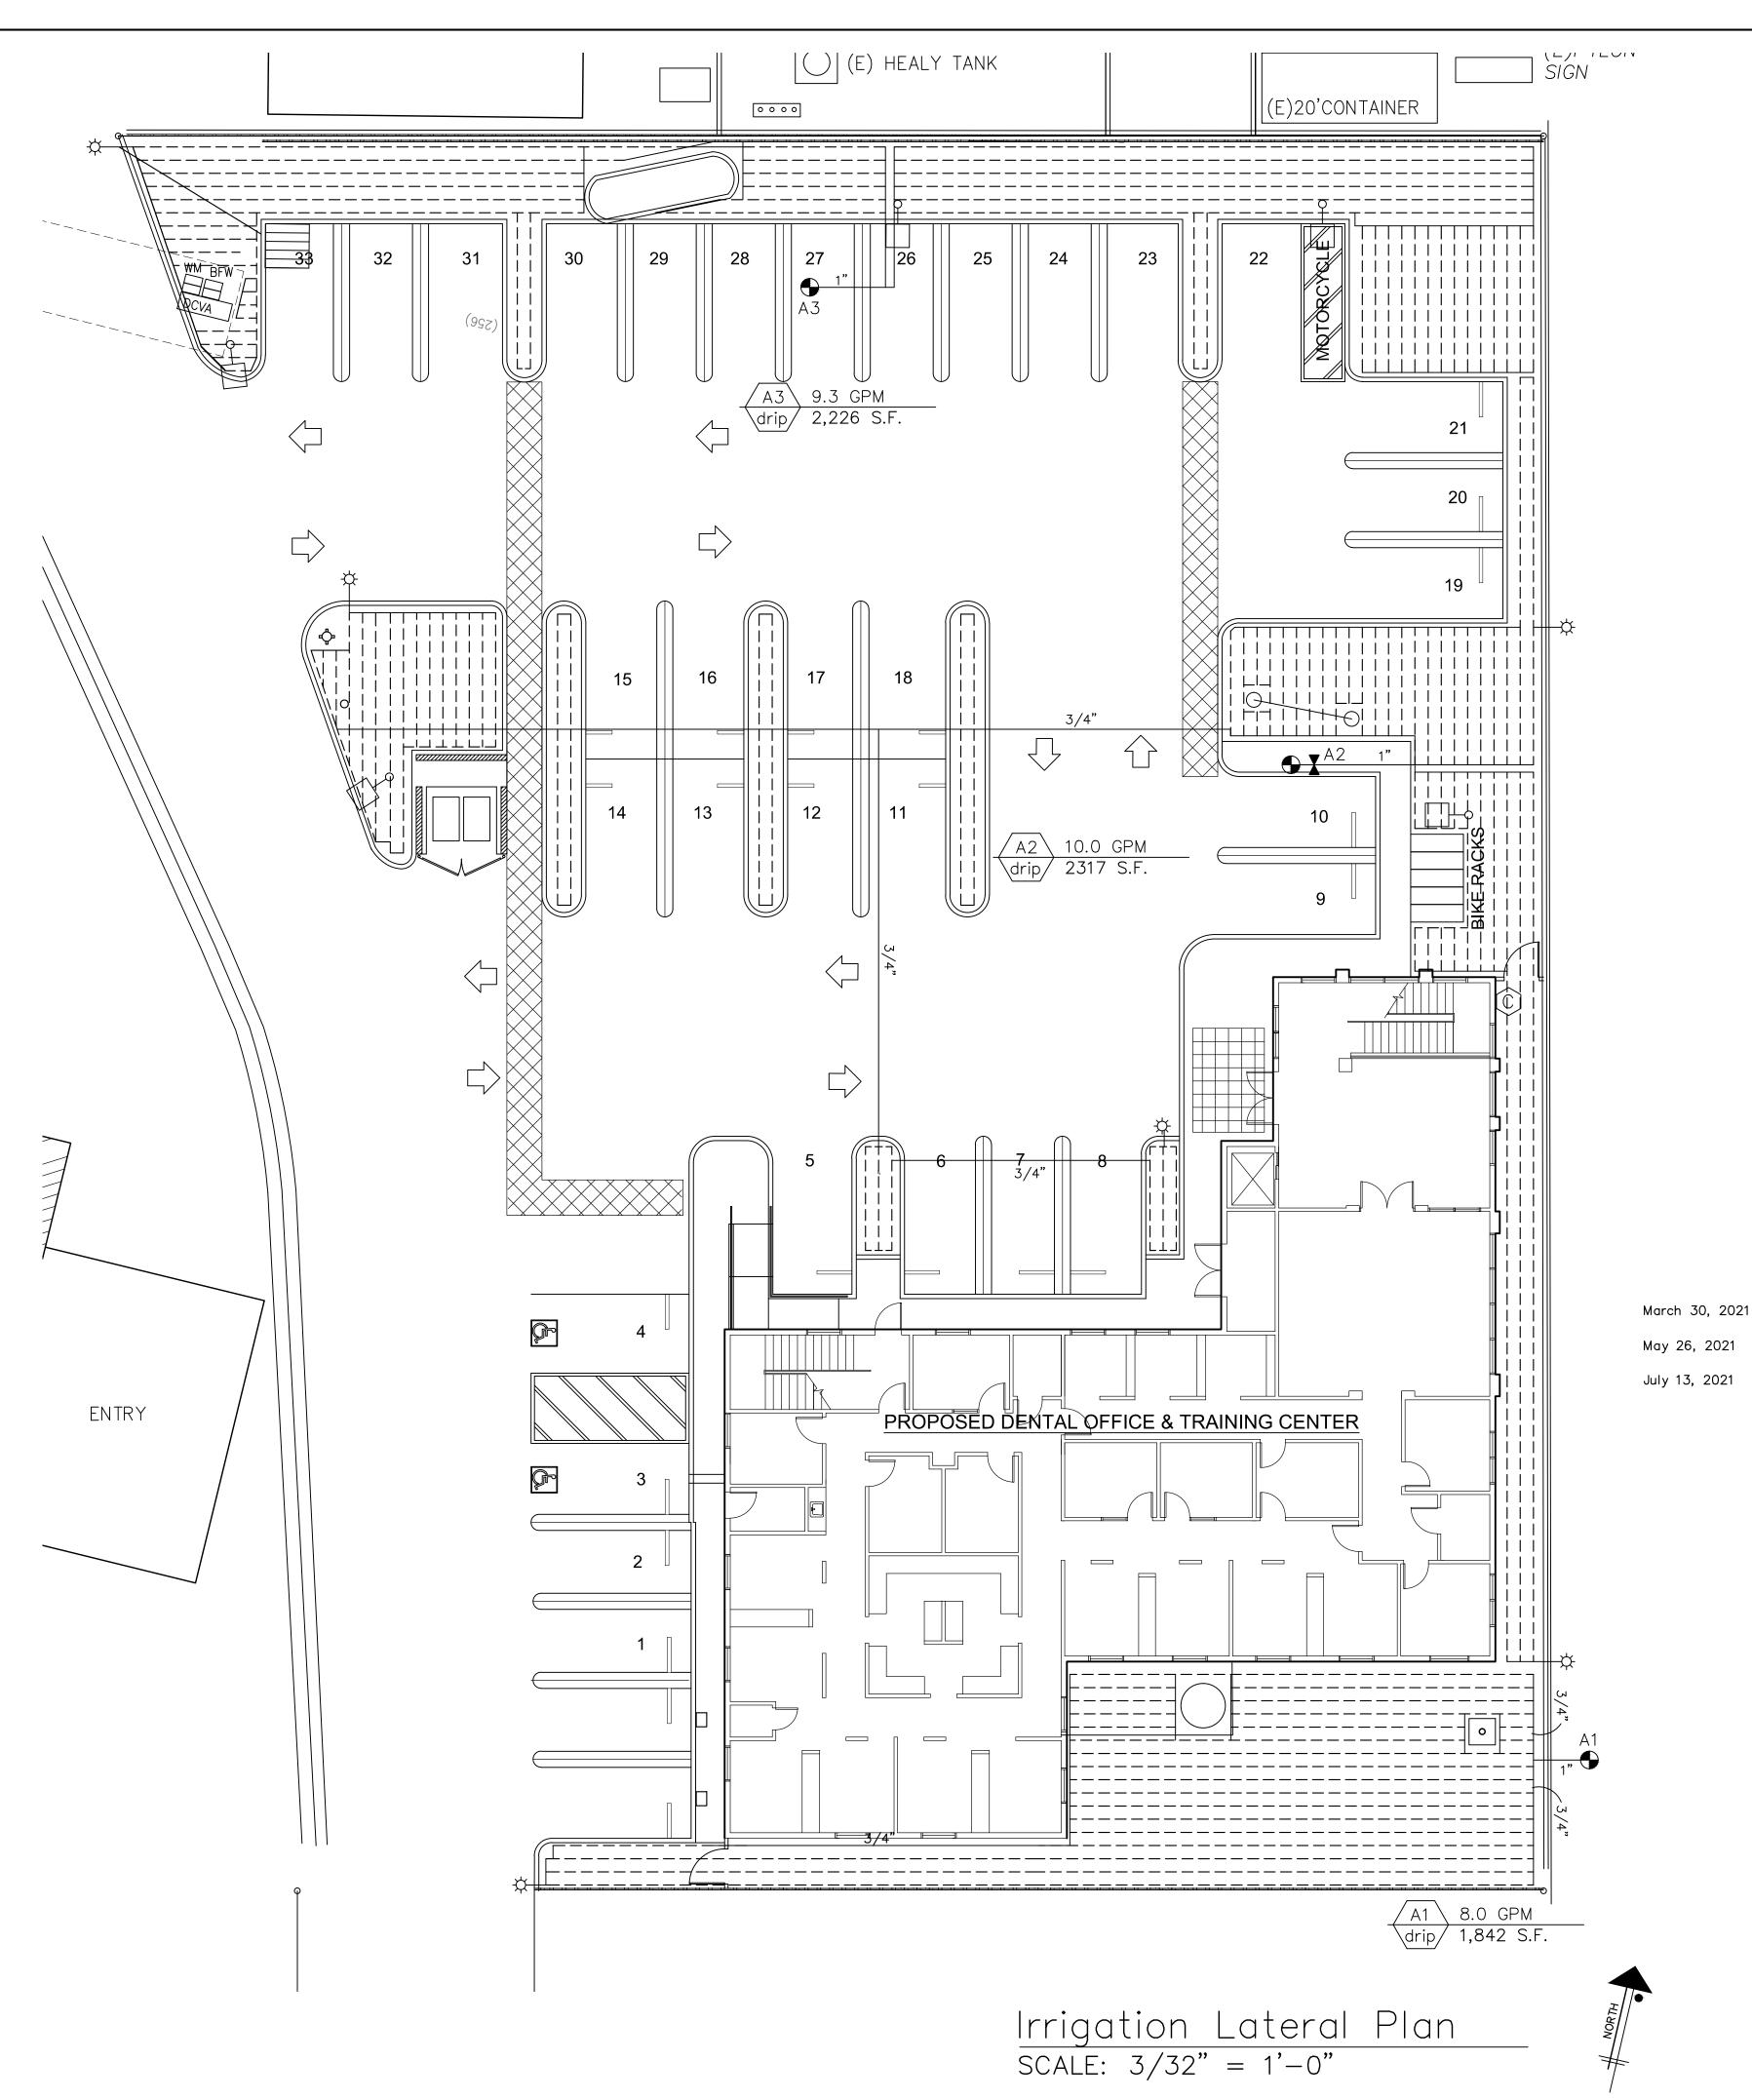

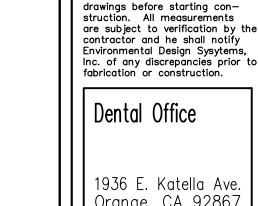


Dental Office

Contractors shall verify all field conditions for conformance to

1936 E. Katella Ave. Orange, CA 92867

> Job Title — Address Owner – Address

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_eisureLand

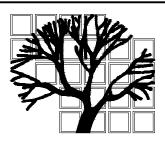Management

Landscape Architecture Construction

2131 Minoru Drive

Altadena, CA 91001 Phone (818) 437-5254 rleisureland@gmail.com

Consultants

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Contractor

Landscape Architect

Revisions September 12, 2019 February 6, 2020

February 28, 2020

April 21, 2020

December 4, 2020 January 4, 2021



Katella Job Number

3/32" = 1'-0"

November 12, 2018

Irrigation Lateral Sheet Title

Sheet Number



Serving the following California Counties: Imperial, Inyo, Los Angeles, Orange, Riverside, San Bernardino, San Diego, Santa Barbara and

Underground Service Alert Of Southern California

811 or 800-422-4133

Details

Visit Website

Address: PO Box 77070 Corona, CA 92877

M - F 0600-1900

Advanced Notice: 2 working days, not including the date of motivation, but not more than 14 calendar

Number of days in advance of a digging project that you need to notify the one call center of your intent to

MANUFACTURER	SYMBOL	MODEL NUMBER	DESCRIPTION/REMARKS
RAINBIRD	•	XCZ-100-PRB-COM	LOW FLOW CONTROL VALVE KIT WITH PRESSURE REGULATING FILTER
HUNTER	©	PCM - 300, PRO C EXTERIOR 3 STATION CONTROLLER	3 STATION CONTROLLER, MOUNT ON BUILDING WALL, HARDWIRE TO CODE
NIBCO	M	45-UB SERIES BALL VALVE	BALL VALVE, LINE SIZE, INSTALL PER DETAIL
SUPERIOR OR EQ		QB5RC10 QUICK COUPLER IN 6" BOX. ONE QB55K10 KEY PER LOCATION	ADD (1) HS 100 HOSE SWIVEL PER QUICK COUPLER LOCATION
POC	\bowtie	POINT OF CONNECTION AT EXISTING HOUSE GATE VALVE	CONNECT TO HOUSE MAINLINE AFTER REGULATOR SET AT 65+ PSI
NETAFIM	☆	MANUAL FLUSH VALVE-TLSOV	INSTALL PER MANUFACTURER'S INSTRUCTIONS
FEBCO	M	825YA PRESSURE VACUUM BREAKER - 1-1/4"	PRESSURE VACUUM BREAKER ON BRASS RISERS PER LOCAL CODE
PACIFIC PLASTICS OR EQUAL		PVC 1120 SCH 40, CELL CLASS 1245A, SOLVENT WELD, NSF APPROVED, MAINLINE PIPE	SIZE PER PLAN, INSTALL @ MIN. 18" COVER
		PVC 1120 SCH 40, CELL CLASS 1245A, SOLVENT WELD, NSF APPROVED, SLEEVING	1 1/2 TIMES DIAMETER OF PIPE, MIN. 24" COVER
\downarrow		PVC 1120 SCH 40, CELL CLASS 1245A, SOLVENT WELD, NSF APPROVED, LATERAL PIPE	SIZE PER PLAN, INSTALL MIN. 12" COVER
NETAFIM		TLCV6-18 TECHLINE PRESSURE COMP LINE. 6.0 GPH. DRIPPER-18"OC ROW = 18" OR AS INDICATED PER PLAN	INSTALL MIN. 4" COVER, MAX. 6" DEPTH

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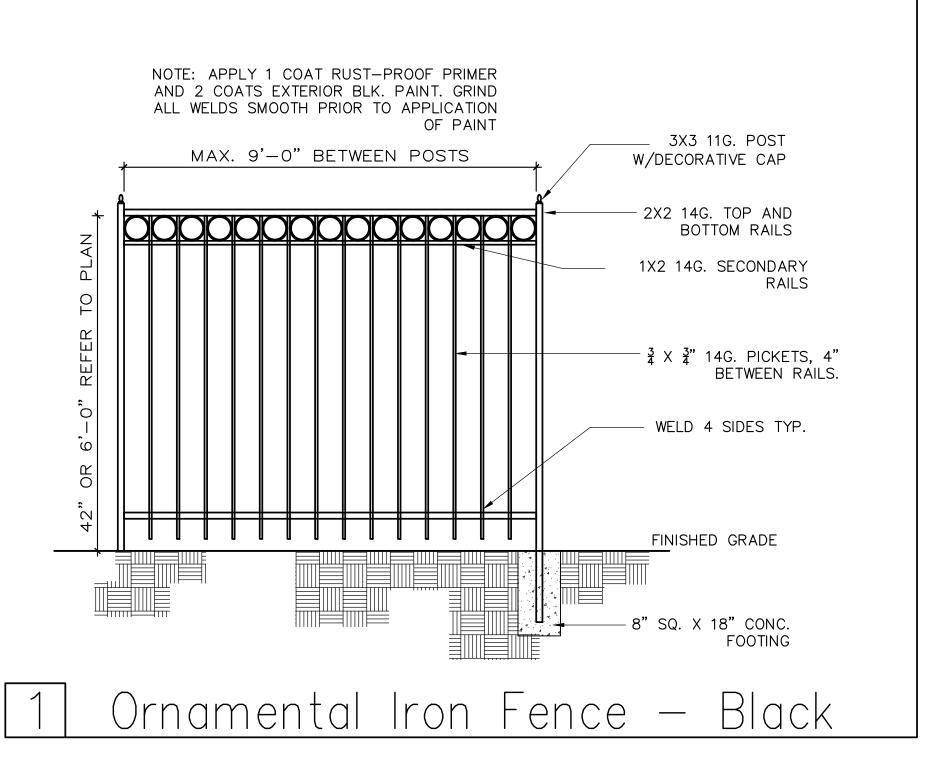
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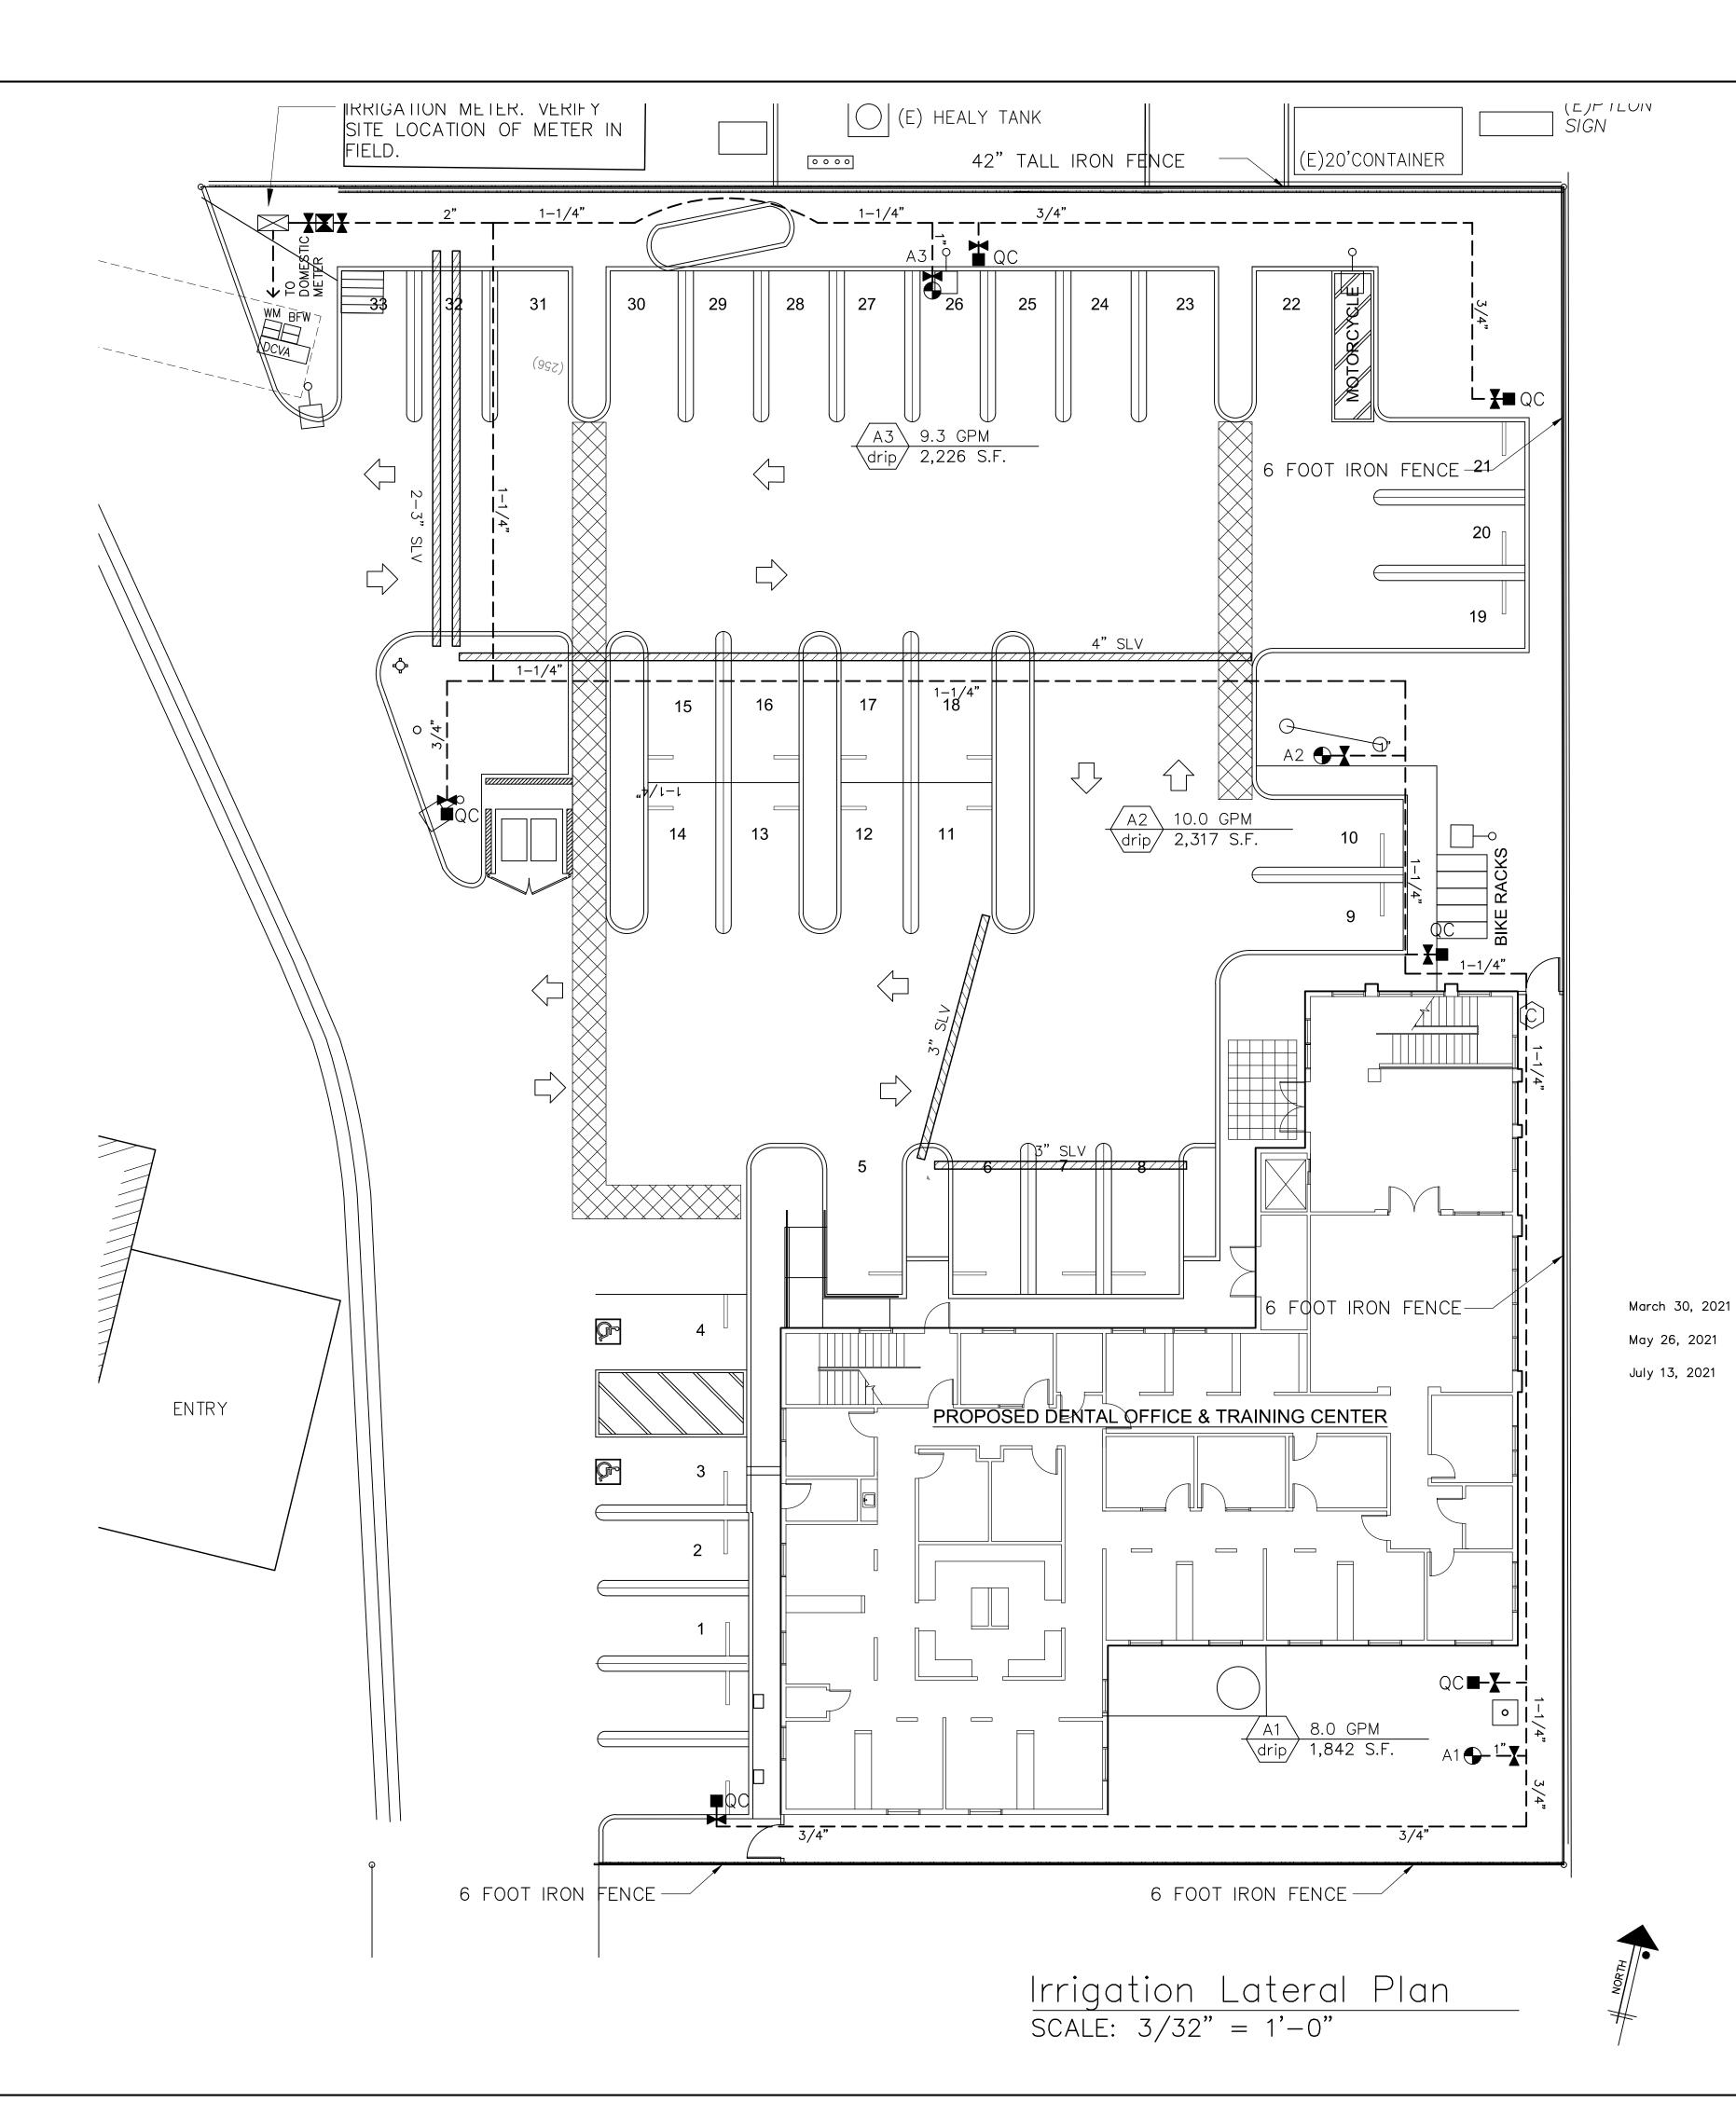
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Dental Office

1936 E. Katella Ave. Orange, CA 92867

fabrication or construction.

Job Title — Address

Owner — Address

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LeisureLand

Landscape Architecture

Construction Management

2131 Minoru Drive Altadena, CA 91001

Phone (818) 437-5254 rleisureland@gmail.com Consultants These drawings are to be con-

sidered preliminary and are not approved for construction until the owner and the Landscape Architect have signed below. These drawings are not to be used for construction by the contractor until the contractor has signed below. Signatures below by Owner and Contractor indicate a complete review and knowledge of the scope, contents and conditions as set contents, and conditions as set forth in these documents.

Landscape Architect

Revisions September 12, 2019

February 6, 2020

February 28, 2020 April 21, 2020

December 4, 2020

January 4, 2021



. Katella Job Number

3/32" = 1'-0"

November 12, 2018

Irrigation Mainline Sheet Title Sheet Number

CERTIFICATE OF SUBSTANTIAL COMPLETION

March 30, 2021

Project Data:

Project Site: Dental Office

1936 E. Katella Avenue, Orange, CA 92867 Location: Landscape Architect: LeisureLand Irrigation Designer: LeisureLand

Total Landscape Area: 6,385 s.f. Historical Evaporation ETo: 50.1 inches/year Maximum applied Water allowance: 89,249 gal./year 73,456 gal./year Estimated Applied Water Use:

Estimated amount of water expected from effective

precipitation: non expected

Estimated Total Adjusted

Applied Water Use: 73,456 gal./year

The following may be included in this project submittal package, if applicable:

1. Landscape Design Plan 2. Irrigation Design Plan

3. Irrigation Schedule 4. Landscape/Irrigation Audit Schedule

5. Hydro zone Report(s)

Post Installation Inspection: (Check to indicate substantial completion)

1. Plants installed as specified 2. Irrigation system installed as designed

a. Minimal run-off or over spray 3. Landscape irrigation audit performed

4. Project submittal package and a copy of this certification has been provided to

Owner/Manager and local water agency.

Comments:

Consultant

I/We certify that the work has been installed in accordance with the Contract Documents.

Contractor State Lic. No.

I/We certify that based upon periodic site observations, the work has been substantially completed in accordance with the Water Efficient Landscape Ordinance and that the landscape planting and irrigation installation conform with the approved plans and specifications.

State Lic. No. Landscape architect Signature or Irrigation Designer/

I/We certify that I/we received all of the Contract Documents and that it is our responsibility to see that the project is maintained in accordance with the Contract Documents.

Signature Date

IRRIGATION WATER SCHEDULE

For: Dental Office, 1936 E. Katella Avenue, Orange, CA 92867 Historical Annual Eto = 50.1 in./yr. Date: March 30, 2021

The following irrigation schedule is shown for guideline use only and is to be modified in the field accordingly, as the weather changes and/or water audit dictates.

the irrigation schedule is based on historical evapotranspiration rates for the Orange area. More accurate daily data can be obtained by contacting:

> California Department of Water Resources Water Conservation Office Division of Local Assistance River City Bank Building

1020 Ninth Street, 3rd floor Sacramento, CA 95814 tel. (916) 327-1836

The precipitation rate for each valve has been calculated based ont the square foot area of coverage for each valve and the total gallon per minute for each valve. see Irrigation Plan as prepared by Environmental Design Systems,Inc.

The distribution efficiency used is based on the anticipated distribution efficiency of a well designed and installed irrigation system with the materials currently available on the market. According to the Center of Irrigation Technology, spray head systems under laboratory conditions can have a distribution efficiency of 50-60% and for rotors systems, 75-90%. As such, 50% was used for spray heads and 75% for rotors. These two distribution efficiencies were assumed and might change in the field dependent upon the actual conditions encountered and the dictates of a water gudit.

The numbers shown on the following Irrigation Water Schedule are the minutes per day for each station in a 7-day week. Theatrically, December through March no irrigation is required, but watering to some degree may be necessary. Unusually hot weather will require irrigation adjustments as weather changes.

Contractor/Owner shall manage water in conjunction with the Irrigation Schedule submitted as part of the Landscape Documentation package and approved by the City of Orange. It shall be the Contractor/Owner's responsibility to evaluate the results of this schedule and adjust the watering schedule as needed to assure plant survival while using the least amount of water possible. The need for water shall dictate the frequency of watering by the automatic sprinkler system, exact amount of moisture replacement shall be governed by current weather conditions, soil type, plant material type, and other environmental and cultural factors as dictated by the project site. Contractor/Owner shall be expected to use minimal amount of water in all areas to sustain healthy plant growth. Plant material shall be watered at such frequency as weather conditions require to replenish soil moisture below root zone. Water run-off across pavements and into gutters shall be avoided. It shall be the Contractor's responsibility to monitor water use as necessary for healthy growth of plant material, conservation of water, and public safety. Where moisture sensing devices are used, continual monitoring will be made to assure units are functioning properly. Hours of scheduled operation will be programmed to prevent possible nuisance from sprinkler operation to pedestrians and vehicles. Any repairs necessary to keep the system operating in its intended designed state shall be made by the Contractor in accordance with the original plans, specifications, and details.

WATER CONSERVATION CONCEPT STATEMENT

March 3, 2021

Project Data:

Project Site: Dental Office 1936 E. Katella Avenue, Orange, CA 92867 Location: Landscape Architect: LeisureLand Irrigation Designer: LeisureLand

Total Landscape Area: 6,385 s.f. Historical Evaporation ETo: 50.1 inches/year Maximum applied Water allowance: 89,249 gal./year Estimated Applied Water Use: 73,456 gal./year

Estimated amount of water expected from effective precipitation: non expected

Estimated Total Adjusted Applied Water Use: 73,456 gal./year

The following may be included in this project submittal package, if applicable:

1. Landscape Design Plan

2. Irrigation Design Plan Irrigation Schedule

4. Landscape/Irrigation Audit Schedule

5. Hydro-zone Report(s)

Description of Project:

The particular phase of this project consists of landscaping for a restaurant development in the City of Orange. The landscape is composed of drought tolerant trees and ground covers. There are no areas of turf. The site will be irrigated by a conventional irrigation system of drip emitters. The irrigation plan was designed by LeisureLand, Landscape Architects. The calculations for this Concept Statement, Irrigation Schedule, and Hydro-zone Summary Report were prepared by Environmental Design Systems, Inc., based upon square foot areas for each hydro-zone, GPM per valve, and plant materials.

Comments:

The estimated annual water use has been calculated using an irrigation efficiency of 0.625. This irrigation efficiency may vary in the field. It is dependent upon weather changes, soil types, degree of slopes and accuracy of the manufacturer's literature. Sprinklers may deliver different performances from what is anticipated by the "Water Conservation in Landscaping Act" (AB325), i.e., drip line, when installed per manufacturer's instructions, may not have 62.5% efficiency as anticipated by AB325. this condition exists outside the control of the designer and the preparation of this Concept Statement. The theoretical performance and the irrigation distribution efficiency may not match actual field conditions. Also, estimated annual water use (EAWU) may be subject to change based upon water audit and weather changes.

The maximum allowable water budget has been calculated using the following formula:

MAWA = (ETo)(0.7)(LA)(0.62)MAWA= maximum allowable water budget (gal./year) ETo= reference evapo-transpiration (in./yr.) for City of Orange areas is 50.1 in./yr. 0.7= adjustment factor LA= landscape area (sq. Ft.)

PROJECT MAWA: (50.1)(.45)(6,385)(0.62) = 89,249 GAL/YR

The estimated applied water use has been calculated using the following formula: EAWU= (ETo)(KI/IE)(LA)(0.62)

EAWU= estimated applied water use (gal./vr/) ETo= reference evapotranspiration (in./yr/) for Los Angeles (Orange) is 50.1 in./yr.

KI= landscape coefficient (crop coefficient) for trees shrubs, and ground covers is estimated to be 0.3, for lawn 0.6 IE= irrigation efficiency, 81%, 75%

LA= landscape area (sq.ft.) 0.62= conversion factor

PROJECT EAWA: Refer to Schedules Below

Maintenance Schedule. It is recommended that during the irrigation season, the irrigation system be checked and repaired once a week replacing any broken heads and realigning them as necessary. Repair of irrigation equipment should be done using the original specified materials. The irrigation controller should be adjusted a minimum of once per month to change the watering time for each valve using the water schedule provided as a guideline. The guideline should be adjusted accordingly as the weather changes.

Irrigation Audit Schedule. In compliance with AB 1881, it is recommended that irrigation audits be performed on this site by a certified landscape irrigation auditor at least once every 5 years.

Water management. Contractor/Owner shall manage water in conjuction with the Irrigation Schedule submitted as part of the Landscape Documentation package and approved by the City of Orange. It shall be the Contractor/Owner's responsibility to evaluate the results of this schedule and adjust the watering schedule as needed to assure plant survival while using the least amount of water possible. The need for water shall dictate the frequency of watering by the automatic sprinkler system. exact amount of moisture replacement shall be governed by current weather condiditions, soil type, plant material type, and other environmental and cultural factors as dictated by the project site. Contractor/Owner shall be expected to use minimal amount of water in all areas to sustain healthy plant growth. Plant material shall be watered at such frequency as weather conditions require to replenish soil moisture below root zone. Water run-off across pavements and into gutters shall be avoided. It shall be the Contractor's responsibility to monitor water use as necessary for healthy growth of plant material, conservation of water, and public safety. Where moisture sensing devices are used, continual monitoring will be made to assure units are functioning properly. Hours of scheduled operation will be programmed to prevent possible nuisance from sprinkler operation to pedestrians and vehicles. Any repairs necessary to keep the system operating in its intended designed state shall be made by the Contractor in accordance with the original plans, specifications, and details.

Date:_____ Prepared by:_____

6,385

73,456

Hydrozone Summary Report

Date: May 26, 2021

Prepared by: LeisureLand

Project Site: Dental Office Project Address: 1936 E. Katella Avenue. Orange, CA 92867 Historical Annual Eto (inches): 50.1 Landscape Area: 6,385 s.f.

Landscape Architect: Roy Leisure, CA 3154

Valve Sta. No.	Zone Name	Plant Type	Crop Coef.	Irrig. Eff.	Area	Est. Water Usage
				%	sq. ft.	gallons
A1	Landscape	Trees, shrubs, ground cover	0.3	0.81	1842	21,191
A2	Landscape	Trees, shrubs, ground cover	0.3	0.81	2317	26,656
A3	Landscape	Trees, shrubs, ground cover	0.3	0.81	2226	25,609
	•	_				
A3	Landscape	Trees, shrubs, ground cover	0.3	0.81	222	26

Totals:

25% of historical rainfall: **Total Estimated Water Use (EWU):** 73,456 Max. Applied Water Allowance (MAWA): 89,249 Dental Office


fabrication or construction.

1936 E. Katella Ave Orange, CA 92867

Contractors shall verify all field drawings before starting construction. All measurements are subject to verification by the contractor and he shall notify Environmental Design Sysytems, Inc. of any discrepancies prior t

Job Title - Address Owner - Address

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LeisureLand

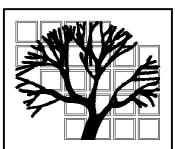Landscape Architecture Construction

Management

2131 Minoru Drive Altadena, CA 91001

Phone (818) 437-5254 rleisureland@gmail.com

Consultants These drawings are to be considered preliminary and are not approved for construction until the owner and the Landscape Architect have signed below. These drawings are not to be used for construction by the contractor until the contractor has signed below. Signatures below by Owner and Contractor indicate a complete review and knowledge of the scope, contents, and conditions as set forth in these documents.

Owner

March 30, 2021

May 26, 2021

July 13, 2021

Landscape Architect

Contractor

Revisions


September 12, 2019

February 28, 2020

February 6, 2020

April 21, 2020

December 4, 2020

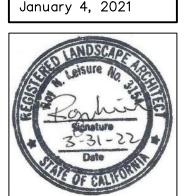

. Katella Job Number

No Scale

November 12, 2018

Irrigation Hydrozone Summary Sheet Title Sheet Number



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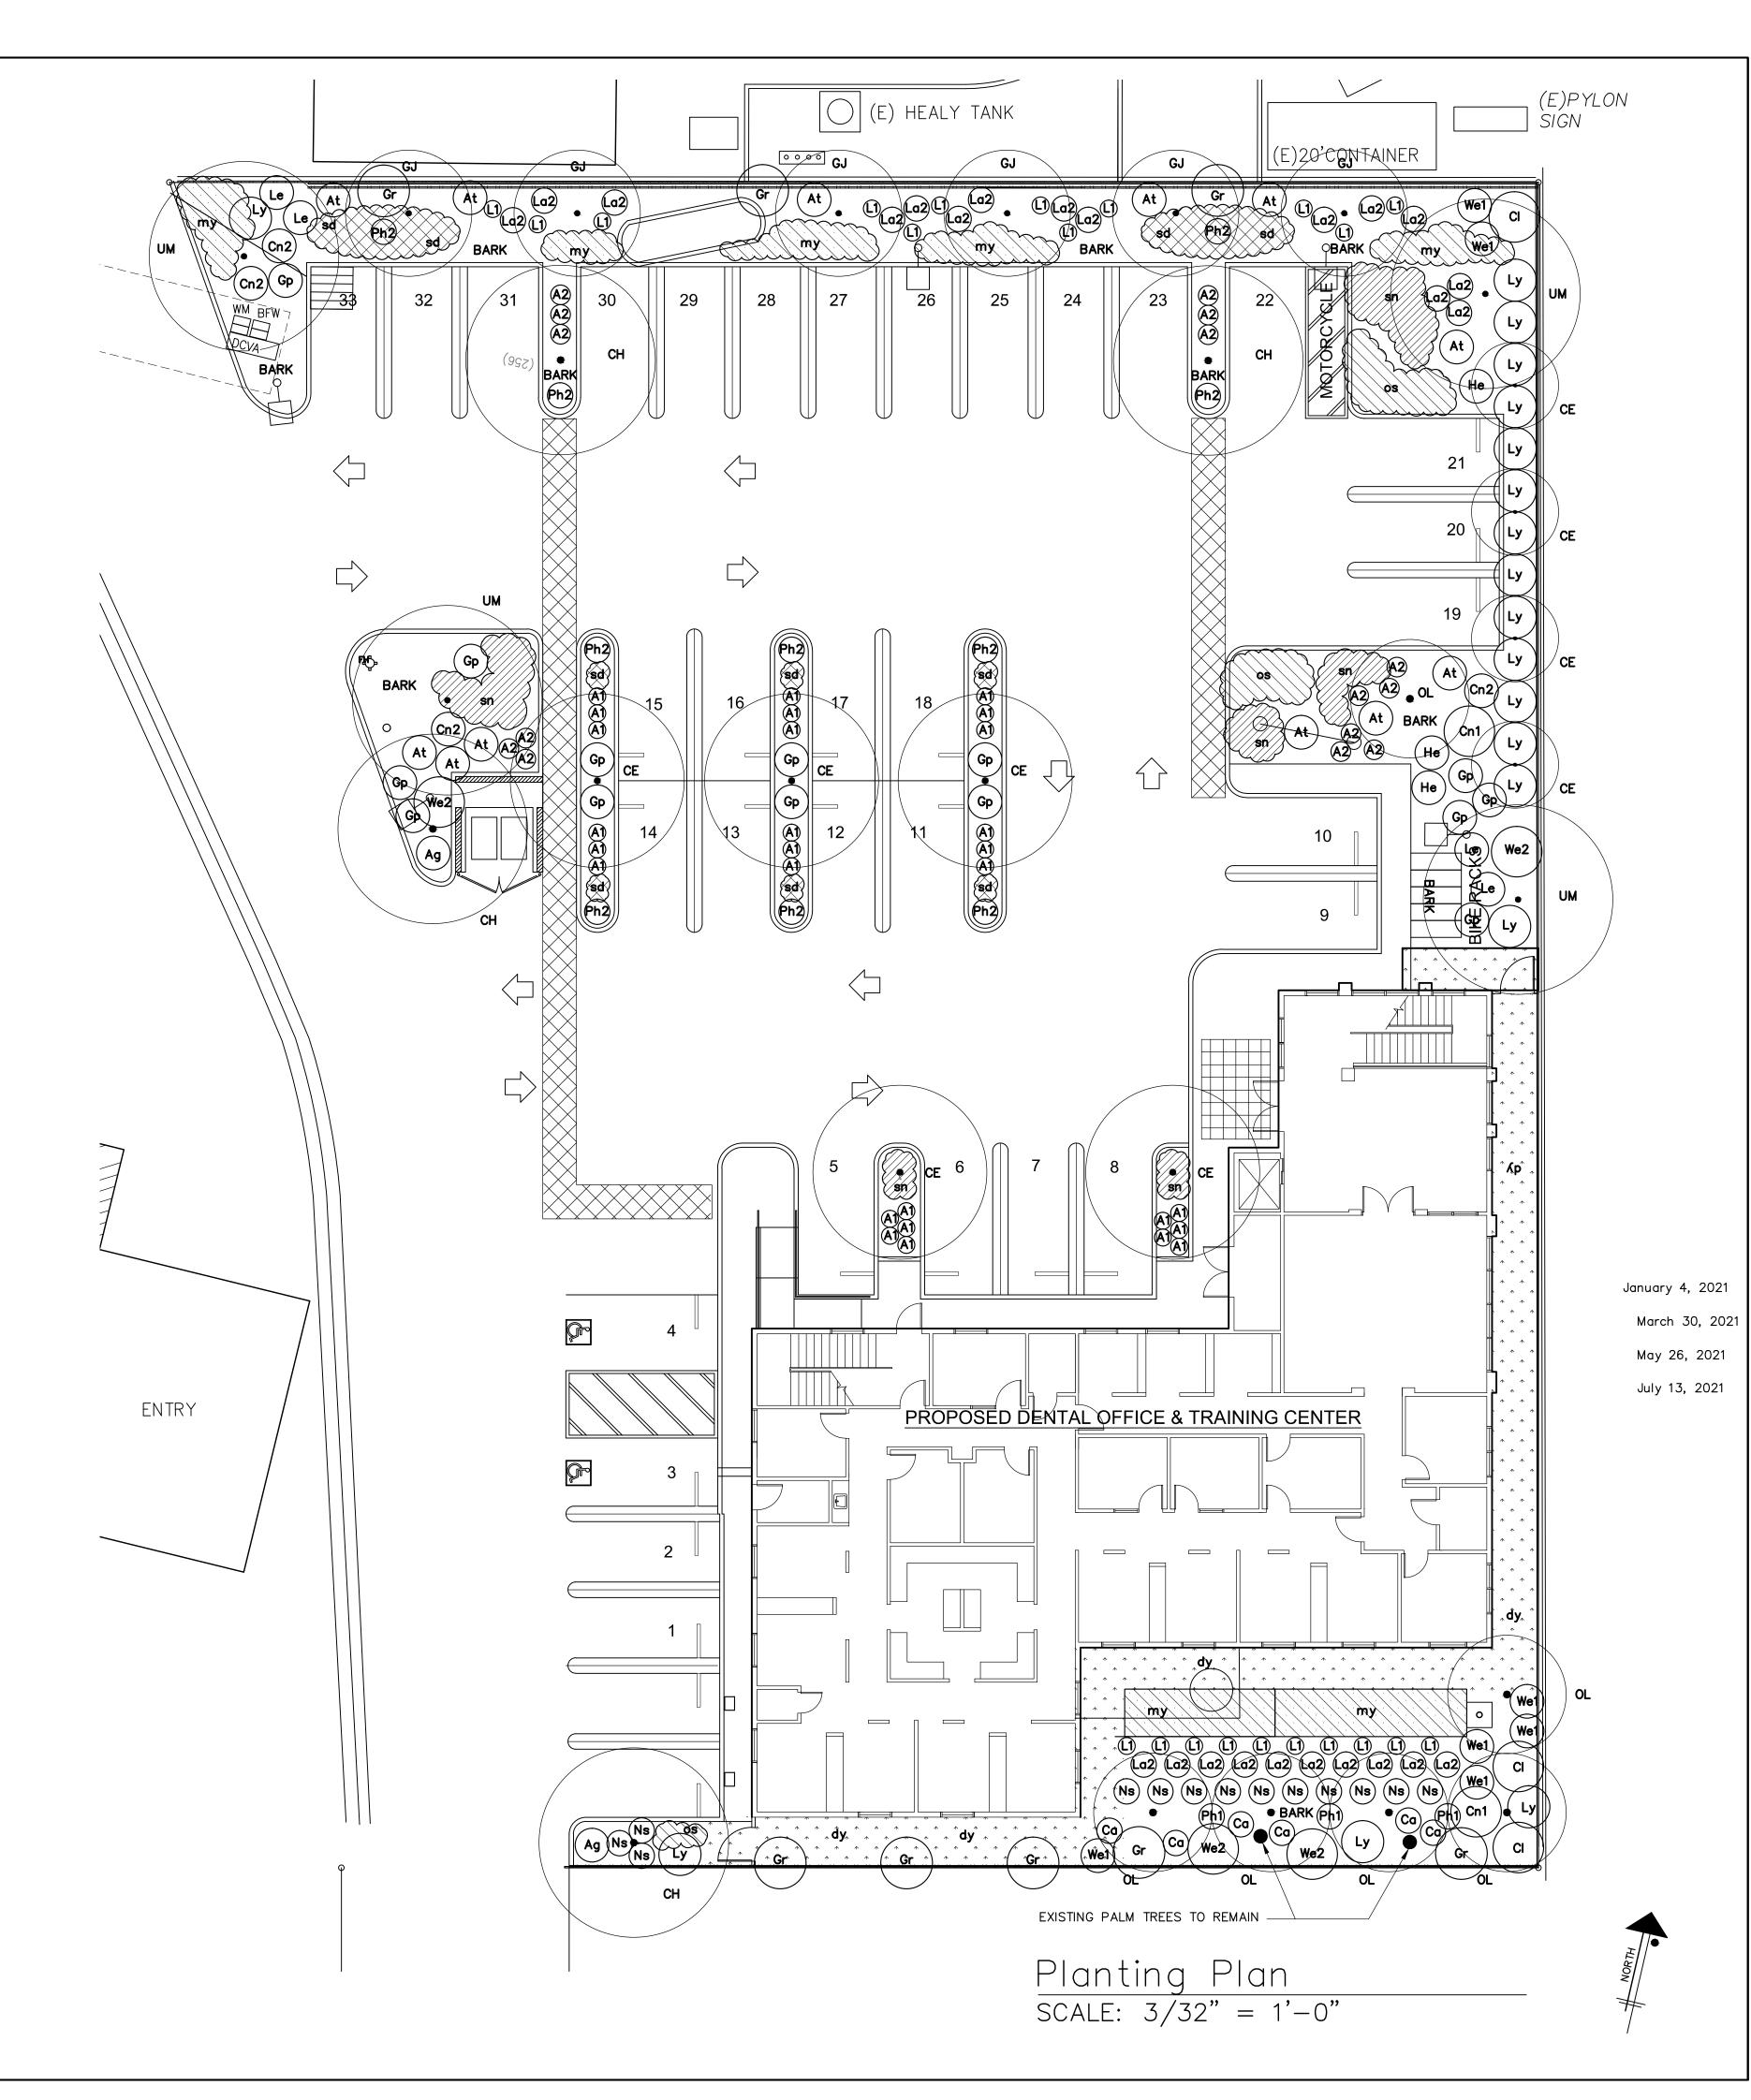
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	P L A N T	LEGEN	D		
SYMBOL	BOTANICAL NAME	COMMON NAME	SIZE	QUANTITY	NOTES
	TREES				TOTAL TREES = 28
CE	CERCIS CANADENSIS 'OKLAHOMA'	OKLAHOMA REDBUD	24" BOX	9	REFER TO DETAIL FOR TYPICAL TREE INSTALLATION
СН	CHITALPA TASHKENTENSIS 'PINK DAWN'	PINK DAWN CHITALPA	24" BOX	4	REFER TO DETAIL FOR TYPICAL TREE INSTALLATION
GJ	GEIJERA PARVIFLORA	AUSTRALIAN WILLOW	24" BOX	6	REFER TO DETAIL FOR TYPICAL TREE INSTALLATION
OL	OLEA EUROPAEA MONHER	MAJESTIC BEAUTY FRUITLESS OLIVE TREE	24" BOX	6	REFER TO DETAIL FOR TYPICAL TREE INSTALLATION
UM	UMBELLULARIA CALIFORNICA	CALIFORNIA BAY TREE	24" BOX	4	REFER TO DETAIL FOR TYPICAL TREE INSTALLATION
	SHRUBS				
Ag	AGAVE OVATIFOLIA	WHALES TONGUE AGAVE	5 GAL	2	REFER TO DETAIL FOR TYPICAL SHRUB INSTALLATION
A1	ANIGOZANTHOS 'BUSH RANGER'	DWARF KANGAROO PAW	1 GAL	10	REFER TO DETAIL FOR TYPICAL SHRUB INSTALLATION
A2	ANIGOZANTHOS 'ORANGE CROSS'	ORANGE KANGAROO PAW	5 GAL	13	REFER TO DETAIL FOR TYPICAL SHRUB INSTALLATION
At	ARTEMESIA 'POWIS CASTLE'	POWIS CASTLE WORMWOOD	5 GAL	12	REFER TO DETAIL FOR TYPICAL SHRUB INSTALLATION
Ca	CALAMAGROSTIS x ACUTIFLORA 'KARL FOERSTER'	FEATHER REED GRASS	5 GAL	6	REFER TO DETAIL FOR TYPICAL SHRUB INSTALLATION
CI	CALOTHAMNUS QUADRIFIDUS 'SEASIDE'	SEASIDE ONE-SIDED BOTTLEBRUSH	5 GAL	3	REFER TO DETAIL FOR TYPICAL SHRUB INSTALLATION
Cn1	CHONDROPETALUM ELEPHANTINUM	LARGE CAPE RUSH	5 GAL	2	REFER TO DETAIL FOR TYPICAL SHRUB INSTALLATION
Cn2	CHONDROPETALUM TECTORUM	SMALL CAPE RUSH	5 GAL	2	REFER TO DETAIL FOR TYPICAL SHRUB INSTALLATION
Gp	GREVILLEA LANIGERA 'PROSTRATE'	PROSTRATE WOOLLY GREVILLEA	1 GAL	14	REFER TO DETAIL FOR TYPICAL SHRUB INSTALLATION
Gr	GREVILLEA 'LONG JOHN'	LONG JOHN GREVILLEA	5 GAL	8	REFER TO DETAIL FOR TYPICAL SHRUB INSTALLATION
Не	HESPERALOE PARVIFLORA	RED YUCCA	5 GAL	3	REFER TO DETAIL FOR TYPICAL SHRUB INSTALLATION
L1	LAVANDULA STOECHAS	SPANISH LAVENDER	1 GAL	22	REFER TO DETAIL FOR TYPICAL SHRUB INSTALLATION
La2	LAVANDULA x INTERMEDIA 'PROVENCE'	BLUE LAVANDER	1 GAL	25	REFER TO DETAIL FOR TYPICAL SHRUB INSTALLATION
Le	LEONOTIS LEONURUS	LION'S TAIL	5 GAL	4	REFER TO DETAIL FOR TYPICAL SHRUB INSTALLATION
Ly	LEUCOPHYLLUM LANGMANIAE 'BRAVE RIVER'	BRAVE RIVER TEXAS RANGER	5 GAL	19	REFER TO DETAIL FOR TYPICAL SHRUB INSTALLATION
Ns	NASSELLA TENUISSIMA	MEXICAN FEATHER GRASS	1 GAL	13	REFER TO DETAIL FOR TYPICAL SHRUB INSTALLATION
Ph1	PHORMIUM 'FITO1' PLANT PATENT	BLACK ADDER FLAX	5 GAL	3	REFER TO DETAIL FOR TYPICAL SHRUB INSTALLATION
Ph2	PHORMIUM 'RAINBOW MAIDEN'	RAINBOW MAIDEN NEW ZEALAND FLAX	5 GAL	11	REFER TO DETAIL FOR TYPICAL SHRUB INSTALLATION
We1	WESTRINGIA FRUTICOSA MUNDI	LOW COAST ROSEMARY	1 GAL	7	REFER TO DETAIL FOR TYPICAL SHRUB INSTALLATION
We2	WESTRINGIA 'WYNYABBIE GEM'	COAST ROSEMARY	5 GAL	4	REFER TO DETAIL FOR TYPICAL SHRUB INSTALLATION
	GROUND COVER				
dy	DYMONDIA MARGARETAE	SILVER CARPET	FLATS		TRIANGULAR SPACING @ 12" ON CENTER
my	MYOPORUM PARVIFOLIUM 'FINE LEAF FORM'	FINE-LEAF GROUND COVER MYOPORUM	FLATS		TRIANGULAR SPACING @ 24" ON CENTER
os	OSCULARIA DELTOIDES	PINK ICEPLANT	FLATS		TRIANGULAR SPACING @ 18" ON CENTER
sd	SEDUM RUPESTRE 'ANGELINA'	GOLDEN SEDUM	FLATS		TRIANGULAR SPACING @ 12" ON CENTER
sn	SENECIO MANDRALISCAE	KLEINIA	FLATS		TRIANGULAR SPACING @ 12" ON CENTER
	2" - 3" BARK/MULCH	APPLY TO AREAS NOT COVERED BY PLANTED GF	OUND COVER	BULK	100% COVERAGE




Contractors shall verify all field conditions for conformance to drawings before starting construction. All measurements are subject to verification by the contractor and he shall notify Environmental Design Sysytems, Inc. of any discrepancies prior to fabrication or construction.

Dental Office

1936 E. Katella Ave. Orange, CA 92867

Job Title - Address Owner - Address

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LeisureLand

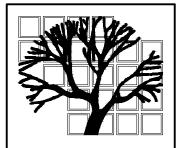Landscape Architecture

Construction Management

2131 Minoru Drive Altadena, CA 91001

Phone (818) 437-5254 rleisureland@gmail.com

Consultants These drawings are to be con— sidered preliminary and are not approved for construction until the owner and the Landscape the owner and the Landscape Architect have signed below. These drawings are not to be used for construction by the contractor until the contractor has signed below. Signatures below by Owner and Contractor indicate a complete review and knowledge of the scope, contents, and conditions as set forth in these documents.

Owner

Landscape Architect

Contractor

Revisions

September 12, 2019 October 25, 2019

February 6, 2020

February 28, 2020

April 21, 2020

December 4, 2020





Job Number

3/32" = 1'-0"

November 12, 2018

Planting

Sheet Title

Sheet Number

Details

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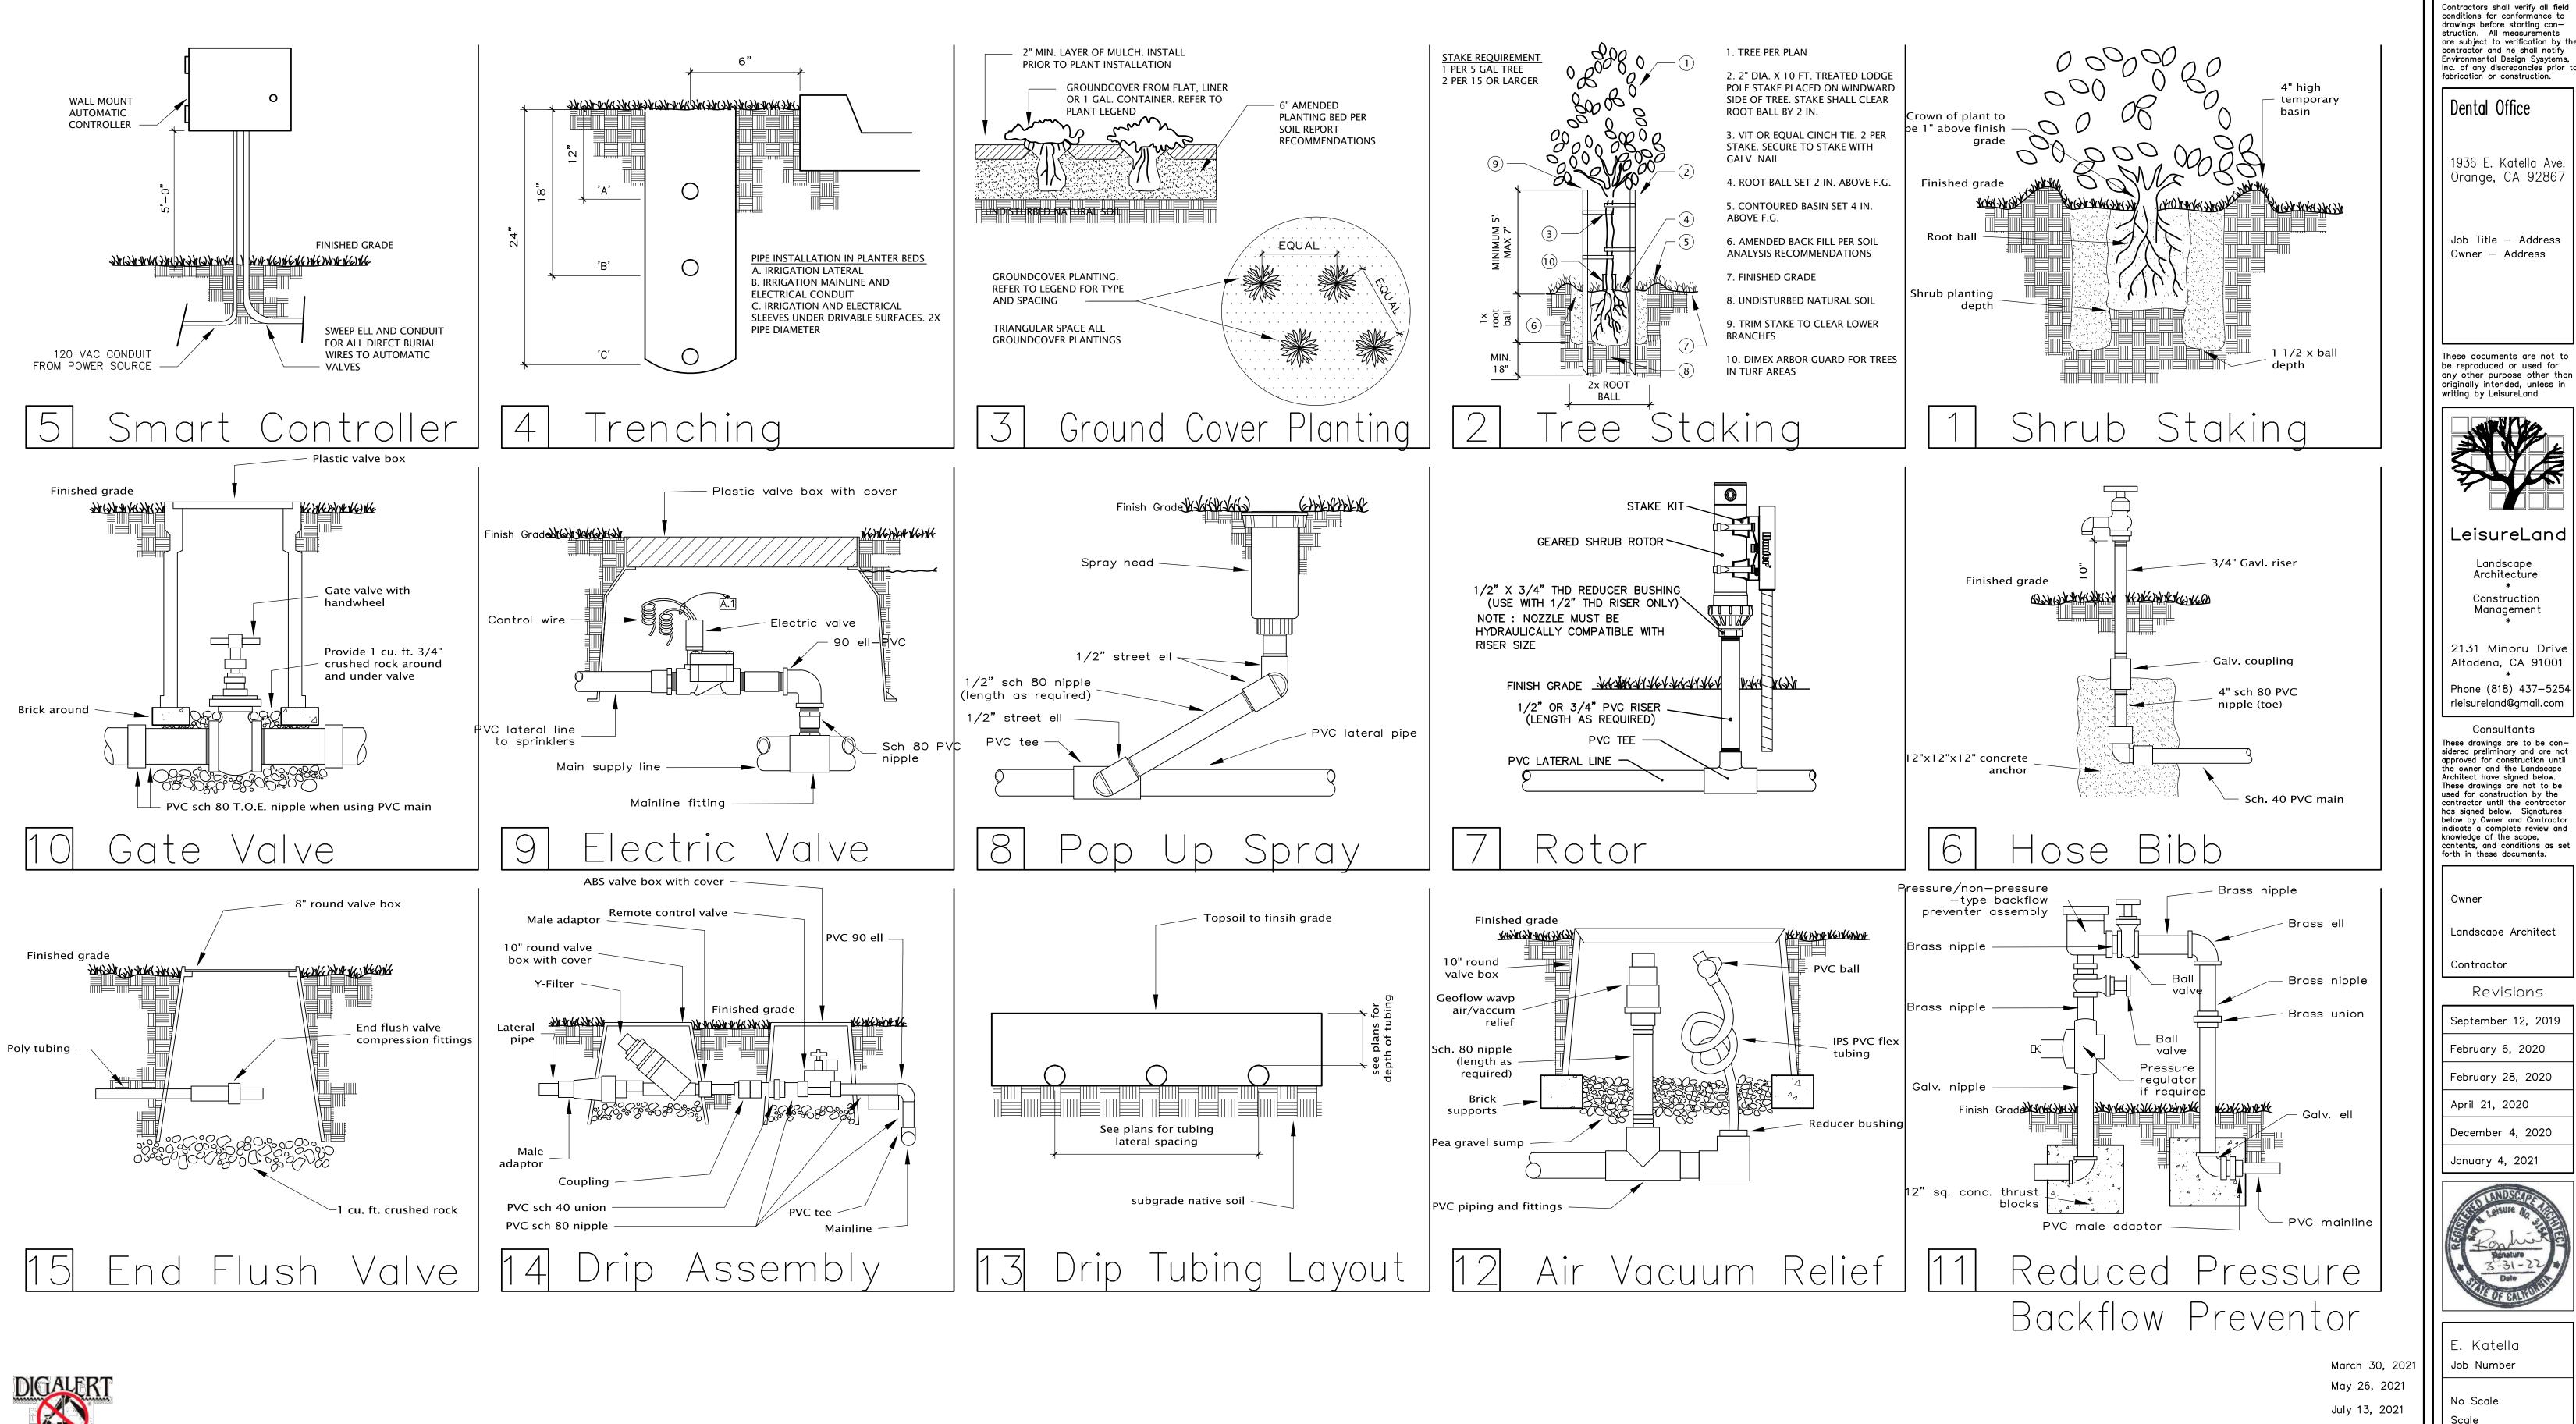
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Details

E. Katella

Job Number

November 12, 2018

Irrigation

Planting Details Sheet Title Sheet Number

Irrigation Notes

General

All irrigation works shall be in accordance with these plans, details, and notes, and all local

Plan is diagrammatic (includes all piping, sleeving, valves, backflow units, quick couplers, and controllers).

Contractor shall verify existing site conditions. If there are any conflicts with plans, the contractor shall notify the Landscape Architect prior to any irrigation installation. Head layout is designed for head to head coverage. Adjust to fit field conditioned for 100% coverage. Adjust nozzle and R.C.V. to eliminate overthrow and mist.

Contractor shall keep the premises clean and free of excess equipment, materials, and rubbish incidental to his work.

Contractor shall verify P.O.C. and existing static pressure. Contractor shall adjust all spray heads to avoid overspray onto sidewalk, street, buildings,

Contractor shall verify 120v service location for controller.

Contractor shall apply, obtain, and pay for all permits necessary to carry out the Scope of

Scope of Work

The contractor shall furnish all material, labor, transportation, equipment, and property and shall perform all operations required for a complete and operable irrigation system as indicated on or reasonable implied in the drawings and/or notes.

Included as a part of the irrigation work, but not limited by it, are the following items: the furnishing, installing and testing of all mainlines, points of connection, lateral lines, risers and fittings, spray heads, backflow preventers, control wires (to valves), electric remote control valves, ball valves, quick couplers, and the excavation, backfill and all other work in accordance with these plans, notes, and details. Materials

Pipe — All types of pipe materials and fittings shall be as designated on the plans or these specifications.

Plastic Pipe with Solvent Weld Socket or Threaded Fittings — All plastic pipe shall be rigid unplasticized polyvinyl chloride PVC 1220 type 1, grade 2), conforming to ASTM D 1785. The minimum pressure rating shall not be less than the working pressures indicated therein for the schedule and sizes listed. Fittings and couplings for plastic pipe shall be threaded or slip—fitting tapered socket solvent weld type. Threaded adapters shall be provided with socket pipe for connections to threaded pipe. Plastic pipe fittings and couplings shall be

minimum Schedule 40 PVC or as specified on the drawings. Valves — All valves shall be of the size, type, and capacity designated on the drawings. Remote Control Valves — Remote control valves shall be electrically operated. They shall be PVC or brass/bronze with accurately machined valve seat surfaces, equipped with flow control adjustment, and capable of manual operation. They shall be readily disassembled for servicing.

Ball Valves — All ball valves in sizes 2" and smaller shall be of PVC construction. Ball valves 2 1/2" and larger shall be brass/bronze with integral taper seats and non-rising

Quick Coupling Valves and Assemblies — Quick coupling valves shall be brass or bronze with built—in flow control and self—closing valve. When an assembly is specified, it shall consist of the valve, quick coupler key, and swivel ell.

Valve Boxes — All valve boxes and covers shall be ABS plastic.

Backflow Preventer Assembly — The backflow preventer shall consist of a backflow preventer unit and related components conforming to the governing code requirements. Sprinkler Equipment — Sprinkler heads, bubbler heads and spray nozzles shall be of the types and sizes shown on the plans. Equipment of one type and flow characteristic shall

be from the same manufacturer and all equipment shall bear the manufacturer's name and identification code in a position where they can be identified in the installed position. Controller — The type of control unit shall be installed as specified on the drawings. It shall be fully automatic, with provisions for manual operation, sized to accommodate the number of stations or control valves included in the system. Outdoor models shall be housed in a vandal—proof and weatherproof enclosure with locking cover. All related electrical materials and conduits necessary for 120v connection to the controller all be approved and identified by the Underwriters Laboratories, Inc. (UL). Contractor shall furnish and install all electrical equipment and materials required for a complete electrical system and shall be per local codes and provisions of the latest edition of the National Electrical Code (N.E.C.)

Installation

Install all materials as per plans, notes, and details on these sheets. Prior to starting work, Contractor shall coordinate sleeving, mainline, and lateral line layout with the General Contractor prior to hardscape installation.

All sleeving shall be SCH 40 PVC pipe 1 1/2 times the diameter of the pipe or as noted per plan. Install sleeving at min. 24" depth where irrigation mainline or laterals cross under pavement. Install control wire in mainline trench. Secure with 10ml tape to the underside of mainline at 10' o.c.

Mainline shall be tested at 125 psi for a period of 4 hours min. Lateral lines under pavement shall be pressure tested at existing static pressure. Lateral lines shall be set at min. 12" depth, mainline shall be set at a min. 18"depth.

All mainline and lateral lines shall be flushed prior to irrigation head installation. All brass or galvanized connections shall be coated with Teflon tape or red-lube joint compound or approved eq. All PVC threaded connections shall be coated with Teflon tape. All PVC solvent weld connections shall be made with solvent weld materials as recommended by the pipe manufacturer. Solvent weld primer shall be applied to all connections.

Place all valves, including quick couplers, ball valves, and backflow units, in shrub areas unless noted per plan. Install R.C.V. in 10" x 17" rectangular ABS valve box. Install quick couplers, ball valves, end flush valves and Y-filters in 10" round valve boxes. Identify valve to corresponding controller station number with manufactured plastic number tags, Christie or approved eq. and mark valve covers with 6" spray painted numbers. Protect all spray heads from low head drainage with in—line check valves or approved eq.

the controller. Index all valves on the provided panel of the controller. Turn over all backflow preventer handles, two (2) quick coupler keys and swivel ells and controller keys to the Owner at the end of the maintenance period.

Place a photostatically reduced and hermetically sealed copy of the 'as built plans' with

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Number of days in advance of a digging project that you need to notify the one call center of your intent to

dig.

Maintenance and Guarantee

Upon completion of the project, the Contractor shall provide to the Owner the following: A. A reproducible set of 'as—built' drawings and controller chart.

B. Two (2) quick coupler keys and matching swivel ells.

As—built Drawings — The Contractor shall provide and keep up to date, a complete 'as—built' record set of prints which shall be corrected daily and show every change from the original drawings. Prior to final inspection, the Contractor shall transcribe all information from the 'as—built' set to a reproducible mylar, procured from the Landscape Architect. All work shall be neat and legible, locating the following items from permanent points of reference: ball valves, mainline and control wire routing, P.O.C., backflow device, control valves, controller, quick coupling valves, and other pertinent underground items.

Controller Chart — Upon approval of the final 'as—built' drawings, Contractor shall provide one chart fro each controller installed.

A. The chart is to be reduced and hermetically sealed copy of the approved 'as-built' drawing (a black line print reduced to fit the inside dimensions of the controller door, each valve station shall be color coded)

Contractor shall maintain the irrigation system for a period of 90 days and guarantee the system for a one (1) year period.

Maintenance Procedures — The general care and maintenance of the irrigation systems shall consist of the following: A. Contractor shall maintain the irrigation system in a like new, operating condition, adjusting

head heights, throw and spay arcs as necessary. B. Contractor shall be responsible for proper watering of all planting areas, and shall replace any plant material damaged due to improper moisture distribution.

C. During the course of the maintenance period, the Contractor shall remove surplus materials and debris from the site and shall keep the premises in a neat and clean condition at all times. D. During the maintenance period, the Contractor shall be responsible for maintaining adequate protection for all irrigation systems. Any damage to areas shall be immediately repaired at the Contractor's expense.

Planting Notes

General

test report.

All work shall be in accordance with these plans, notes, details, and all applicable local codes. Plan is diagrammatic. Contractor shall verify site conditions. Any conflicts between the plans and site conditions shall be identified by the Contractor who shall notify the Landscape Architect prior to any planting installation.

The irrigation system shall be installed complete and operable prior to any planting installation, except as noted in these specifications.

Contractor shall verify quantities by plan check. The Contractor shall be responsible for all quantities shown on the plan. Shrub and ground cover quantities specified may not reflect quantities drawn.

Plant substitutions will be allowed only with written approval from the Landscape Architect. Contractor shall be responsible for delivery coordination of all materials requited by these plans, notes, and details.

Scope of work

planting. Plants shall not be allowed to dry out.

The Contractor shall furnish all material, labor, transportation, equipment, and property in order to complete the landscaping of all planting areas indicated, or reasonable implied, on the drawings and/or notes.

Included as a part of the planting installation, but not limited to, are the following items: Clear and grub all proposed landscape areas; import soil, fine grading of all planting areas; preparation of all planting holes; furnishing and installation of all required planting backfill and soil amendment materials, mulch, and miscellaneous materials; furnishing and installing all plant materials; providing maintenance throughout the specified period; clean—up and weeding of all landscape areas; guarantee of all plant materials and workmanship for a period of 90 days. Materials

All plant materials shall be of select "A-1"quality and have a growth habit normal to the species and shall be sound, healthy, vigorous and free from insect pests, plant diseases, sun scalds, fresh bark abrasions, excessive abrasions, or other objectionable disfigurements. All plants shall have normal well—developed branch systems, and vigorous and fibrous root systems which are neither root nor pot-bound and are free of kinked or girdling roots. All plants shall be true to species and variety. All materials shall be provided be a certified nursery and shall be free of any pest or disease. The Owner's representative reserve the right to reject any unsuitable or objectable

plant material. Trees and Shrubs — All plant materials shall be of the specified type and size, selected from high quality well—shaped nursery stock.

Flatted Plants — All ground cover plants and other flatted plants shall be grown and remain in the flats until transplanted at the site. The soil and spacing of the plants in the flat shall insure the minimum disturbance of the root system at time of transplanting. The Contractor shall keep all plant material delivered to the site in a healthy condition for

Topsoil — Top soil shall be Class 'A' with the same relative composition and structure representative of the soils in the vicinity; a friable sandy loam character, and be free of roots, clods, and stones larger than 1 inch in greatest dimension, pockets of coarse sand, noxious weeds, sticks, slag, brush and other litter. It shall not be infested with nematodes or other undesirable insects and plant disease organisms. Topsoil pH range shall be 5.3 to 6.0. Import soil shall be a chemically suitable sandy textured import soil with a silt plus clay content not to exceed 20% by weight with a minimum 95% passing the 2.0 millimeter sieve. The sodium absorption ratio (SAR) shall not exceed 6 and the electrical conductibility (ECE) of the saturation extract of the soil shall not exceed 3.0 mmhos/cm at 25 degrees Centigrade. The Boron content shall be no greater than 1 ppm as measured on the saturation extract. If the Boron content is found to be greater than 1 ppm after import soil has been planed, the Contractor shall be responsible for appropriately amending the Boron content at no cost to the Owner. The method of amendment shall be approved by the Landscape Architect, Soils Engineer, and City Engineer. Agronomic Soils Test — Contractor shall obtain and submit for approval, a written agronomic soils test report from a state registered testing agency for all imported and site topsoil to be used on the site. Test report shall list recommended soil amendments and preparation to insure adequate plant growth. Contractor shall adjust his bid according to the recommendations listed in the soils

Fertilizers — All fertilizing materials shall comply with applicable requirements of the State Agricultural Code. All fertilizing materials shall be packaged, first grade, commercial quality products identified as to source, type of material, weight and manufacturer's guaranteed analysis. Fertilizing material shall not contain toxic ingredients or fillers in quantities harmful to human life, animals, or plants.

Commercial Fertilizers — Commercial fertilizer shall be a pelletized or granular product having a chemical analysis as specified on the plans or in these specifications. Organic Soil Amendment — Organic soil amendment shall be a well composted organic base produced from a ground or processed wood product such as redwood, fir or cedar sawdust.

Installation

Install all materials as per plans, notes, and details. Planting areas shall be free of weeds and other extraneous materials to a depth of 12 inches below finish grade before Contractor shall be responsible for finish grade, including any import soil adjustments to earth berms and slope shapes.

Provide finish grade in planting areas at a minimum 2% gradients. Finish grades shall be 2" below adjacent walks, <u>curbs, driveways, etc. in ground cover areas.</u> Finish Grade — The finish grade shall be smooth, uniform, and free of abrupt grade changes and depressions to insure surface drainage. All planted areas shall be raked and smoothed to the required grades and contours prior to plant

Allow the Landscape Architect to adjust plant locations prior to any planting. All landscaped areas shall be planted with ground cover as shown on the plans. Ground cover shall be rooted tip cuttings from flats and shall be planted in staggered rows continuously between all trees and shrubs in the areas designated on the plans and at the spacing indicated in the plant legend.

Amend all plant areas as follows: *Soil specifications provided for bid purposed only. Contractor shall adjust amendments and bid based upon lad soil test provided by the Contractor. Test and report shall be from a certified soils laboratory and shall provide a complete regular analysis, organic matter content, and textural characteristics. Prior to construction, the Contractor shall submit a copy of the final soils report to the Landscape Architect for review and approval. Soil testing shall be administered at a rate of 1 per 4,000 s.f. of landscaped area.

A.* Soil improvement for all planter areas: 1. Rototill the following amendments 6-8" deep and irrigate thoroughly" 3 cu. yds. of well composted organic matter

150 lbs. 3-1-2, commercial fertilizer/1000s.f. 25 lbs. agricultural gypsum/1000s.f.

B.* Backfill mix for trees, shrubs, and vines shall be as follows: 80% by volume native on—site soil

installation. Finish surfaces shall be clean and suitable for planting.

20% by volume well composted organic matter 21 gram commercial fertilizer tablets added to backfill as follows:

gallon — 1 tablet 1 tablet for every 1/2" of tree trunk dia. 5 gallon - 3 tablets for larger sizes

15 gallon — 5 tablets 24" box - 7 tablets

Plant Installation — Planting holes shall be approximately square with vertical sides and twice the width of the plant container or ball, and shall be larger if necessary to permit handling and planting without injury or breakage of the root ball or root system. Any plant with a broken or cracked root ball before or during planting shall not be planted but The native soil at the bottom of the planting holes shall be scarified to a depth of 4 inches.

All planting holes shall be backfilled with a prepare soil mix as specified on the drawings and in these specifications. After planting, the plant shall be plumb with the root crown at its natural growing depth with respect to finish grade. Backfill shall be thoroughly water—settled and additional prepared soil mix added to fill any remaining void below finish grade. A circular watering basin slightly larger than the planting hole shall be left around the plant. The bottom of the basin shall be at approximately finish grade or slightly lower. Mulch shall be spread at least 1 inch thick in the basin. The area around plants shall be regarded to finish grade. The excess soil shall be disposed of by the Contractor. All trees shall be staked and guyed per details.

Mulch — All landscaped areas, other than those areas planted with ground cover from flats, shall be mulched with an organic bark mulch at a min. two inch (2") depth. Bark shall be of a relative uniform particle size with a median size greater than 2" in diameter. All plant material shall be replaced if expiration is due to a material or installation defect which occurs within the first 90 days after completion and acceptance by owner. Replace with equivalent size and species within thirty days. Plant material shall be pruned as necessary to control size but not to disrupt the natural

growth pattern or characteristic form of the plant. Plants shall be pruned or trimmed to achieve, for example, height clearance for visibility, pedestrain/vehicular passage, a continuos opaque hedge or any other forms as required per specifications. Regular landscape maintenance shall insure water efficiency and include, but not limited to, pruning, mulching, weeding, litter removal, and fertilizing nonnative plant materials.

Maintenance and Guarantee

The maintenance period shall commence upon the Owner's and the Landscape Architect's written approval of all phases of planting installation and shall be for ninety (90) continuous claendar days. For bid purposes only: maintenance work shall include a minimum two (2) fertilizer applications to all planting areas during the maintenance period. At the first sign of a deficiency, up to 30 days, the Contractor shall provide a minimum of one soils sample test from ground cover areas to determine the requirements for fertilization application

The Contractor shall provide a 90 day guarantee on all plant materials. Maintenance Procedures — the general care and maintenance of all areas shall consist of proper watering, fertilization, weeding, clean-up, and as follows:

A. Cultivate and weed at not less than ten (10) working day intervals. B. Approximately 30 days after initial planting, apply 150 lbs. 3—1—2, commercial fertilizer per 1000 s.f. apply and thoroughly irrigate. The second application using the above specified fertilizer at the same rate shall be applied in another 60 days or just before maintenance period ends. Fertilization recommendations from soils test take precedence. C. Contractor shall maintain the irrigation system in a like new, operating condition, adjusting head heights, throw and spray arcs as necessary. The Contractor shall be responsible for proper watering of all planting areas, and shall replace any plant materials damaged due to improper moisture.

D. Any concentrated development of weed growth that may appear in planting areas during the maintenance period shall be removed at thirty (30) day intervals. The Contractor may elect to remove such concentrations of weeds manually or by an approved herbicide program. The Contractor shall consult the Landscape Architect prior to using

E. During the course of the maintenance work, the Contractor shall remove surplus materials and debris from the site and shall keep the premises in a neat and clean condition at all times. F. During the maintenance period, the Contractor shall be responsible for maintaining

adequate protection for all planting areas. Any damage to areas shall be immediately repaired at the Contractor's expense.

PRIOR TO LANDSCAPE INSTALLATION TO

CORRECT AMENDMENT MIX.

<u>REFER TO SOIL AND PLANT LAB OR EQUAL FOR</u> RECOMMENDATIONS FOR ENHANCING SOIL STRUCTURE AND NUTRIENT LEVELS AND INSTALLATION INSTRUCTIONS.

LANDSCAPE REQUIREMENTS FOR LONG TERM MAINTENANCE OF COMMON AREA LANDSCAPE AND IRRIGATION SYSTEMS.

CONTRACTOR SHALL ASSUME RESPONSIBILITY FOR THE MAINTENANCE AND ADJUSTMENT OF ALL IRRIGATION SYSTEMS TO MAINTAIN DISTRIBUTION OF WATER AS OUTLINED ON SHEET L.2 OF THIS SET OF DRAWINGS IN ORDER TO COMPLY WITH THE STATED ALLOWED WATER USE. UPON THE COMPLETION OF THE LANDSCAPE OR GENERAL CONTRACTOR'S OBLIGATION THE OWNER SHALL ASSUME THESE RESPONSIBILITIES PER THE COVENANT AND AGREEMENT ON SHEET L1 & L2 OF THIS SET OF LANDSCAPE DOCUMENTS PER THE CITY OF ORANGE DROUGHT TOLERANT LANDSCAPE ORDINANCE.

<u>CONTRACTOR SHALL OBTAIN COMPLETE SOILS</u> <u>REPORT FROM SOIL SAMPLES TAKEN ON SITE</u> Owner - Address

> These documents are not to be reproduced or used for any other purpose other than originally intended, unless in

Contractors shall verify all field drawings before starting construction. All measurements are subject to verification by the contractor and he shall notify Environmental Design Sysytems,


Inc. of any discrepancies prior to fabrication or construction.

1936 E. Katella Ave

Job Title - Address

Orange, CA 92867

Dental Office

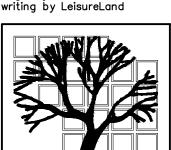

LeisureLand

Architecture Construction Management

Landscape

2131 Minoru Drive Altadena, CA 91001

Phone (818) 437-5254 rleisureland@gmail.com

Consultants These drawings are to be considered preliminary and are not approved for construction until the owner and the Landscape Architect have signed below. These drawings are not to be used for construction by the contractor until the contractor has signed below. Signatures below by Owner and Contractor indicate a complete review and knowledge of the scope, contents, and conditions as se forth in these documents.

Owner

Landscape Architect

Contractor

May 26, 2021

July 13, 2021

Revisions


September 12, 2019

February 6, 2020

April 21, 2020

December 4, 2020

February 28, 2020

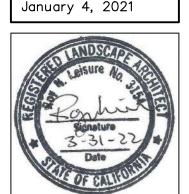

E. Katella Job Number

No Scale

November 12, 2018

Irrigation


Sheet Title

Specs

Sheet Number

REDBUD TREE
WHALE'S TOUGUE AGAVE
LARGE CAPE RUSH
LION'S TAIL

COAST ROSEMARY

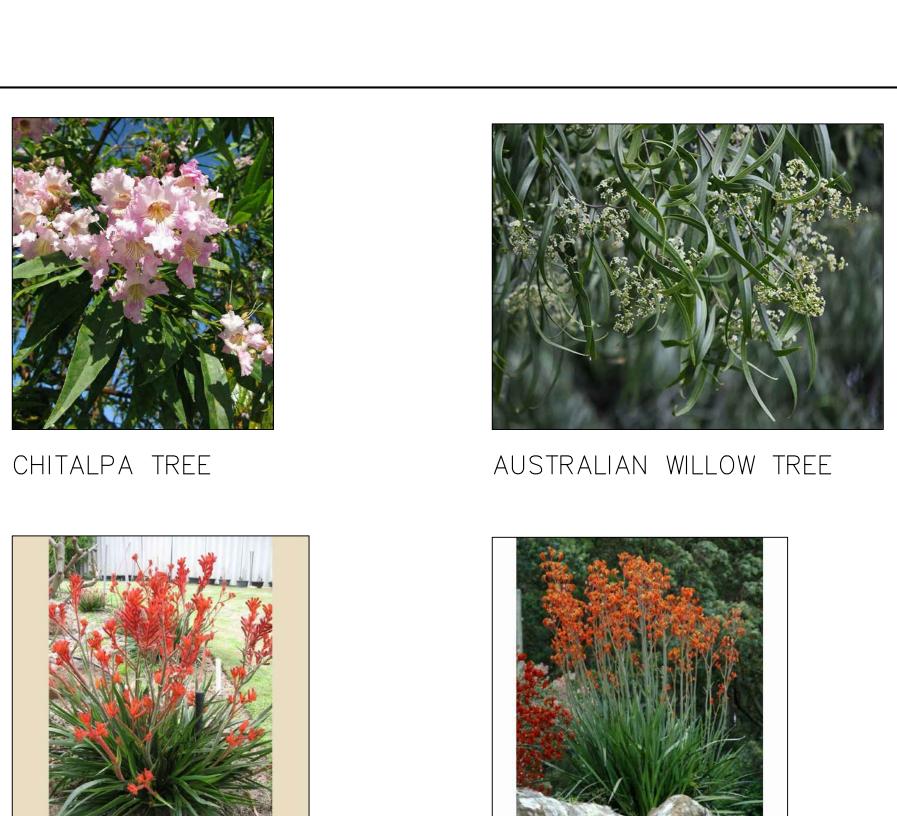

ORANGE KANGAROO PAW

GREVILLEA LONG JOHN

MEXICAN FEATHER GRASS


PROSTRATE WOOLY GREVILLEA

DWARF KANGAROO PAW

SMALL CAPE RUSH


TEXAS RANGER

SILVER CARPET GROUND COVER

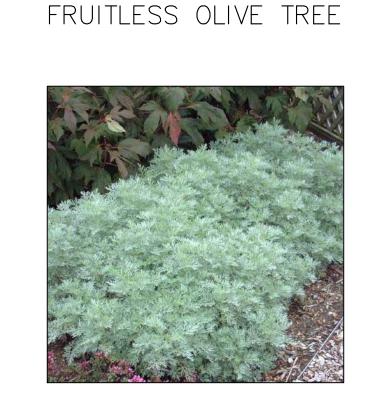






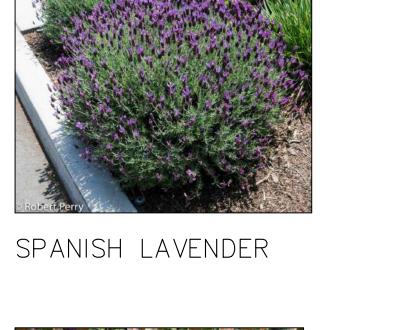



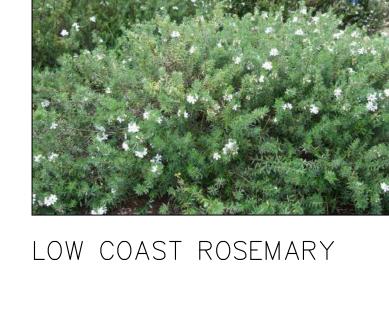



KLEINIA

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CALIFORNIA BAY TREE

	PINK DAWN CHITALPA
	AUSTRALIAN WILLOW
	MAJESTIC BEAUTY FRUITLESS OLIVE TREE
_	CALIFORNIA BAY TREE
_	
_	WHALES TONGUE AGAVE
_	DWARF KANGAROO PAW
_	ORANGE KANGAROO PAW
	POWIS CASTLE WORMWOOD
_	FEATHER REED GRASS
_	SEASIDE ONE-SIDED BOTTLEBRUSH
_	LARGE CAPE RUSH
_	SMALL CAPE RUSH
_	LONG JOHN GREVILLEA
-	

COMMON NAME

OKLAHOMA REDBUD

LEGEND


SIZE	RED YUCCA	5 GAL
	SPANISH LAVENDER	1 GAL
24" BOX	24" BOX BLUE LAVANDER	
24" BOX	LION'S TAIL	5 GAL
24" BOX	BRAVE RIVER TEXAS RANGER	5 GAL
24" BOX	MEXICAN FEATHER GRASS	1 GAL
24" BOX	BLACK ADDER FLAX	5 GAL
	RAINBOW MAIDEN NEW ZEALAND FLAX	5 GAL
5 GAL	LOW COAST ROSEMARY	1 GAL
1 GAL	COAST ROSEMARY	5 GAL
5 GAL		
5 GAL		
5 GAL	SILVER CARPET	FLATS
5 GAL	PROSTRATE WOOLLY GREVILLEA	1 GAL
5 GAL	FINE-LEAF GROUND COVER MYOPORUM	FLATS
5 GAL	GOLDEN SEDUM	FLATS
5 GAL	KLEINIA	FLATS
•	-	•





BLUE LAVENDER



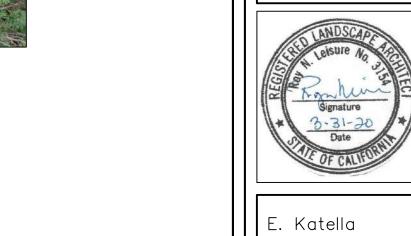

	E.	Katella
	Job	Number

October 25, 2019

Contractors shall verify all field conditions for conformance to drawings before starting construction. All measurements are subject to verification by the contractor and he shall notify Environmental Design Sysytems, Inc. of any discrepancies prior to fabrication or construction.

1936 E. Katella Ave.

Orange, CA 92867

Job Title - Address

Owner - Address

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LeisureLand

Landscape Architecture

Construction

Management

2131 Minoru Drive Altadena, CA 91001

Phone (818) 437-5254 rleisureland@gmail.com

Consultants

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Landscape Architect

Revisions

Dental Office

Plant Reference

RED YUCCA

BLACK ADDER FLAX

FINE-LEAF MYOPORUM













GOLDEN SEDUM