IN THE CITY OF ORANGE, STATE OF CALIFORNIA MAJOR SITE PLAN REVIEW NO. 1039-21 DESIGN REVIEW NO. 5028-21 CONDITIONAL USE PERMIT NO. 3137-21 534 M. STRUCK AVENUE

DEFERRED SUBMITTALS

- FIRE SPRINKLER PLAN UNDERGROUND FIRE LINE SERVICE
- FIRE SPRINKLE MONITORING/ALARM SYSTEMS
- EMERGENCY RESPONDER RADIO COMMUNICATION SYSTEM RACK STORAGE

LEGAL DESCRIPTION

THE LAND REFERRED TO IN THIS COMMITMENT IS SITUATED IN THE CITY OF ORANGE, COUNTY OF ORANGE, STATE OF CALIFORNIA, AND IS DESCRIBED AS FOLLOWS:

PARCEL I:

THAT PORTION OF THE LAND ALLOTTED TO A. SEBASTIAN VAN DE GRAAF IN DECREE OF PARTITION OF THE RANCHO SANTIAGO DE SANTA ANA, RECORDED IN CASE NO. 1192, AND ENTERED SEPTEMBER 12, 1868 IN BOOK B, PAGE 410 OF JUDGEMENTS OF THE 17TH JUDICIAL DISTRICT OF CALIFORNIA, IN THE CITY OF ORANGE, COUNTY OF ORANGE, STATE OF CALIFORNIA, DESCRIBED AS FOLLOWS:

BEGINNING AT A POINT ON THE SOUTH BOUNDARY OF SAID VAN DE GRAAF ALLOTMENT DISTANT NORTH 89°39'30" WEST 6600.00 FEET FROM THE SOUTHEAST CORNER OF SAID ALLOTMENT; THENCE NORTH 0°12'40" EAST 1320.00 FEET; THENCE NORTH 89°35'35" WEST 579.48 FEET TO THE EAST LINE OF LAND DESCRIBED IN DEED RECORDED IN BOOK 1161, PAGE 547 OF OFFICIAL RECORDS; THENCE ALONG SAID EAST LINES SOUTH 0°12'40" WEST 1320.66 FEET TO THE SOUTH BOUNDARY OF SAID ALLOTMENT; THENCE SOUTH 89°39'30" EAST 579.48 FEET ALONG SAID SOUTH BOUNDARY TO THE POINT OF

EXCEPTING THAT PORTION LYING EASTERLY OF THE EASTERLY LINE AND THE SOUTHERLY PROLONGATION THEREOF, OF THE LAND SHOWN ON A MAP FILED IN BOOK 32, PAGE 25 OF RECORDS OF SURVEY, IN THE OFFICE OF THE COUNTY RECORDER OF

ALSO EXCEPTING THAT PORTION INCLUDED WITHIN THE FOLLOWING DESCRIBED LINES:

BEGINNING AT THE INTERSECTION OF THE CENTER LINE OF COLLINS AVENUE, 60.00 FEET WIDE, WITH THE SOUTHERLY PROLONGATION OF THE EASTERLY LINE OF THE 5.075 ACRE PARCEL OF LAND SHOWN ON A MAP FILED IN BOOK 32, PAGE 25 OF RECORDS OF SURVEY, IN THE OFFICE OF THE COUNTY RECORDER OF SAID COUNTY, SAID EASTERLY LINE BEING ALSO THE WESTERLY LINE OF THE ATCHISON, TOPEKA AND SANTA FE RAILWAY COMPANY RIGHT OF-WAY AS DESCRIBED IN THE DEED TO SAID RAILWAY COMPANY, RECORDED MAY 19, 1959 AS INSTRUMENT NO. 78387, IN BOOK 4719, PAGE 405 OF OFFICIAL RECORDS; THENCE ALONG SAID CENTER LINE NORTH 89°39'30" WEST 549.21 FEET; THENCE NORTH 0°12'40 EAST 506.00 FEET PARALLEL WITH SAID WESTERLY UINE; THENCE SOUTH 89°39'30"

EAST 550.07 FEET PARALLEL WITH SAID CENTER LINE TO SAID WESTERLY LINE; THENCE SOUTH 0°18'30" WEST 506.09 FEET ALONG SAID WESTERLY LINE TO THE POINT OF

ALSO EXCEPT THEREFROM THAT PORTION DESCRIBED AS FOLLOWS:


BEGINNING AT A POINT ON THE SOUTH LINE OF SAID ALLOTMENT, NORTH 89°45'00" WEST 7179.48 FEET FROM THE SOUTHEAST CORNER OF SAID ALLOTMENT AS PER MAP RECORDED IN BOOK 4, PAGE 440 OF MISCELLANEOUS RECORDS, IN THE OFFICE OF THE COUNTY RECORDER OF LOS ANGELES COUNTY, CALIFORNIA; THENCE NORTH O'II'OO" EAST 1320.66 FEET TO A POINT ON THE CENTERLINE OF STRUCK AVENUE AS


ESTABLISHED BY THE DEED RECORDED MAY 13, 1965 AS INSTRUMENT NO. 9517, IN BOOK 7518, PAGE 808 OF OFFICIAL RECORDS, SAID POINT ALSO BEING THE NORTHWEST CORNER OF THE PROPERTY CONVEYED TO THE PLASTIC AND REALTY PROPERTIES COMPANY BY DEED RECORDED NOVEMBER 15, 1974 AS INSTRUMENT NO. 13043, IN BOOK 11288, PAGE 672 OF OFFICIAL RECORDS, AND SAID POINT IS HEREAFTER REFERRED TO AS THE TRUE POINT OF BEGINNING;

THENCE FROM SAID TRUE POINT OF BEGINNING, SOUTH 89°43'00" EAST 467.86 FEET ALONG THE NORTH LINE OF THE PLASTIC AND REALTY PROPERTIES COMPANY LAND AS ESTABLISHED IN THE ABOVE MENTIONED DOCUMENT, TO A POINT OF CUSP WITH A NON-TANGENT CURVE CONCAVE NORTHERLY, HAVING A RADIUS OF 60.00 FEET, A RADIAL LINE THROUGH SAID POINT BEARS SOUTH 89°43'00" EAST; THENCE SOUTHERLY AND SOUTHWESTERLY ALONG SAID CURVE THROUGH A CENTRAL ANGLE OF 133°20'30" AN ARC DISTANCE OF 139,64 FEET TO A POINT ON A TANGENT CURVE, CONCAVE SOUTHERLY HAVING A RADIUS OF 50.00 FEET; THENCE NORTHERLY AND NORTHWESTERLY ALONG SAID CURVE THROUGH A CENTRAL ANGLE OF 43°20'30" AN ARC DISTANCE OF 37.82 FEET; THENCE TANGENT TO SAID CURVE NORTH 89°43'00" WEST 332.31 FEET; THENCE NORTH O'II'OO" EAST 30.00 FEET TO THE TRUE POINT OF BEGINNING, AS CONVEYED TO THE CITY OF ORANGE BY DEED RECORDED FEBRUARY 24, 1975 AS INSTRUMENT NO. 14940, IN BOOK 11345, PAGE 24 OF OFFICIAL RECORDS.

DRAWING INDEX

SHEET NUMBER	SHEET TITLE
C-O	TITLE SHEET, PROJECT INFORMATION
	CIVIL
C-I	ALTA - TITLE SHEET
C-2	ALTA - BOUNDARY
C-3	ALTA - EXISTING IMPROVEMENTS
C-4	EXISTING SITE PLAN
C-5	PROPOSED SITE PLAN
C-6	CONCEPTUAL GRADING
C-7	CROSS-SECTIONS
	FIRE PREVENTION
F-I	CONCEPTUAL FIRE PLAN TITLE SHEET
F-2	CONCEPTUAL FIRE PLAN
	LANDSCAPE
L-I	CONCEPTUAL LANDSCAPE PLAN
	ARCHITECTURAL
DAB-AI.I	OVERALL SITE PLAN
DAB-A2.I	OVERALL FLOOR PLAN
DAB-A2.2	OVERALL FLOOR PLAN-MAINTENANCE BUILDING
DAB-A3.I	ELEVATIONS
DAB-A3.2	ELEVATIONS
DAB-A4.I	SECTIONS
DAB-A4.2	GATE ELEVATIONS
	PHOTOMETRIC PLAN

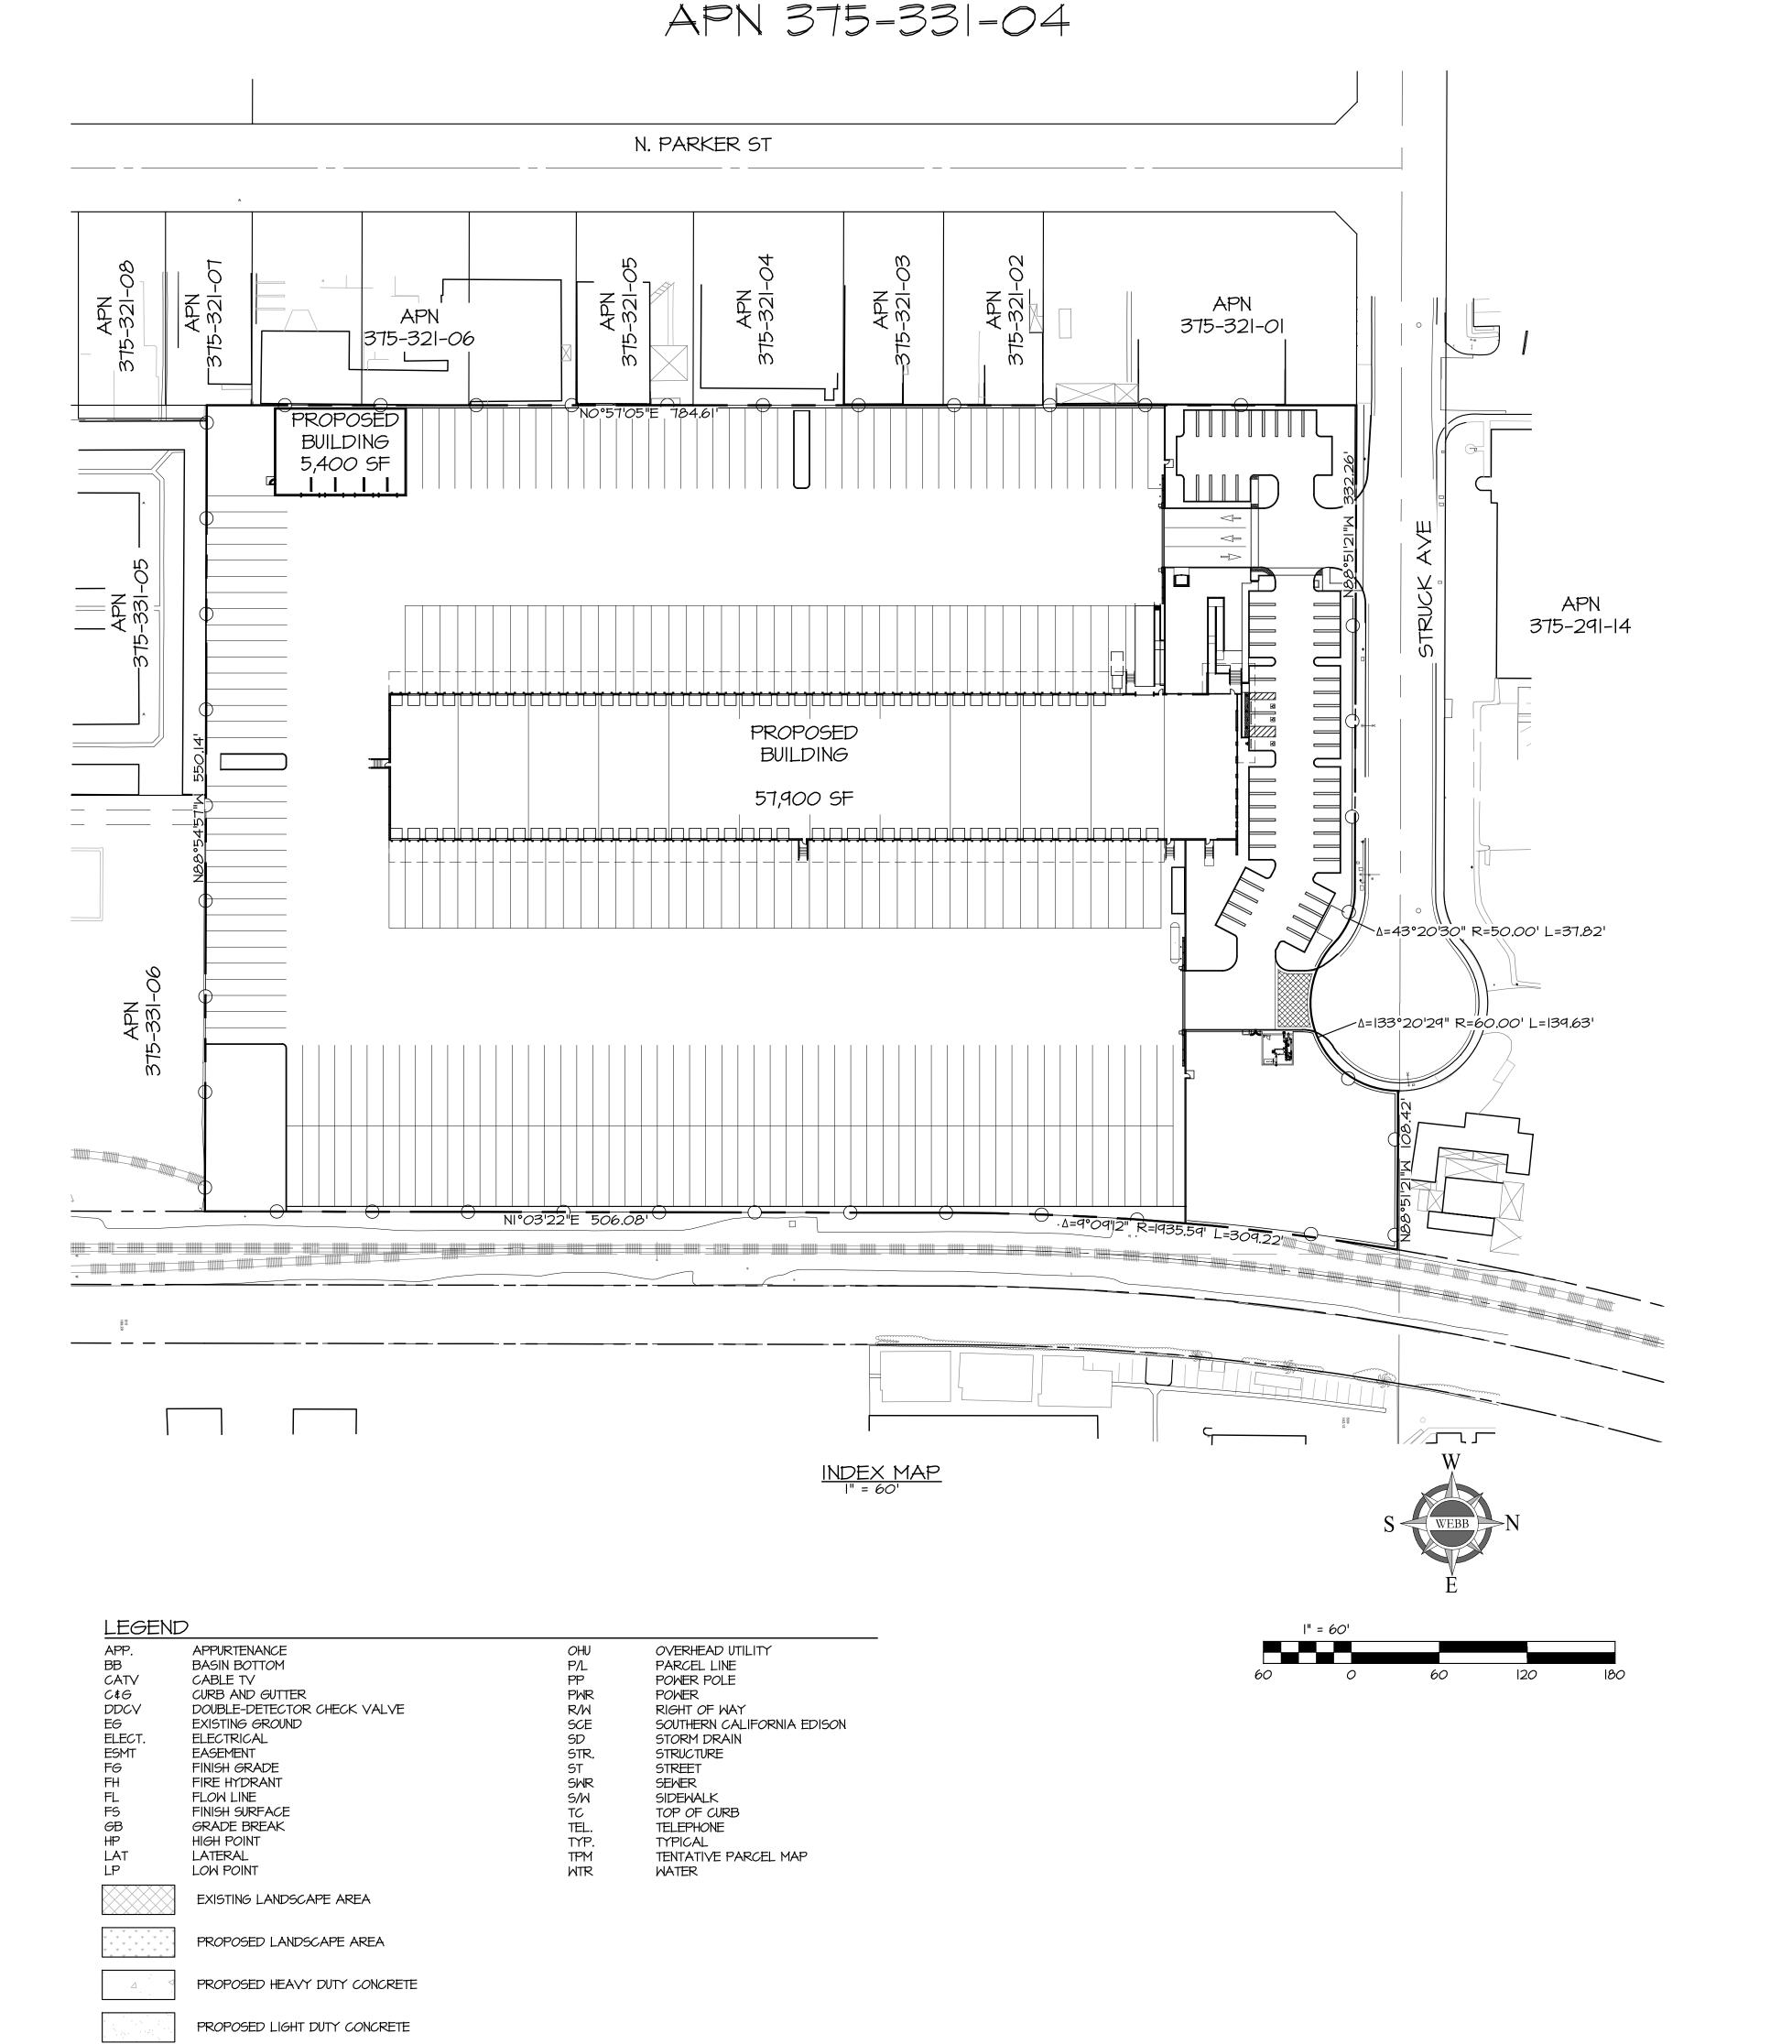

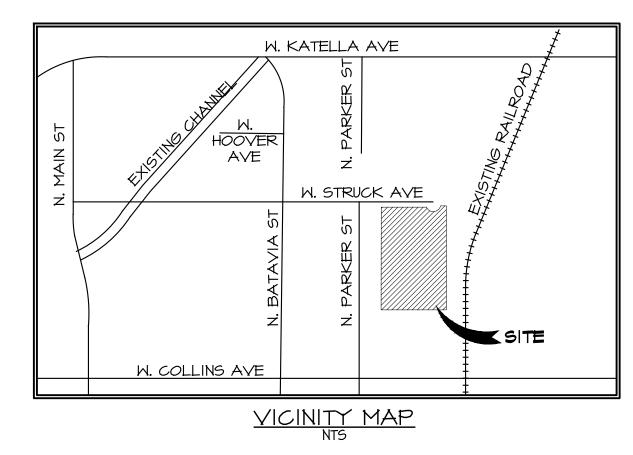

ENGINEER

3788 McCRAY STREET

RIVERSIDE, CA 92506

TEL: (951) 320-6001

FAX: (951) 788-1256

<u>ACREAGE</u>

ALBERT A. WEBB ASSOCIATES

CONTACT: BYANKA VELASCO

EMAIL: BYANKA.VELASCO@WEBBASSOCIATES.COM

ASSESSOR'S PARCEL NO.

LOT ACREAGE: 9.98 AC (434,883 SF)

APPLICANT/OWNER

EMAIL: JCARTER@PROLOGIS.COM

PROLOGIS-EXCHANGE ORANGE INDUSTRIAL CTR 6 LLC 17777 CENTER COURT DR. N, SUITE 100 **CERRITOS CA, 90703** CONTACT: JOHN CARTER

ARCHITECT HPA ARCHITECTURE 18831 BARDEEN AVENUE, SUITE 100 IRVINE, CA 92612 CONTACT: JAIME CRUZ EMAIL: JAIME@HPARCHS.COM

TEL: (949) 863-1770 SITE ADDRESS 543 W STRUCK AVENUE ORANGE, CA 92867

TEL: (562) 345-9327

SCOPE OF WORK PROPOSE THE DEMOLITION OF THE EXISTING BUILDING AND IMPROVEMENTS LOCATED AT 534 WEST STRUCK AVENUE IN THE CITY OF ORANGE TO DEVELOP A 57,900 ± SF STANDALONE BUILDING AND SURROUNDING

WATER _____ORANGE COUNTY WATER DISTRICT SEWER _____ORANGE COUNTY WATER DISTRICT __ SOUTHERN CALIFORNIA GAS COMPANY ELECTRIC _____ SOUTHERN CALIFORNIA EDISON TELEPHONE _____VERIZON/SPECTRUM TELEVISION ___INDIVIDUAL RECEPTION

LAND USE

PROPOSED LAND USE:

EXISTING LAND USE: LIGHT INDUSTRIAL EXISTING ZONING: M-2 INDUSTRIAL LIGHT INDUSTRIAL

PROPOSED ZONING: M-2 INDUSTRIAL

EXISTING BUILDING BUILDING AREA: 40,000± SF

PROPOSED BUILDING

BUILDING AREA: FLOOR AREA RATIO: (57,900 SF/432,986 SF)= 13.4%

PROPOSED MAINTENANCE BUILDING

BUILDING AREA:

EXISTING PARKING EXISTING AUTO PARKING STALLS: 50± EXISTING TRAILER PARKING STALLS: 60±

PROPOSED PARKING

OFFICE: I PER 250 S.F. = 20 STALLS WAREHOUSE: I PER 2000 S.F. = 27 STALLS TOTAL REQUIRED: 47 STALLS

PROPOSED AUTO PARKING STALLS: PROPOSED ADA PARKING STALLS:

TOTAL PROPOSED: 62 STALLS PROPOSED TRAILER PARKING STALLS: 188

BUILDING CODE INFORMATION

III-B (SPRINKLER SYSTEM EQUIPPED, NFPA 13) CONSTRUCTION TYPE: OCCUPANCY TYPE: LOW HAZARD STORAGE/BUSINESS TYPE OF CONSTRUCTION: CONCRETE/STEEL/WOOD BUILDING HEIGHT: 45 FEET

EARTHWORK QUANTITY ESTIMATE

RAW CUT: 14,329 CY RAW FILL: 11,965 CY

GENERAL NOTES

PLANS SUBMITTED FOR BUILDING REVIEW SHALL COMPLY WITH THE CALIFORNIA FIRE CODE AS AMENDED BY THE CITY AND AS FREQUENTLY AMENDED AND IN EFFECT AT THE TIME OF APPLICATION FOR BUILDING PERMIT.

								4 🖒
			SCALE: I	" = 60 [']	A L B E R T A. ENGINEERING CONSULTANTS	LANDUSE PROJECT APPLICATION	W.O. 2020-0017	/2/
				2/2/2021	3788 McCRAY STREET RIVERSIDE CA. 92506	LAND USE PROJECT APPLICATION	SHEET	20
			DESIGNED:	EP	PH. (951) 686-1070	TITI F SHFFT	$\bigcirc -\bigcirc$	70
			CHECKED:	BJV	A S S O C A T E S FAX (951) 788-1256		OF 18 SHEETS	Ξ̈́
			PLN CK REF:		DLOT DATE 2 Feb 2	534 W STRUCK AVENUE	DWG. NO.	1
REVISIONS	DATE	BY	F.B.		PLOT DATE: 2-Feb-2 I	534 W. STRUCK AVENUE		<i>l</i> '

REAL PROPERTY IN THE CITY OF ORANGE, COUNTY OF ORANGE, STATE OF CALIFORNIA, DESCRIBED AS FOLLOWS:

THAT PORTION OF THE LAND ALLOTTED TO A. SEBASTIAN VAN DECLARATION GRAAF IN DECREE OF PARTITION OF THE RANCHO SANTIAGO DE SANTA ANA, RECORDED IN CASE NO. 1192, AND ENTERED SEPTEMBER 12, 1868 IN BOOK B, PAGE 410 OF JUDGMENTS OF THE 17TH JUDICIAL DISTRICT COURT OF CALIFORNIA, IN THE CITY OF ORANGE, COUNTY OF ORANGE, STATE OF CALIFORNIA, DESCRIBED

BEGINNING AT A POINT ON THE SOUTH BOUNDARY OF SAID VAN DE GRAAF ALLOTMENT DISTANT NORTH 89°39'30" WEST 6600.00 FEET FROM THE SOUTHEAST CORNER OF SAID ALLOTMENT; THENCE NORTH 0°12'40" EAST 1320.00 FEET; THENCE NORTH 89°35'35" WEST 579.48 FEET TO THE EAST LINE OF LAND DESCRIBED IN DEED RECORDED IN BOOK 1161, PAGE 547 OF OFFICIAL RECORDS; THENCE ALONG SAID EAST LINES SOUTH 0°12'40" WEST 1320.66 FEET TO THE SOUTH BOUNDARY OF SAID ALLOTMENT; THENCE SOUTH 89°39'30" EAST 579.48 FEET ALONG SAID SOUTH BOUNDARY TO THE POINT OF BEGINNING.

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PARCEL 2:

A NON-EXCLUSIVE EASEMENT FOR SPECIFIC PURPOSES OF LAYING, OR CAUSING TO BE LAID, GAS, WATER, STORM DRAIN, AND SEWER PIPES AND MAINS AND CONDUITS AT LEAST 18 INCHES OR MORE UNDER, AND THROUGH THE WESTERLY 10 FEET OF THE FOLLOWING DESCRIBED LAND AS PERMITTED BY THE DEPARTMENT OF PUBLIC WORKS OF THE CITY OF ORANGE, TOGETHER WITH THE RIGHT OF ACCESS TO SAID GAS, WATER, STORM DRAIN, AND SEWER LINES FOR THE PURPOSES OF INSTALLATION, INSPECTION, ALTERATION, REPAIR, REPLACEMENT OR OTHER RELATED ACTIVITY, UPON THE CONDITIONS SET FORTH IN THAT CERTAIN DEED AND GRANT OF EASEMENT DATED OCTOBER 15, 1974, EXECUTED BY WILLIAM C. LAZIER AND OTHERS, RECORDED NOVEMBER 15, 1974 AS INSTRUMENT NO. 13043, IN BOOK 11288, PAGE 672 OF OFFICIAL RECORDS.

THAT PORTION OF THE LAND ALLOTTED TO A. SEBASTIAN VAN DE GRAAF. IN DECREE OF PARTITION OF THE RANCHO SANTIAGO DE SANTA ANA, RENDERED IN CASE NO. 1192 AND ENTERED SEPTEMBER 12, 1968 IN BOOK B, PAGE 410 OF JUDGMENTS OF THE 17TH JUDICIAL DISTRICT COURT OF CALIFORNIA, DESCRIBED AS FOLLOWS:

BEGINNING AT THE INTERSECTION OF THE CENTER LINE OF COLLINS AVENUE, 60.00 FEET WIDE, THE SOUTHERLY PROLONGATION OF THE EASTERLY LINE OF THE 5.075 ACRE PARCEL OF LAND SHOWN ON A MAP FILED IN BOOK 32, PAGE 25 OF RECORDS OF SURVEY. IN THE OFFICE OF THE COUNTY RECORDER OF SAID COUNTY, SAID EASTERLY LINE BEING ALSO THE WESTERLY LINE OF THE ATCHISON, TOPEKA AND SANTA FEY RAILWAY COMPANY RIGHT-OF-WAY AS DESCRIBED IN THE DEED TO SAID RAILWAY COMPANY, RECORDED MAY 19, 1959 AS INSTRUMENT NO. 78387, IN BOOK 4719, PAGE 405 OF OFFICIAL RECORDS; THENCE ALONG SAID CENTER LINE NORTH 89°39'30" WEST 549.21 FEET: THENCE NORTH 0°12'40" EAST 506.00 FEET PARALLEL WITH SAID WESTERLY LINE: THENCE SOUTH 89°39'30" EAST 550.07 FEET PARALLEL WITH SAID CENTER LINE TO SAID WESTERLY LINE; THENCE SOUTH 0°18'30" WEST 506.00 FEET ALONG SAID WESTERLY LINE TO THE POINT OF BEGINNING.

EXCEPTING THEREFROM THE SOUTHERLY 40.00 FEET AS DESCRIBED IN THE DEED TO THE CITY OF ORANGE, RECORDED JUNE 30, 1970 AS INSTRUMENT NO. 20711, IN BOOK 9361, PAGE 347 OF OFFICIAL RECORDS OF SAID COUNTY.

ALSO EXCEPTING THEREFROM THE FOLLOWING:

BEGINNING AT A POINT ON THE SOUTH LINE OF SAID ALLOTMENT, NORTH 89°45'00" WEST 7179.48 FEET FROM THE SOUTHEAST CORNER OF SAID ALLOTMENT AS PER MAP RECORDED IN BOOK 4, PAGE 440 OF MISCELLANEOUS RECORDS, IN THE OFFICE OF THE COUNTY RECORDER OF LOS ANGELES COUNTY, CALIFORNIA; THENCE NORTH 0°11'00" EAST 1320.66 FEET TO A POINT ON THE CENTERLINE OF STRUCK AVENUE AS ESTABLISHED BY THE DEED RECORDED MAY 13, 1965 AS INSTRUMENT NO. 9517, IN BOOK 7518, PAGE 808 OF OFFICIAL RECORDS, SAID POINT ALSO BEING THE NORTHWEST CORNER OF THE PROPERTY CONVEYED TO THE PLASTIC AND REALTY PROPERTIES COMPANY BY DEED RECORDED NOVEMBER 15, 1974 AS INSTRUMENT NO. 13043, IN BOOK 11288, PAGE 672 OF OFFICIAL RECORDS, AND SAID POINT IS HEREAFTER REFERRED TO AS THE TRUE POINT OF BEGINNING; THENCE FROM SAID TRUE POINT OF BEGINNING, SOUTH 89°43'00" EAST 467.86 FEET ALONG THE NORTH LINE OF THE PLASTIC AND REALTY PROPERTIES COMPANY LAND AS ESTABLISHED IN THE ABOVE MENTIONED DOCUMENT, TO A POINT OF CUSP WITH A NON-TANGENT CURVE CONCAVE NORTHERLY, HAVING A RADIUS OF 60.00 FEET, A RADIAL LINE THROUGH SAID POINT BEARS SOUTH 89°43'00" EAST; THENCE SOUTHERLY AND SOUTHWESTERLY ALONG SAID CURVE THROUGH A CENTRAL ANGLE OF 133°20'30" AN ARC DISTANCE OF 139.64 FEET TO A POINT ON A TANGENT CURVE, CONCAVE SOUTHERLY HAVING A RADIUS OF 50.00 FEET; THENCE NORTHERLY AND NORTHWESTERLY ALONG SAID CURVE THROUGH A CENTRAL ANGLE OF 43°20'30" AN ARC DISTANCE OF 37.82 FEET; THENCE TANGENT TO SAID CURVE NORTH 89°43'00" WEST 332.31 FEET; THENCE NORTH 0*11'00" EAST 30.00 FEET TO THE TRUE POINT OF BEGINNING, AS CONVEYED TO THE CITY OF ORANGE BY DEED RECORDED FEBRUARY 24, 1975 AS INSTRUMENT NO. 14940, IN BOOK 11345, PAGE 24 OF OFFICIAL RECORDS.

A NON-EXCLUSIVE EASEMENT FOR INGRESS AND EGRESS ON AND OVER THE WESTERLY 20 FEET OF PARCEL 2 OF PARCEL MAP NO. 84-757. IN THE CITY OF ORANGE, AS SHOWN ON A MAP FILED IN BOOK 194, PAGES 5 AND 6 OF PARCEL MAPS, AS SET FORTH IN THAT CERTAIN DEED AND GRANT OF EASEMENT RECORDED APRIL 05, 1985 AS INSTRUMENT NO. 85-121284 OF OFFICIAL RECORDS OF THE COUNTY OF ORANGE.

A NON-EXCLUSIVE EASEMENT FOR THE PLACEMENT AND INSTALLATION OF UTILITIES ON, IN AND OVER THE WESTERLY 10 FEET OF PARCEL 2 OF PARCEL MAP NO. 84-757, IN THE CITY OF ORANGE, AS SHOWN ON A MAP FILED IN BOOK 194, PAGES 5 AND 6 OF PARCEL MAPS, AS SET FORTH IN THAT CERTAIN DEED AND GRANT OF EASEMENT RECORDED APRIL 05, 1985 AS INSTRUMENT NO. 85-121284 OF OFFICIAL RECORDS OF THE COUNTY OF ORANGE.

APN: FOR CONVEYANCING PURPOSES ONLY: 375-331-04

THE FOLLOWING ENCUMBRANCES ITEMS ARE THOSE CONTAINED IN FIRST AMERICAN TITLE INSURANCE COMPANY PRELIMINARY REPORT NO. NCS-1014291-SF DATED MAY 12, 2020 AND HAVE THE SAME NUMERICAL DESIGNATION AS IN THE REPORT. THOSE WHICH CAN BE PLOTTED ON THE SURVEY AS SHOWN THUS . THE REMAINING ITEMS CANNOT BE PLOTTED AND REFERENCE TO THE RECORDED DOCUMENT SHOULD BE MADE FOR FURTHER PARTICULARS. [....] INDICATES SURVEYOR'S COMMENTS.

- 1. GENERAL AND SPECIAL TAXES AND ASSESSMENTS FOR THE FISCAL YEAR 2020—2021, A LIEN NOT YET DUE OR PAYABLE.
- 2. THE LIEN OF SUPPLEMENTAL TAXES, IF ANY, ASSESSED PURSUANT TO CHAPTER 3.5 COMMENCING WITH SECTION 75 OF THE CALIFORNIA REVENUE AND TAXATION CODE.
- (3.) AN EASEMENT FOR UNDERGROUND ELECTRICAL SUPPLY SYSTEMS AND COMMUNICATION SYSTEMS AND INCIDENTAL PURPOSES, RECORDED FEBRUARY 04, 1975 AS INSTRUMENT NO. 1873, IN BOOK 11335, PAGE 37 OF OFFICIAL RECORDS, IN FAVOR OF SOUTHERN CALIFORNIA EDISON COMPANY. [PLOTTED ON SHEETS 2 & 3]
- 4. AN EASEMENT FOR PIPELINES, MAINS AND CONDUITS AND INCIDENTAL PURPOSES, RECORDED NOVEMBER 15, 1974 AS INSTRUMENT NO. 13043, IN BOOK 11288, PAGE 672 OF OFFICIAL RECORDS, IN FAVOR OF PLASTIC AND REALTY PROPERTIES COMPANY. [PLOTTED ON SHEETS 2 & 3]
- (5.) AN EASEMENT FOR UNDERGROUND ELECTRICAL SUPPLY SYSTEMS AND COMMUNICATION SYSTEMS AND INCIDENTAL PURPOSES, RECORDED APRIL 02, 1985 AS INSTRUMENT NO. 1985-115999 OF OFFICIAL RECORDS, IN FAVOR OF SOUTHERN CALIFORNIA EDISON COMPANY. [PLOTTED ON SHEETS 2 & 3]
- 6. THE FACT THAT THE LAND LIES WITHIN THE BOUNDARIES OF THE ORANGE REDEVELOPMENT PROJECT AREA, AS DISCLOSED BY THE DOCUMENT RECORDED DECEMBER 03, 2001 AS INSTRUMENT NO. 20010869583 OF OFFICIAL

7. AN UNRECORDED LEASE DATED JANUARY 01, 1996, EXECUTED BY CLASSIC PROPERTIES, A CALIFORNIA PARTNERSHIP AS LESSOR AND NURSERY SUPPLIES, INC., A NEW JERSEY CORPORATION AS LESSEE, AS DISCLOSED BY A MEMORANDUM OF LEASE RECORDED AUGUST 25, 2004 AS INSTRUMENT NO. 2004000772697 OF OFFICIAL

DEFECTS, LIENS, ENCUMBRANCES OR OTHER MATTERS AFFECTING THE LEASEHOLD ESTATE, WHETHER OR NOT SHOWN BY THE PUBLIC RECORDS ARE NOT SHOWN HEREIN.

- 8. WE FIND NO OUTSTANDING VOLUNTARY LIENS OF RECORD AFFECTING SUBJECT PROPERTY. AN INQUIRY SHOULD BE MADE CONCERNING THE EXISTENCE OF ANY UNRECORDED LIEN OR OTHER INDEBTEDNESS WHICH COULD GIVE RISE TO ANY SECURITY INTEREST IN THE SUBJECT PROPERTY.
- 9. PRIOR TO CLOSING, THE COMPANY MUST CONFIRM WHETHER THE COUNTY RECORDING OFFICE IN WHICH THE LAND IS LOCATED HAS CHANGED ITS ACCESS POLICIES DUE TO THE COVID—19 OUTBREAK. IF RECORDING HAS BEEN RESTRICTED, SPECIFIC UNDERWRITING APPROVAL IS REQUIRED; AND, ADDITIONAL REQUIREMENTS OR EXCEPTIONS MAY BE MADE.
- 10. WATER RIGHTS, CLAIMS OR TITLE TO WATER, WHETHER OR NOT SHOWN BY THE PUBLIC RECORDS.
- 11. ANY FACTS, RIGHTS, INTERESTS OR CLAIMS WHICH WOULD BE DISCLOSED BY A CORRECT ALTA/NSPS SURVEY.
- 12. RIGHTS OF PARTIES IN POSSESSION.

ADDRESS: 534 W. STRUCK AVE, ORANGE, CA 92867-5522.

2. SITE LIES IN THE FOLLOWING FLOOD ZONES: ZONE "X" AREA DETERMINED TO BE OUTSIDE THE 0.2% ANNUAL CHANCE FLOOD PLAIN.

PER FEDERAL EMERGENCY MANAGEMENT AGENCY FLOOD INSURANCE RATE MAP NUMBER 06059C0161J, PANEL 161 OF 539, MAP REVISED DECEMBER 3, 2009.

- THERE IS EVIDENCE OF RECENT EARTH MOVING WORK, BUILDING CONSTRUCTION, OR BUILDING CONSTRUCTION, OR BUILDING ADDITIONS OBSERVED IN THE PROCESS OF CONDUCTING THE FIELDWORK.
- 4. NO PROPOSED CHANGES IN STREET RIGHT OF WAY LINES MADE AVAILABLE TO THE SURVEYOR BY THE CONTROLLING JURISDICTION. NO EVIDENCE OF RECENT STREET OR SIDEWALK CONSTRUCTION OR REPAIRS OBSERVED IN THE PROCESS OF CONDUCTING THE
- 5. THERE HAS NOT BEEN A FIELD DELINEATION OF WETLANDS CONDUCTED BY A QUALIFIED SPECIALIST. NO MARKERS WERE OBSERVED DURING THE PROCESS OF CONDUCTING THE

PER CITY OF ORANGE ZONING MAP PREPARED BY PUBLIC WORKS G.I.S. SECTION ON MARCH 16TH, 2016, THIS SITE IS ZONED "M-2" (INDUSTRIAL).

17.20.080 — BUILDING HEIGHT. PER CITY OF ORANGE TABLE 17.20.080 INDICATES THE MAXIMUM PERMITTED BUILDING HEIGHT.

ZONE DISTRICT	WITHIN 50 FEET OF A RESIDENTIAL DISTRICT	ALL OTHER LOCATIONS
M-2	20 FEET	45 FEET (a)

(a) Building height may exceed forty—five (45) feet provided the building is setback from the nearest property line a distance equal to the height of the building.

17.20.090 - YARD REQUIREMENTS.

TABLE 17.20.090 INDICATES THE REQUIRED MINIMUM YARD AREAS. REQUIRED YARD AREAS SHALL BE LANDSCAPED AND ADEQUATELY MAINTAINED, AND PARKING SPACES MAY NOT ENCROACH WITHIN SETBACK AREAS.

TABLE 17.20.090

DEVELOPMENT SETBACKS

	EXTERIOR FRONT, SIDE AND REAR YARDS	(a)		INTERIOR SIDE AND REAR YARDS	
ZONE	WHEN ADJACENT TO OR ACROSS FROM AN ALLEY FROM A RESIDENTIAL ZONE	WHEN ADJACENT TO AN ARTERIAL STREET	WHEN ADJACENT TO A LOCAL STREET	WHEN ADJACENT TO A DISTRICT SEPARATE PARCEL	
M-2	20 FEET	20 FEET	10 FEET	O FEET	

(a) All buildings located within the Old Towne Residential Quadrants shall have a minimum front yard setback of twenty (20) feet.

(Ords. 12-95; 20-82; 40-72; 20-62: Prior Codes 17.46.140—17.46.160 and 17.52.040—17.52.060)

THIS MAP MAY NOT SHOW THE EXISTENCE OR LOCATION OF ALL EASEMENTS WHICH MAY ENCUMBER THE SITE.

THIS SURVEY WAS BASED ON AVAILABLE RECORD INFORMATION AT THE TIME OF SURVEY. ALL LINE WORK SHOWN HAS BEEN VERIFIED TO THE REFERENCE INFORMATION AS INDICATED ON THE SURVEY.

DATE BY 534 W. STRUCK AVE PROLOGIS

ALTA/NSPS LAND TITLE SURVEY IN THE CITY OF ORANGE, LYING WIHIN SECTION 19, TOWNSHIP 4 SOUTH, RANGE 9 WEST, S.B.M., IN THE COUNTY ORANGE, CA

N/A

A L B E R T A.

S/2020

JCR

B E R T A.


ENGINEERING CONSULTANTS
3788 McCRAY STREET
RIVERSIDE CA. 92506
PH. (951) 686-1070 FAX (951) 788-1256 20-0017-ALTA.

THE FIELDWORK WAS COMPLETED ON AUGUST 17, 2020.

TO: BIRTCHER DEVELOPMENT AND FIRST AMERICAN TITLE INSURANCE COMPANY.

THIS IS TO CERTIFY THAT THIS MAP OR PLAT AND THE SURVEY ON WHICH IT IS BASED WERE MADE IN

MICHAEL E. JOHNSON, P.L.S. 7673

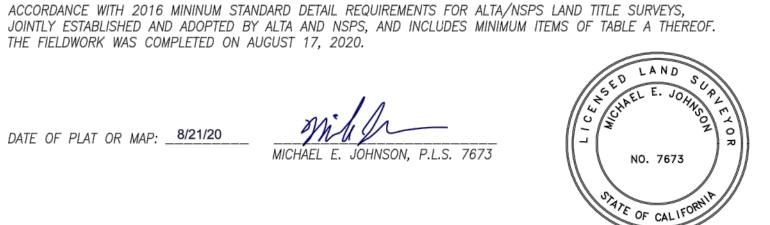


DATE: DESIGNED: CHECKED: REVISIONS

3788 McCRAY STREET RIVERSIDE CA. 92506 PH. (951) 686-1070 A S S O C | A T E S FAX (951) 788-1256

PLOT DATE: **2-Feb-2**I

LAND USE PROJECT APPLICATION ALTA - TITLE DWG. NO. 534 W. STRUCK AVENUE

OF 18 SHEET

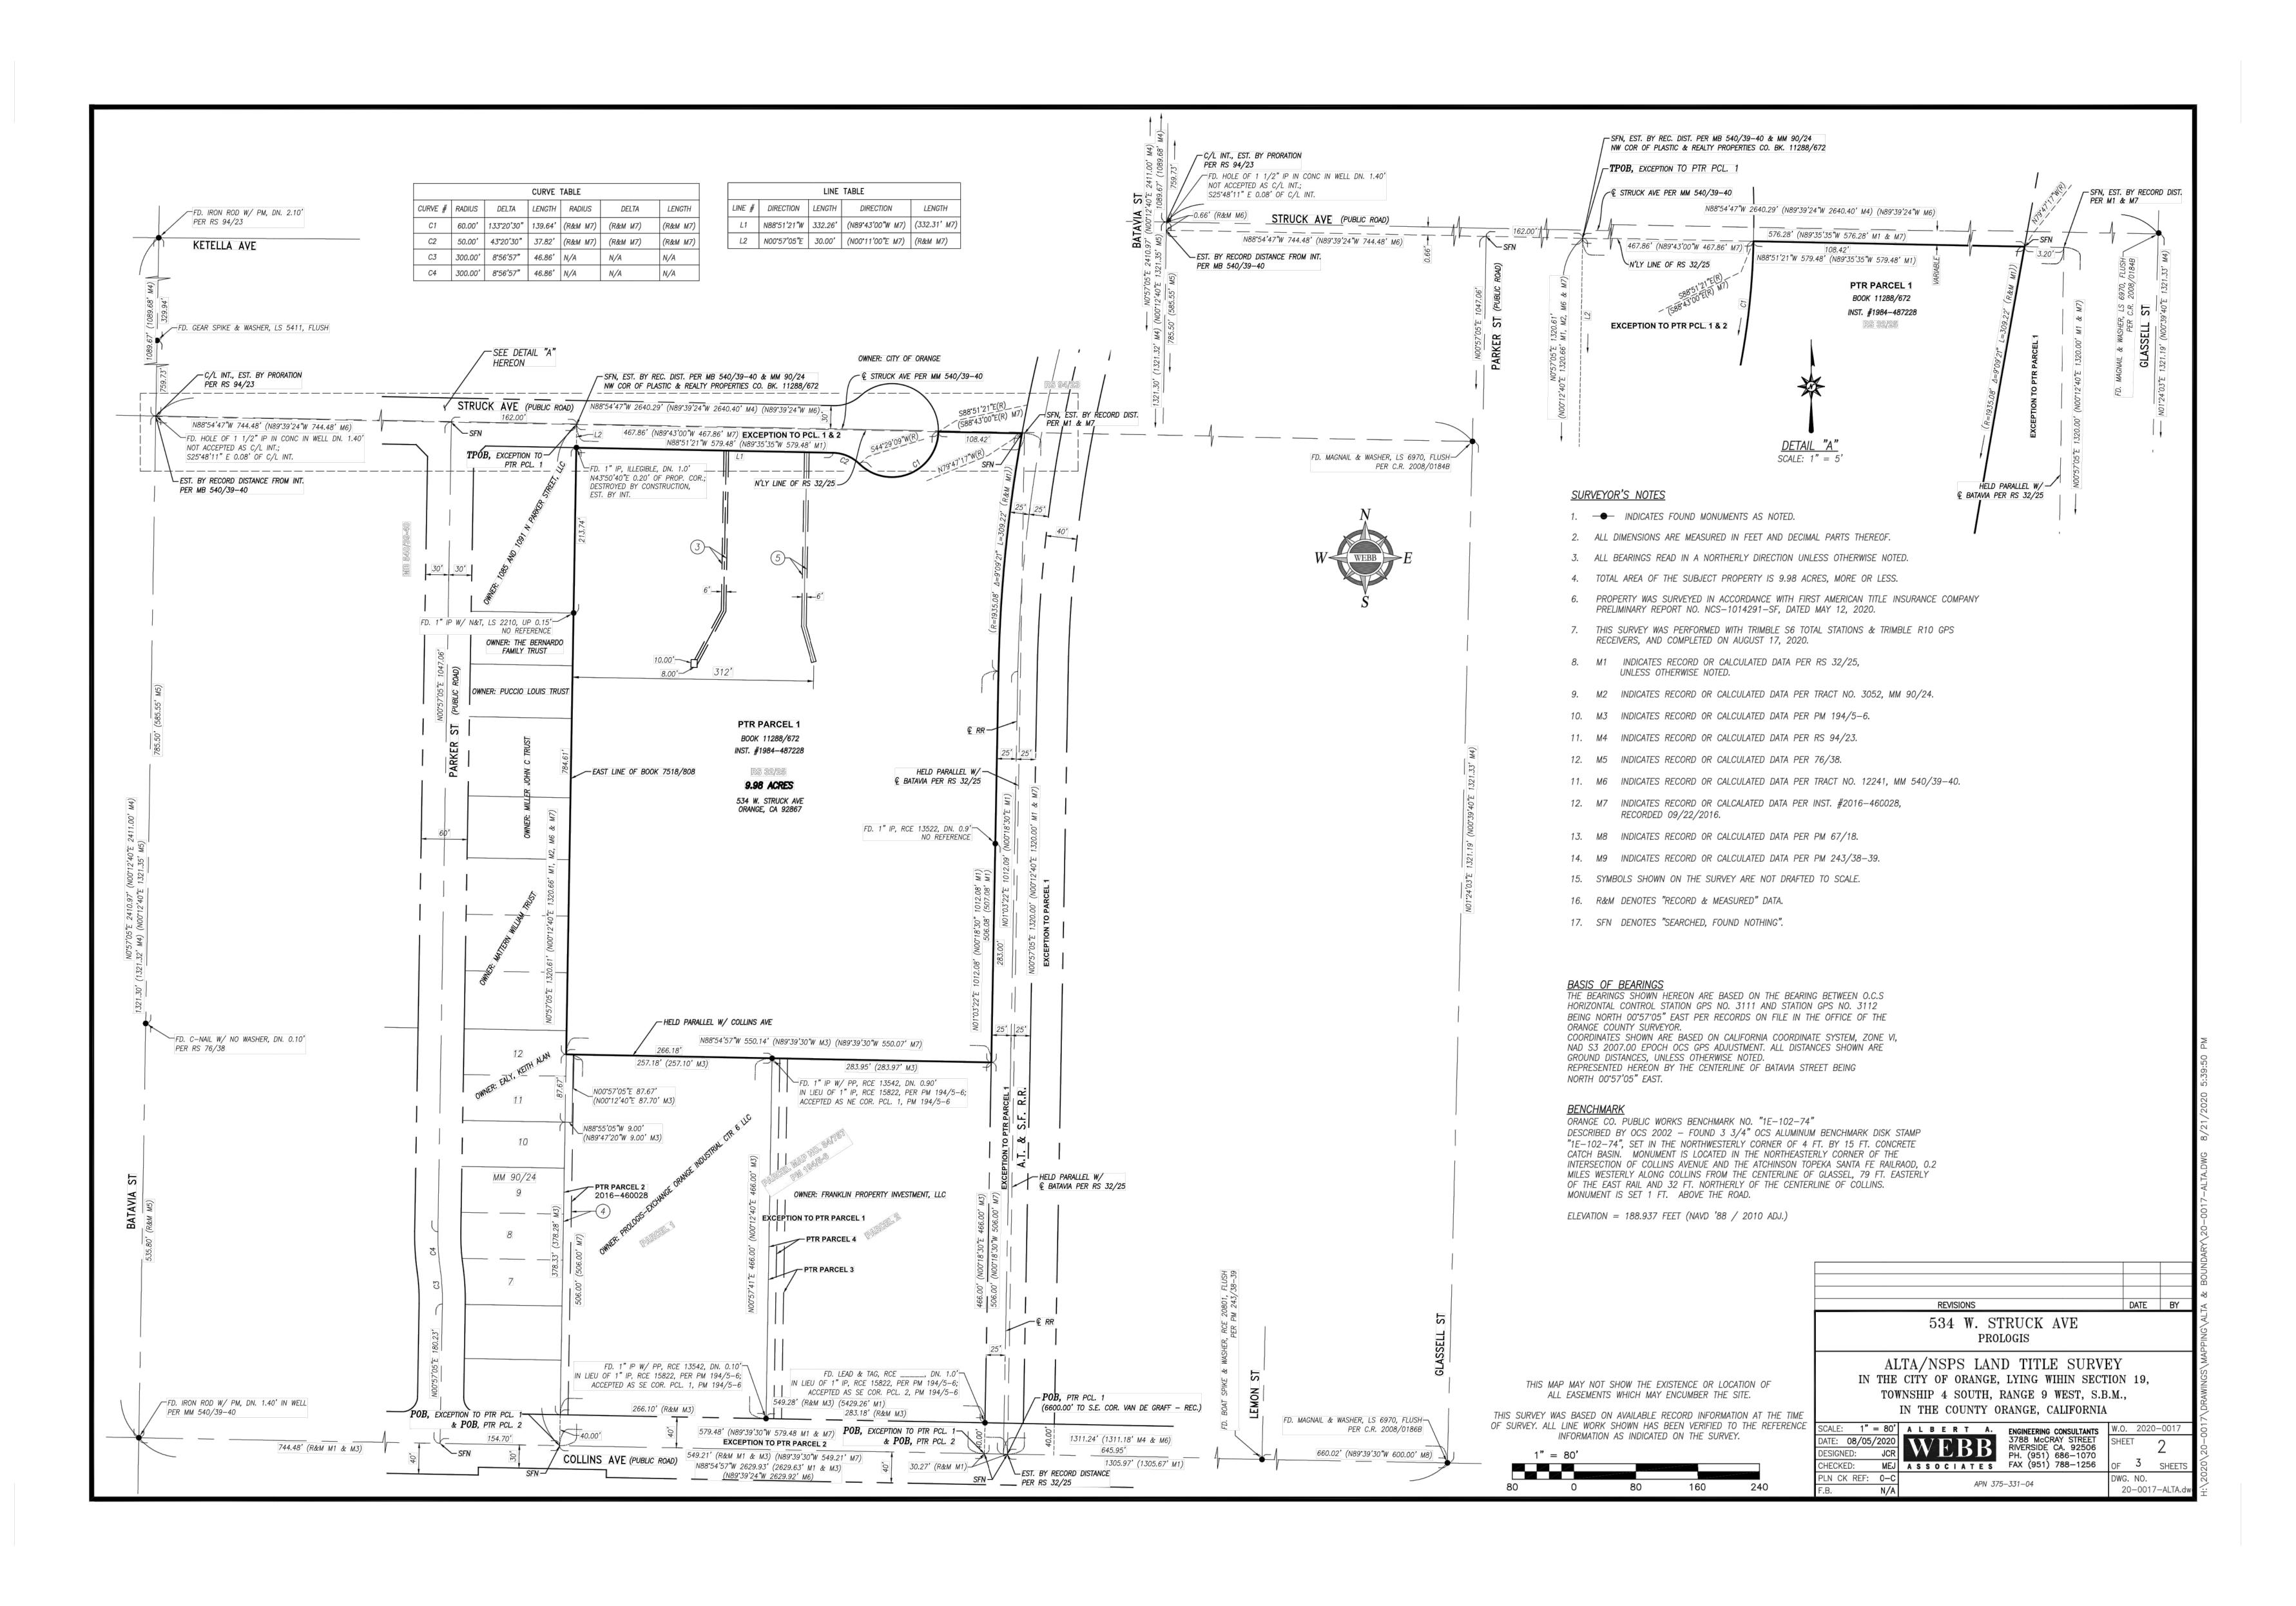

SCALE:
DATE: 2/2/2021
DESIGNED: EP
CHECKED: BJV
REVISIONS
DATE BY F.B.

DATE BY F.B.

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DATE SIZES
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PH. (951) 686-1070
FAX (951) 788-1256

DESIGNEERING CONSULTANTS
STREET RIVERSIDE CA. 92506
PH. (951) 686-1070
FAX (951) 788-1256

DESIGNED: EP
A S S O C I A T E S
PLOT DATE: 2-Feb-21

DATE BY F.B.

ENGINEERING CONSULTANTS
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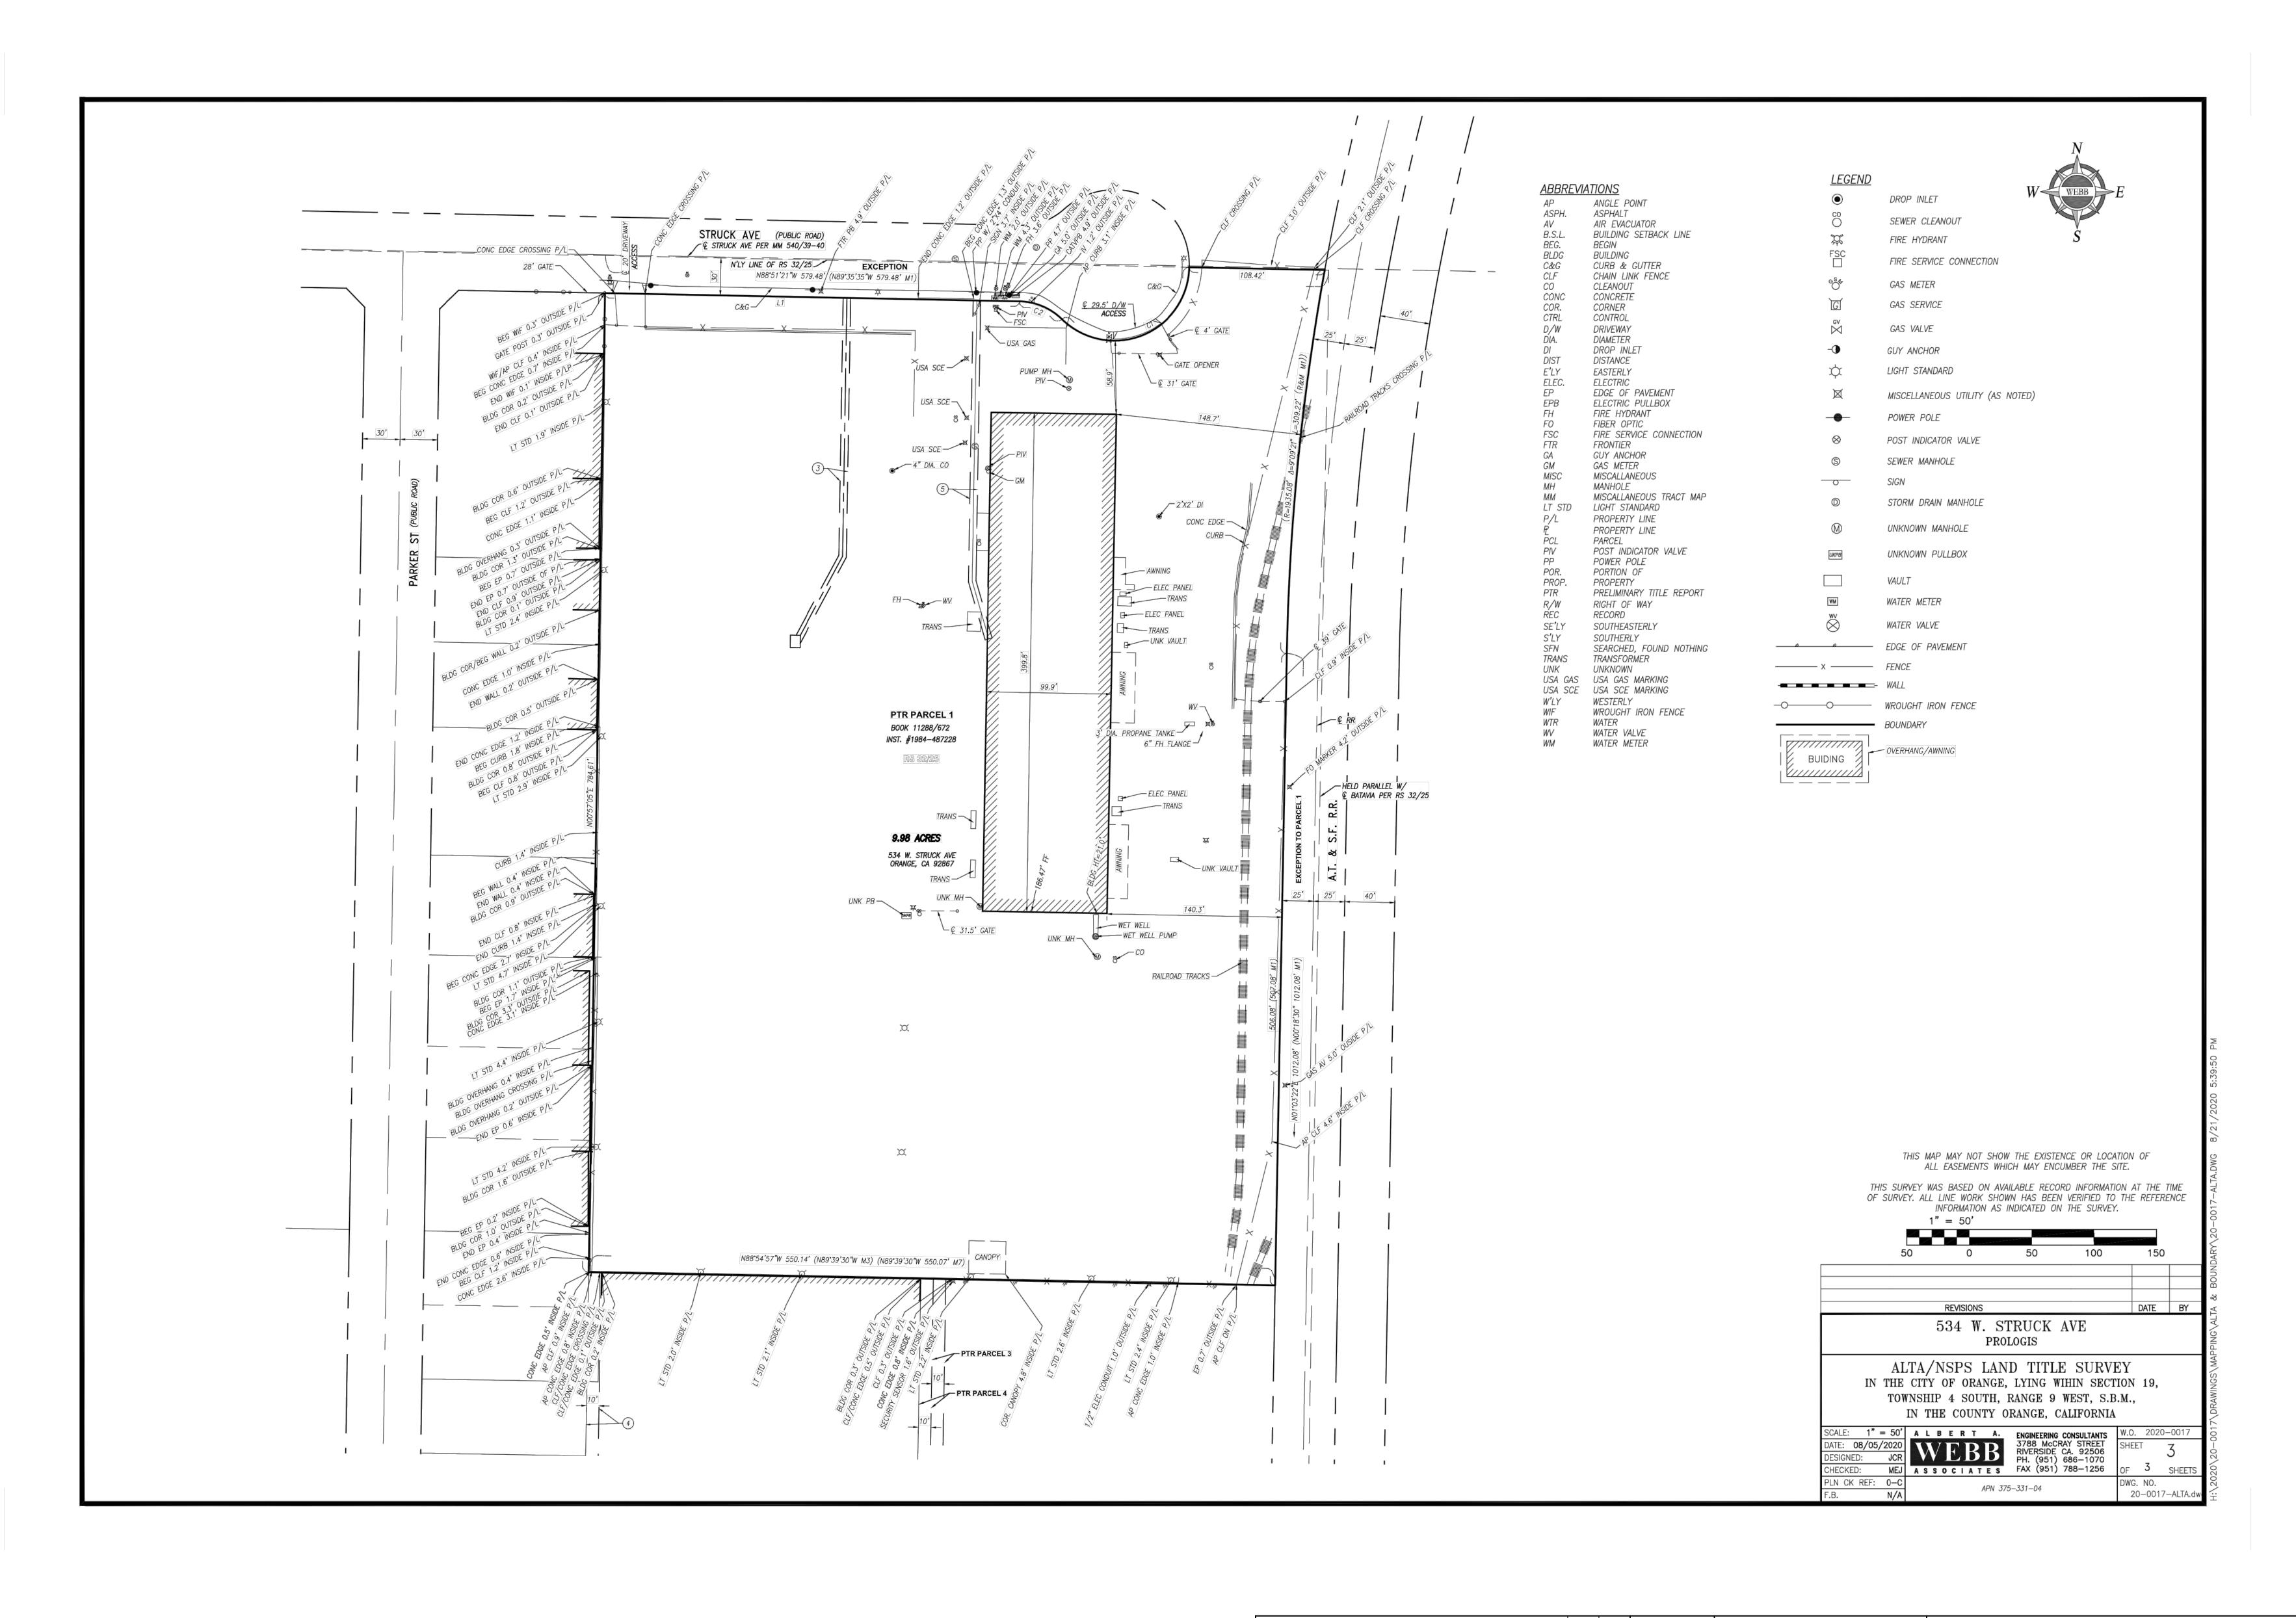
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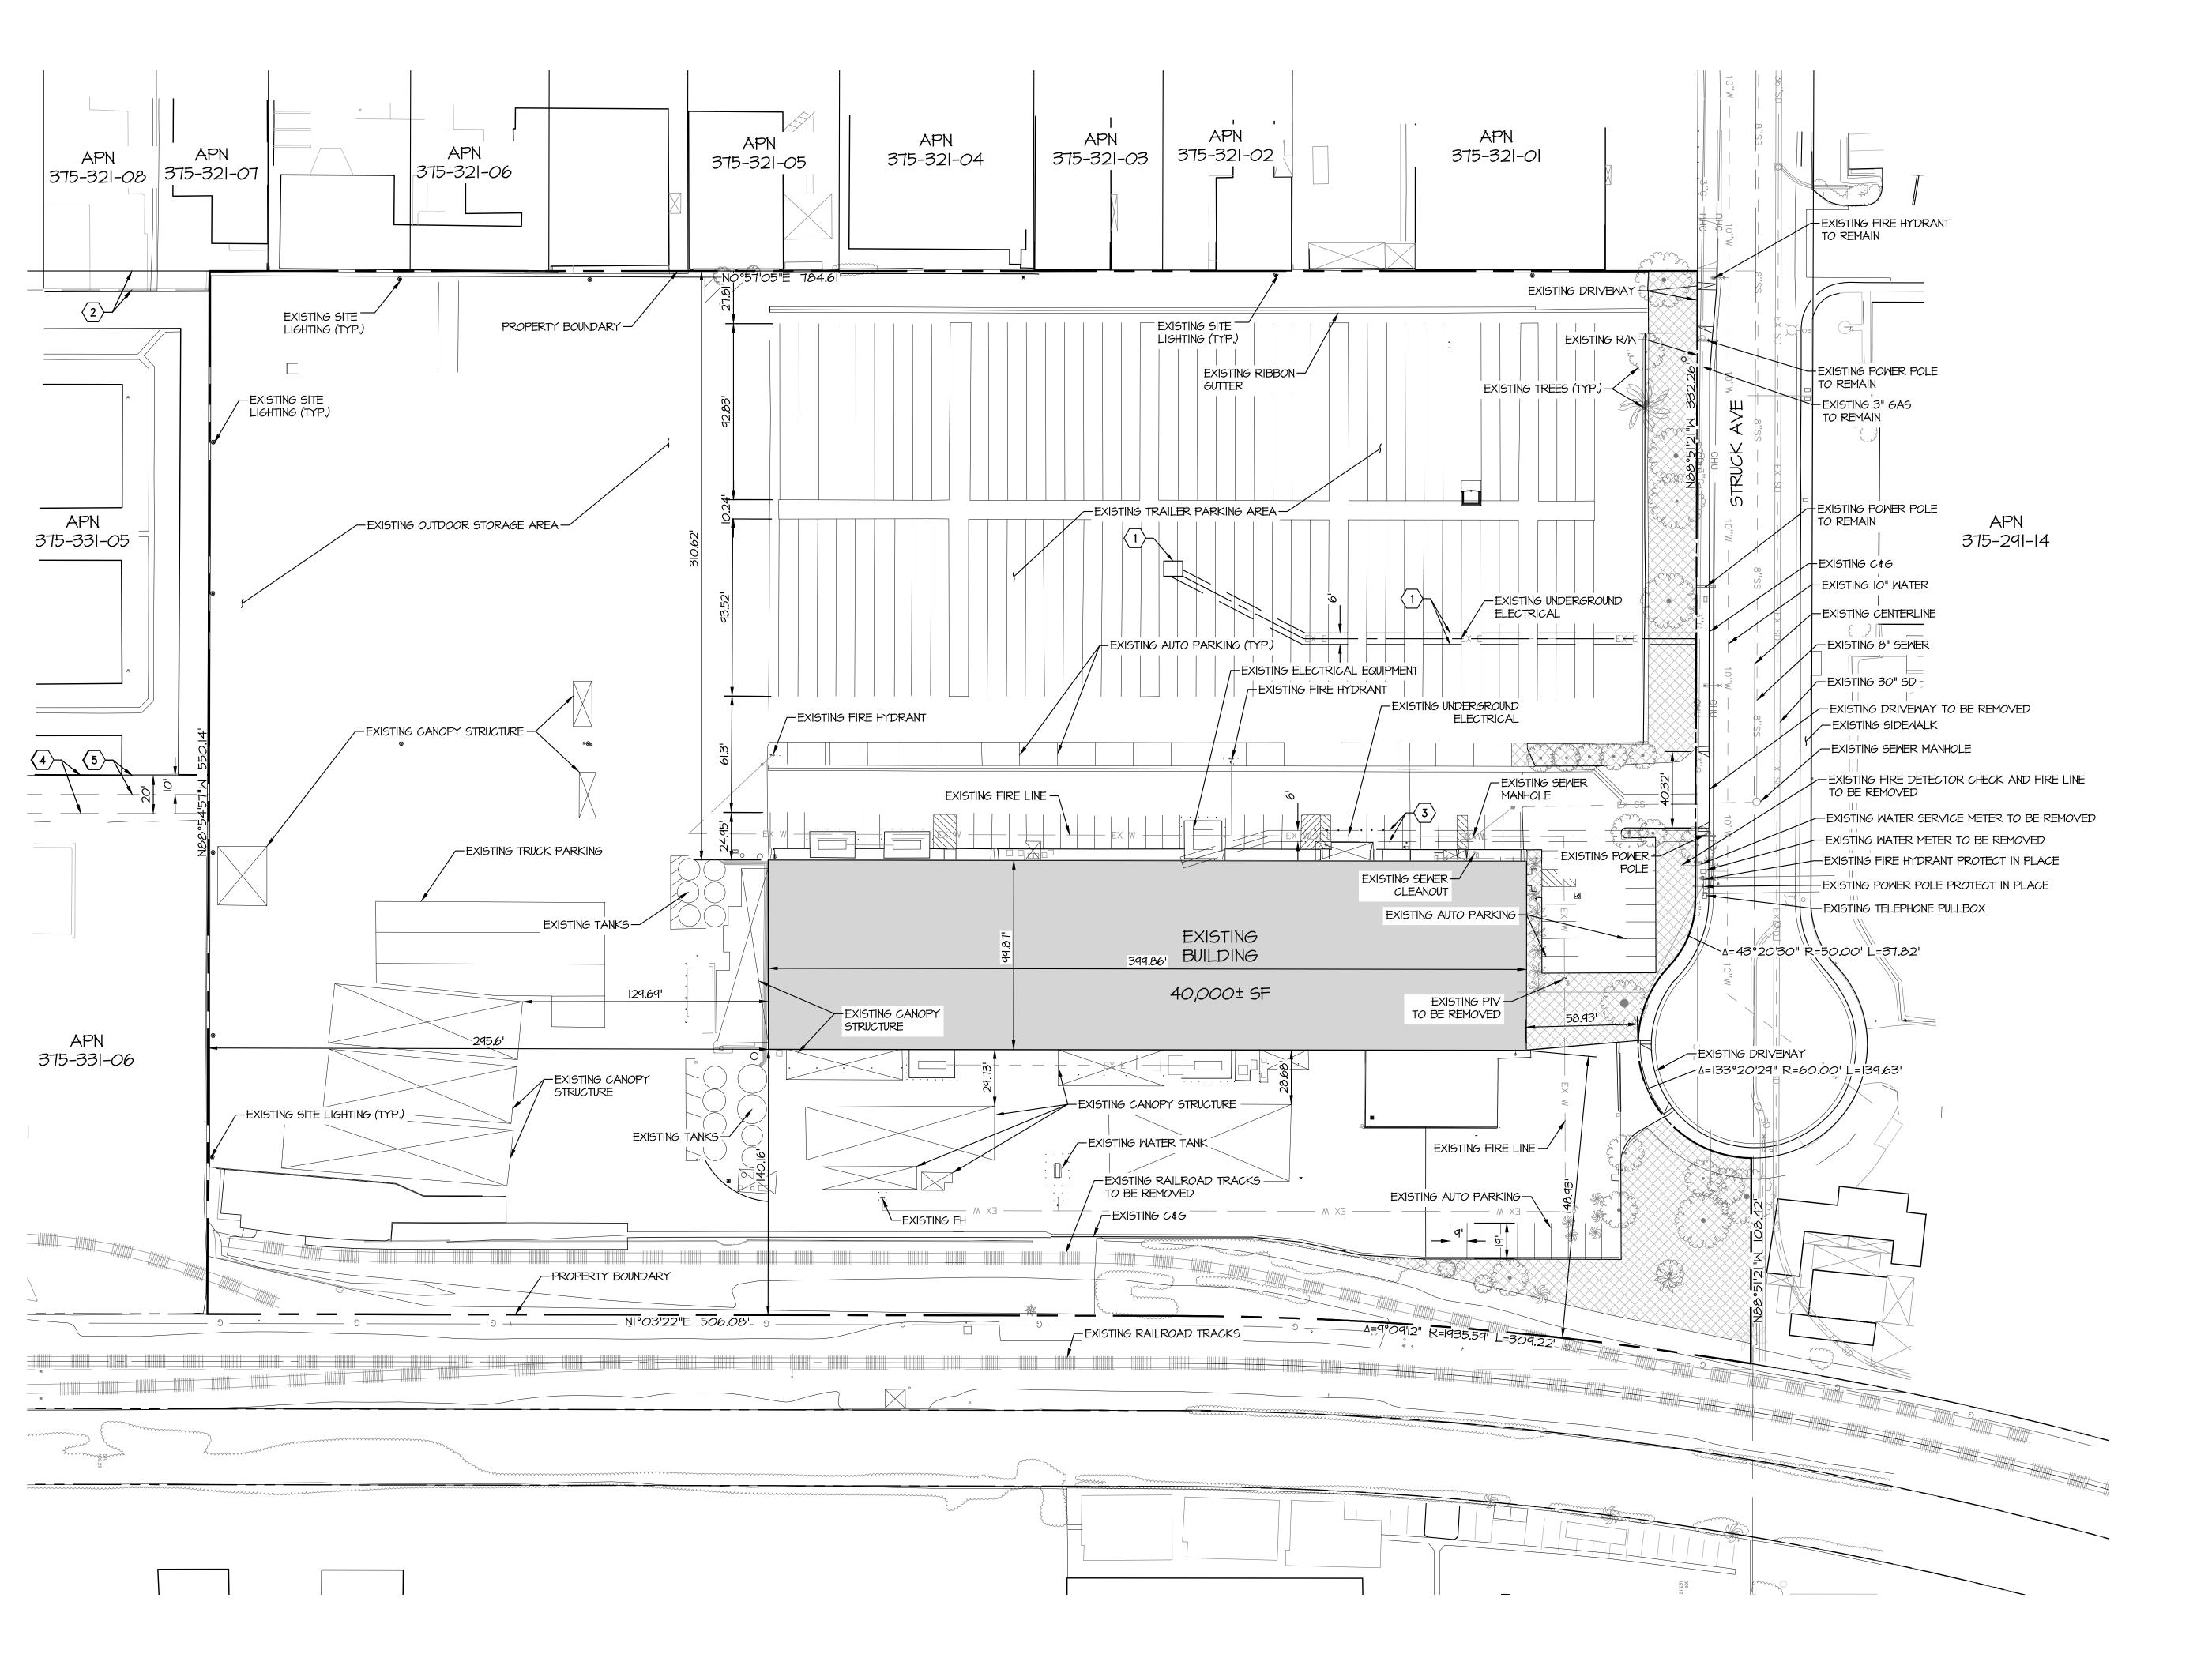
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EASEMENT TABLE

AN EASEMENT IN FAVOR OF SOUTHERN CALIFORNIA EDISON COMPANY FOR UNDERGROUND ELECTRICAL SUPPLY SYSTEMS AND COMMUNICATION SYSTEMS AND INCIDENTAL PURPOSES, RECORDED FEBRUARY 04, 1975 AS INSTRUMENT NO 1873, IN BOOK 11335, PAGE 37 OF OFFICIAL RECORDS. TO BE QUITCLAIMED.

AN EASEMENT IN FAVOR OF PLASTIC AND REALTY PROPERTIES COMPANY FOR PIPELINES, MAINS AND CONDUITS AND INCIDENTAL PURPOSES, RECORDED NOVEMBER 15, 1974 AS INSTRUMENT NO. 1304, IN BOOK 11288, PAGE 672 OF OFFICIAL RECORDS.

AN EASEMENT IN FAVOR OF SOUTHERN CALIFORNIA EDISON COMPANY FOR UNDERGROUND ELECTRICAL SUPPLY SYSTEMS AND COMMUNICATION SYSTEMS AND INCIDENTAL PURPOSES, RECORDED APRIL 02, 1985 AS INSTRUMENT NO. 1985-115999 OF OFFICIAL RECORDS. TO BE QUITCLAIMED.

A NON-EXCLUSIVE EASEMENT FOR INGRESS AND EGRESS ON AND OVER THE WESTERLY 20 FEET OF PARCEL 2 OF PARCEL MAP NO. 84-757, IN THE CITY OF ORANGE AS SHOWN ON A MAP FILED IN BOOK 194, PAGES 5 AND 6 OF PARCEL MAPS, AS SET FORTH IN THAT CERTAIN DEED AND GRANT OF EASEMENT RECORDED APRIL 05, 1985 AS INSTRUMENT NO. 85-121284 OF OFFICIAL RECORDS OF THE COUNTY OF ORANGE


A NON-EXCLUSIVE EASEMENT FOR THE PLACEMENT AND INSTALLATION OF UTILITIES ON, IN AND OVER THE WESTERLY IO FEET OF PARCEL 2 OF PARCEL MAP 84-757, IN THE CITY OF ORANGE AS SHOWN ON A MAP FILED IN BOOK 194, PAGES 5 AND 6 OF PARCEL MAPS, AS SET FORTH IN THAT CERTAIN DEED AND GRANT OF EASEMENT RECORDED APRIL 05, 1985 AS INSTRUMENT NO. 85-121284 OF OFFICIAL RECORDS OF THE COUNTY OF

<u>LEGEND</u>


EXISTING LANDSCAPED AREA


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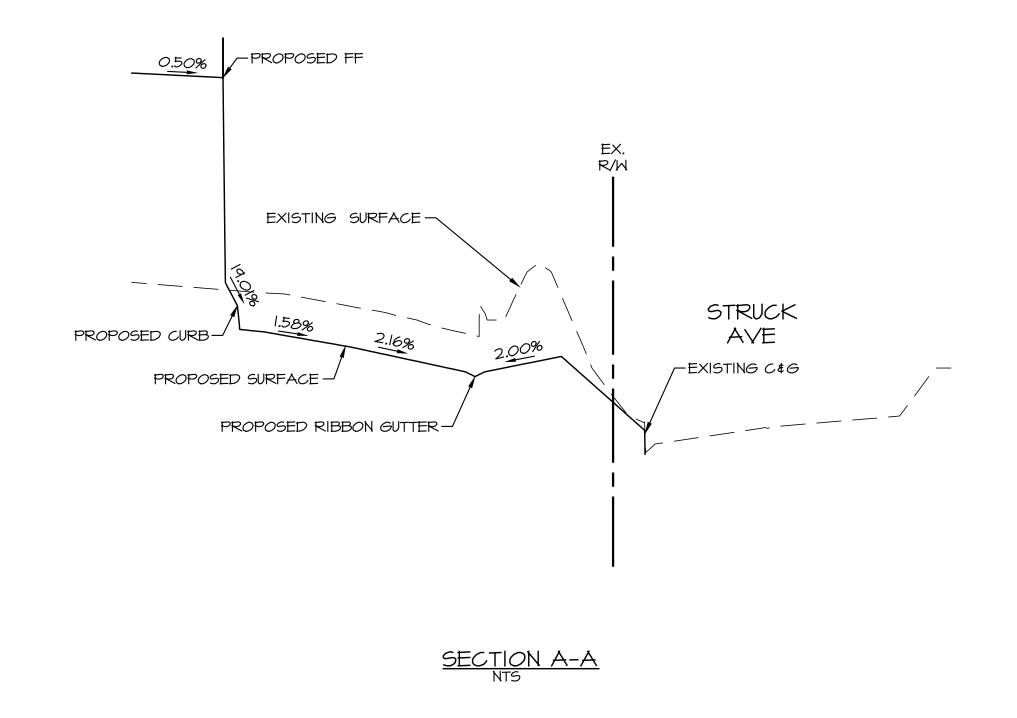
EXISTING BUILDING, SURROUNDING ON-SITE IMPROVEMENTS, AND UNDERGROUND UTILITES TO BE DEMOLISHED.

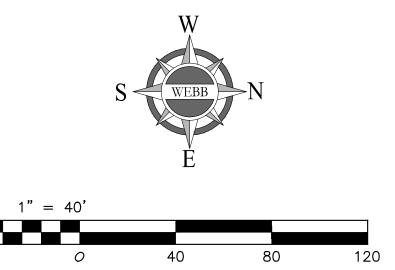



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		SCALE:	I" = 40'	ENGINEERING CONSULTANTS	LANDUGE DDA JECT ADDI ICATION	W.O. 2020-0017	/2/
		DATE: 2	2/2/2021	3788 McCRAY STREET RIVERSIDE CA. 92506		SHEET	20
		DESIGNED:	EP	PH. (951) 686-1070	I FYISTING SITE PLAN		720
		CHECKED:	BJV	ASSOCIATES FAX (951) 788-1256		OF 18 SHEETS	Í.
		PLN CK REF:		DLOT DATE 2 Feb 2	534 W. STRUCK AVENUE	DWG. NO.	
REVISIONS DATE	ΒY	F.B.	·	PLOT DATE: 2-Feb-2I	JUA M. DIRUCK AVLINUL		




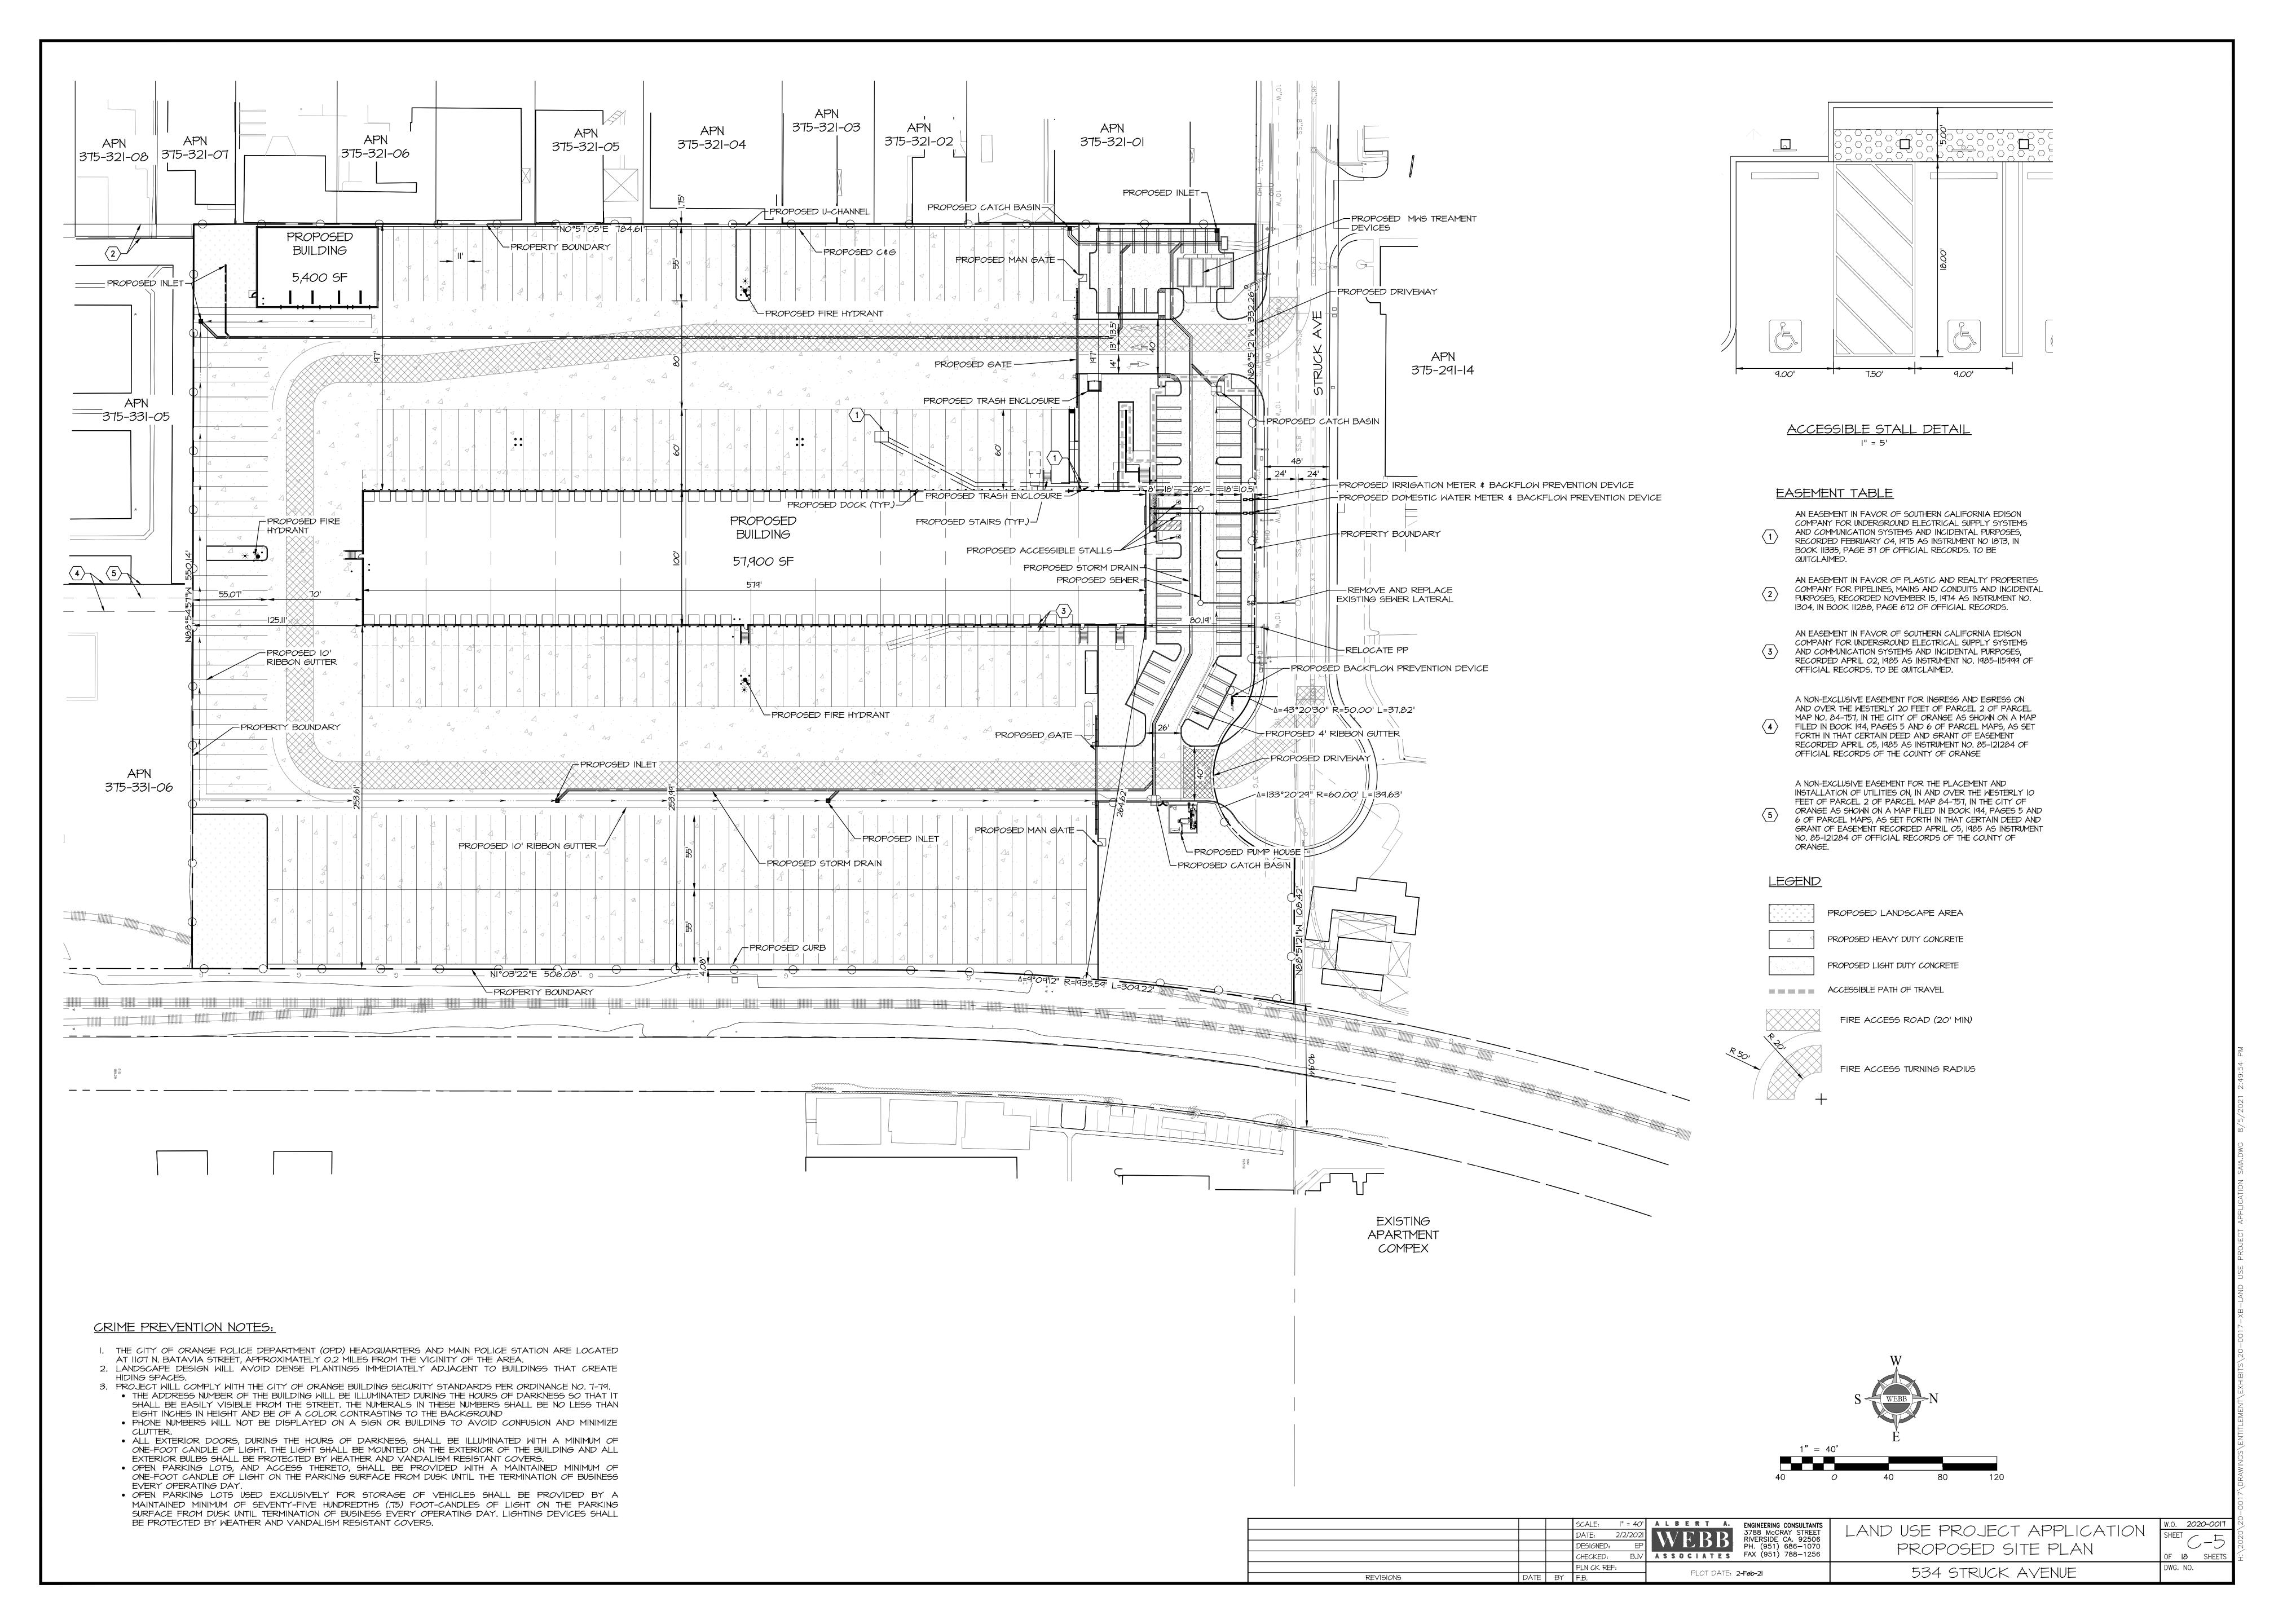

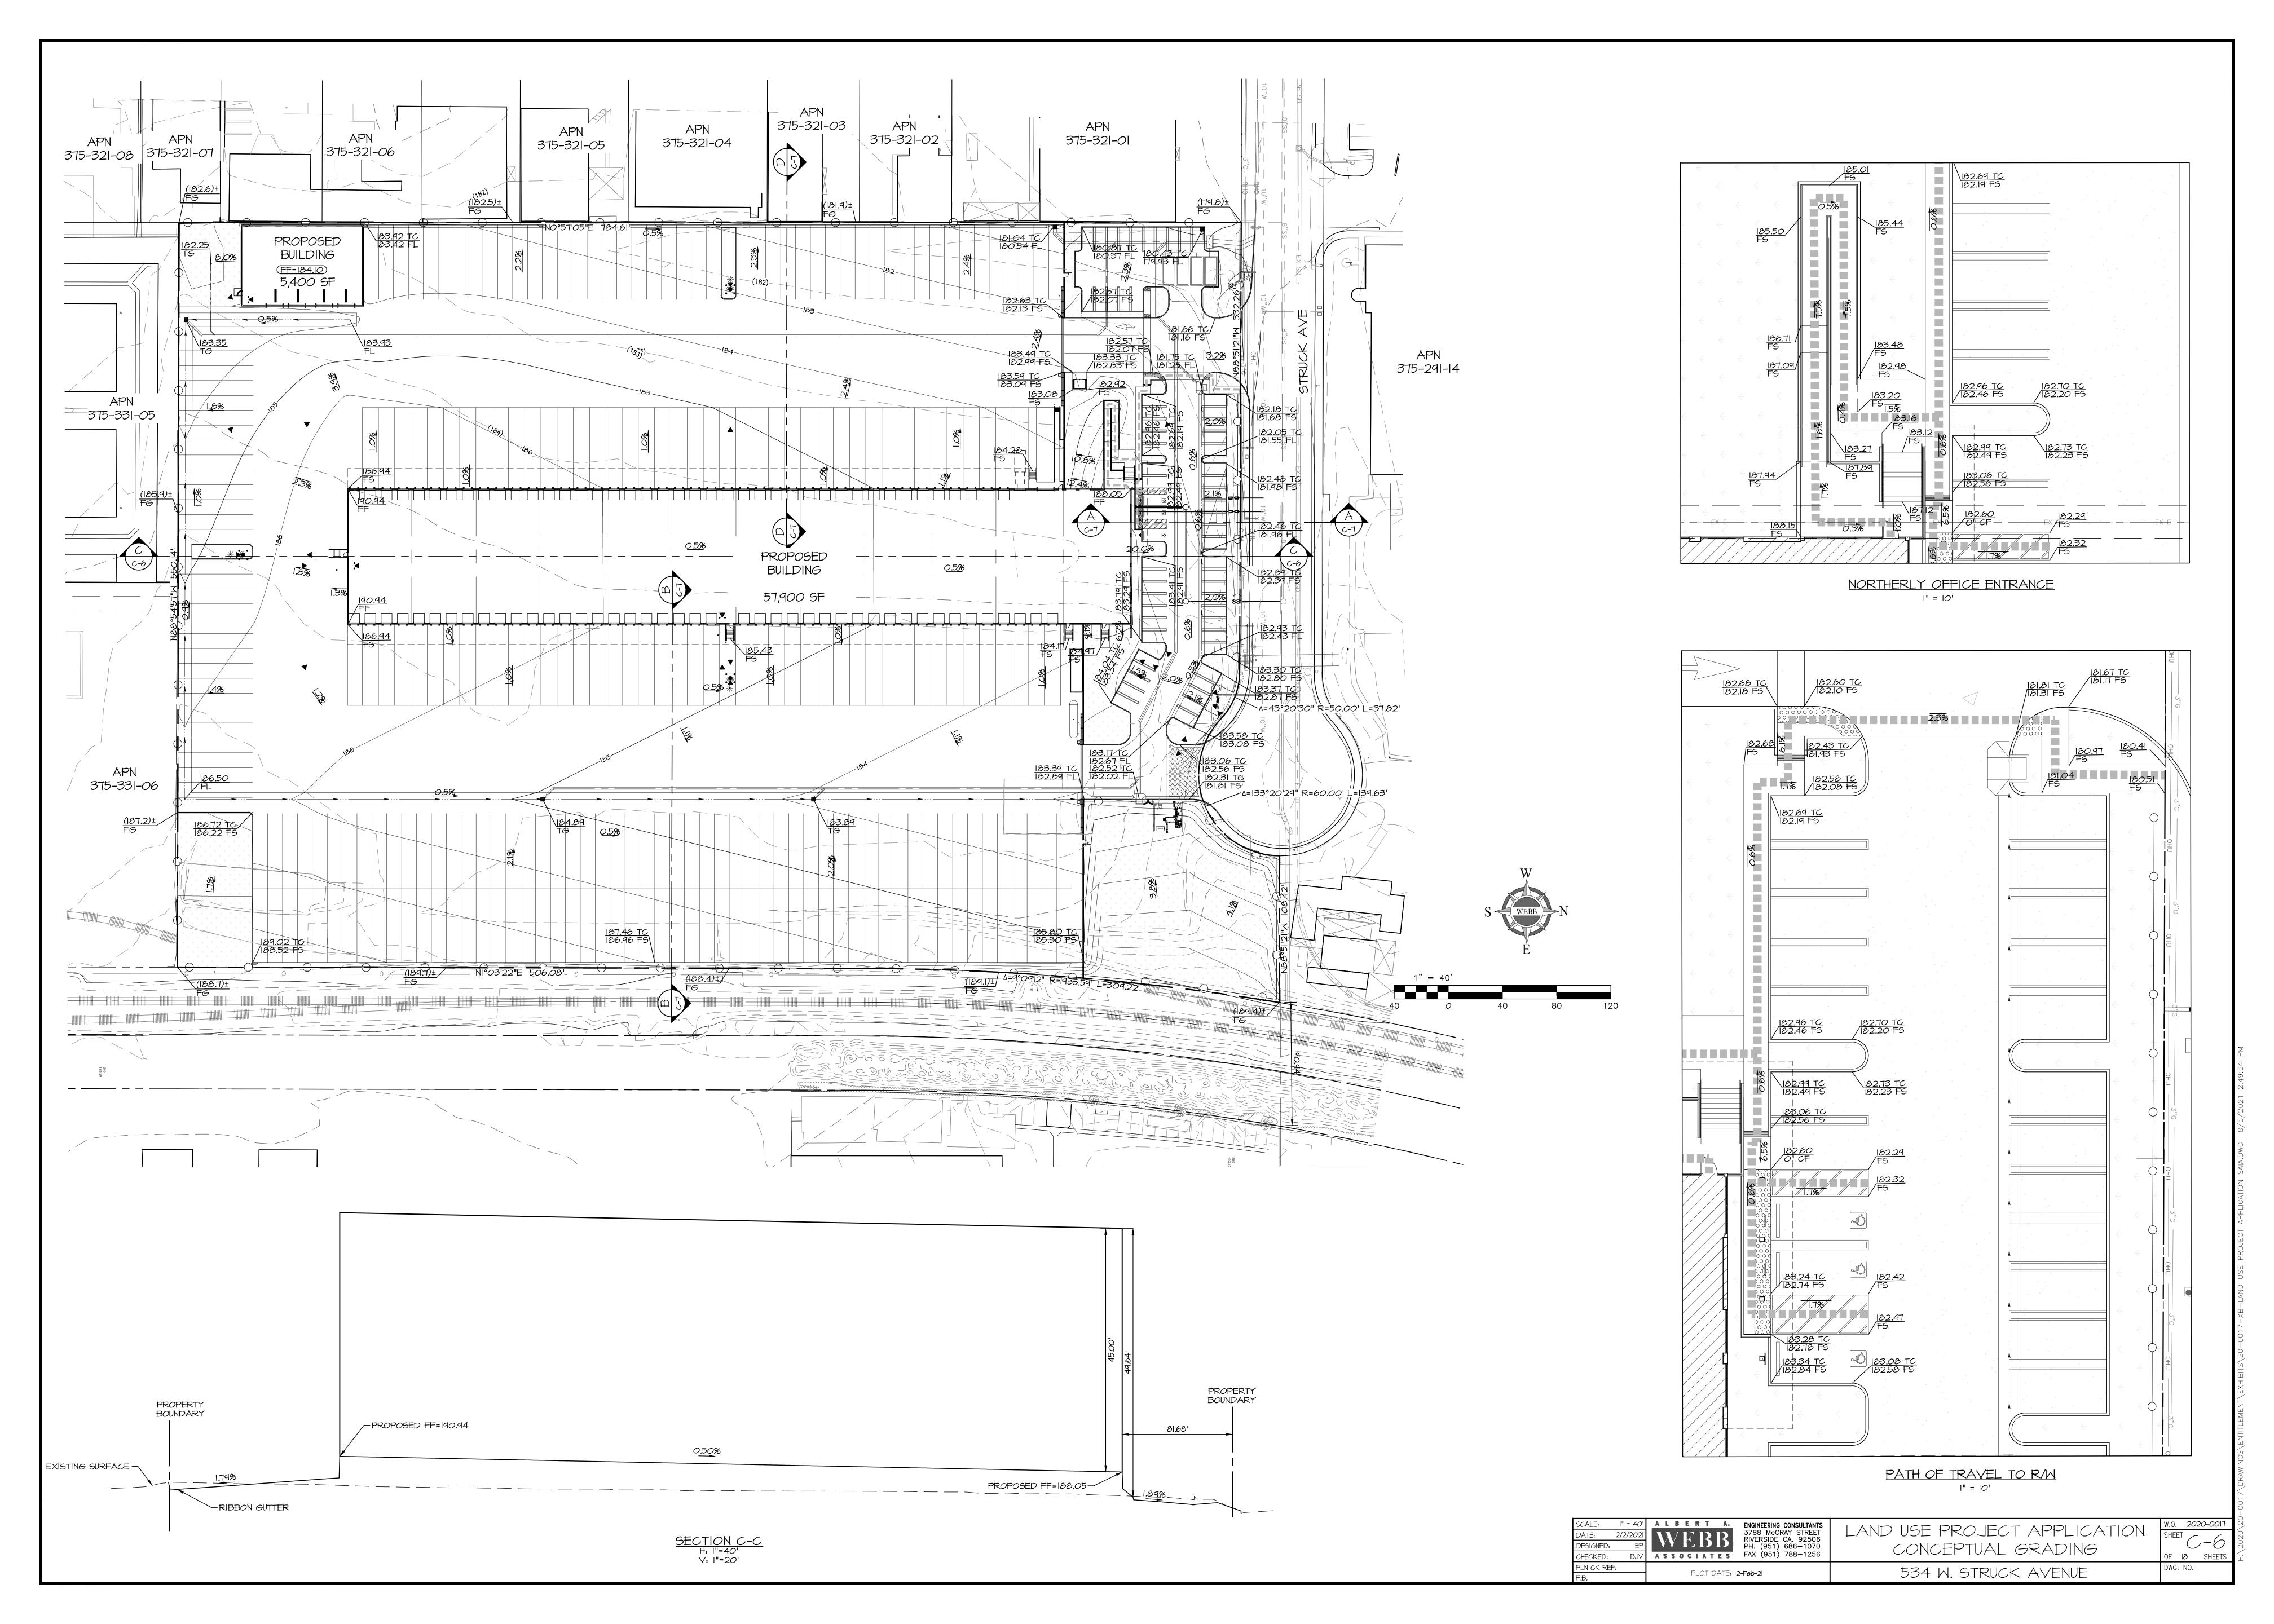

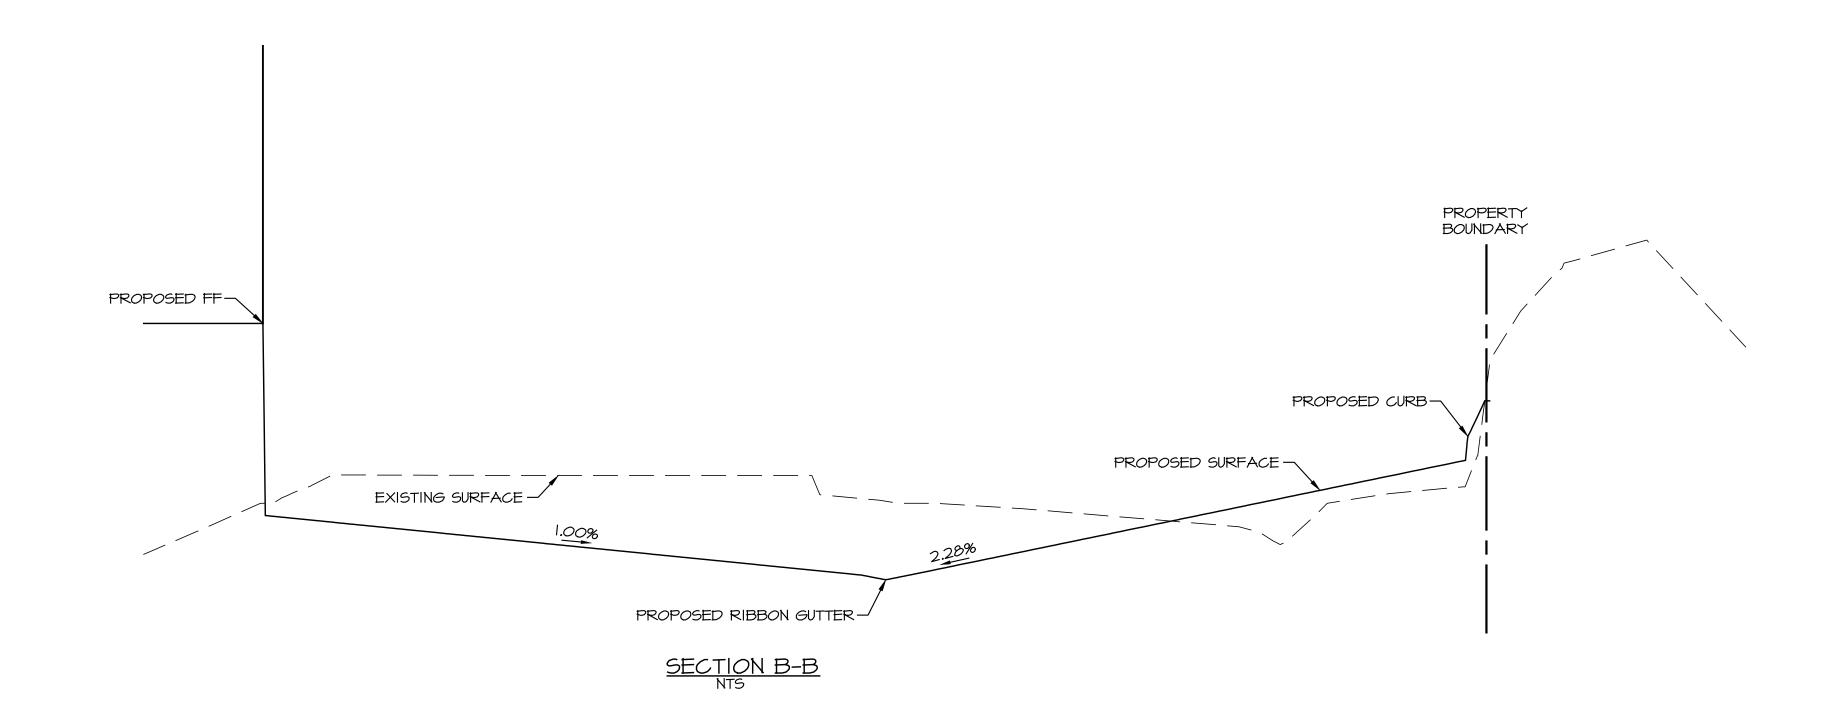

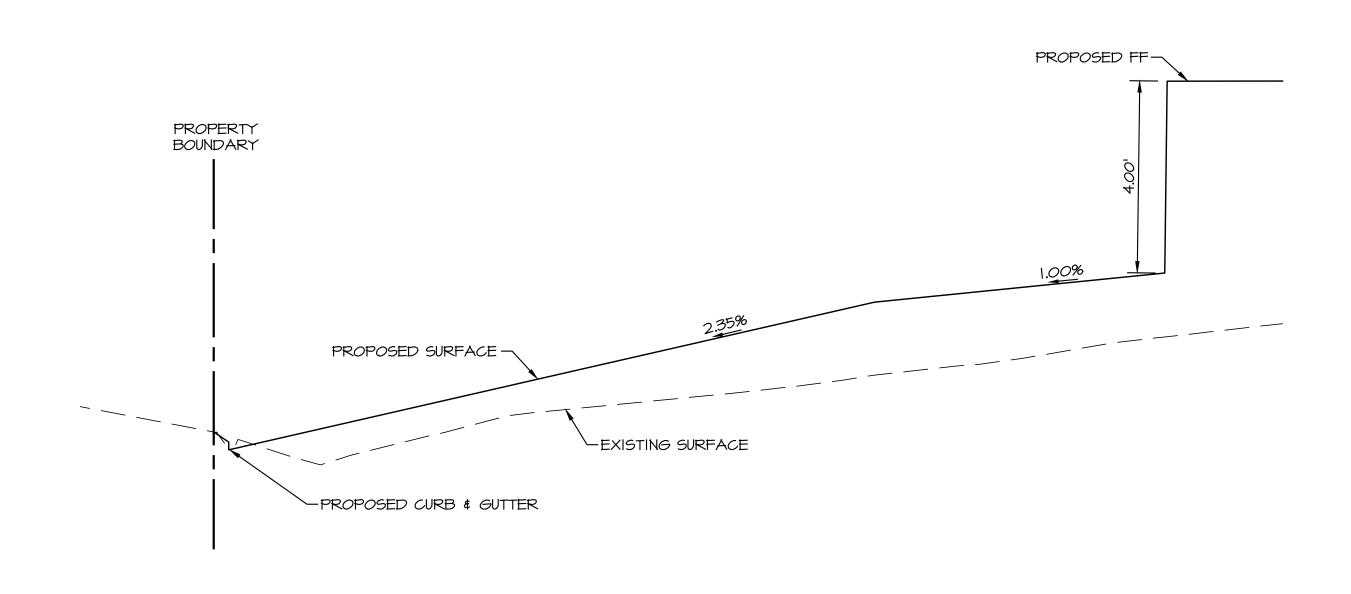

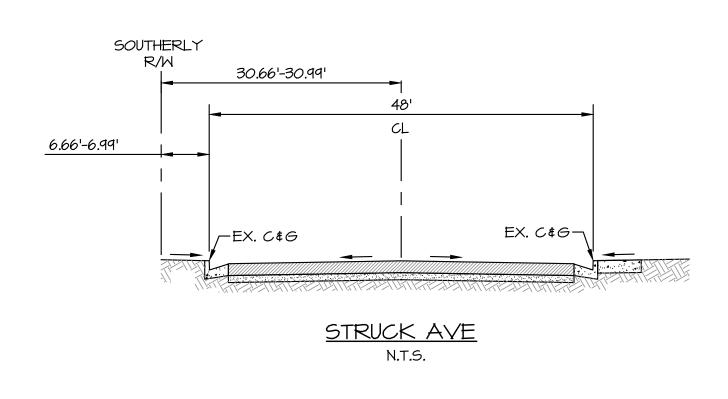

SECTION D-D NTS

SCALE: N/A L B E R T A. DATE: 2/2/2021
DESIGNED: EP CHECKED: BJV ASSOCIATES FAX (951) 788-1256

PLN CK REF: F.B.

ENGINEERING CONSULTANTS 3788 McCRAY STREET RIVERSIDE CA. 92506 PH. (951) 686-1070 FAX (951) 788-1256

CROSS-SECTIONS

W.O. 2020-0017
SHEET C - 7
OF 18 SHEETS

DWG. NO.

DWG. NO.

IN THE CITY OF ORANGE, STATE OF CALIFORNIA MAJOR SITE PLAN REVIEW NO. 1039-21 DESIGN REVIEW NO. 5028-21 CONDITIONAL USE PERMIT NO. 3137-21 APN 375-331-04 CONCEPTUAL FIRE PROTECTION PLAN

ORANGE CITY FIRE DEPARTMENT NOTES

GENERAL REQUIREMENTS

- I. FIRE LANE WIDTHS SHALL BE MEASURED FROM TOP FACE OF THE CURB TO TOP FACE OF THE CURB FOR FIRE LANES WITH STANDARD CURBS AND GUTTERS AND FROM FLOW-LINE TO FLOW-LINE FOR FIRE LANES WITH MODIFIED CURB DESIGNS (E.G. ROLLED, RAMPED, ETC). THE DEVELOPER IS RESPONSIBLE TO VERIFY THAT ALL APPROVED PUBLIC WORKS OR GRADING DEPARTMENT STREET IMPROVEMENT PLANS OR PRECISE GRADING PLANS CONFORM TO THE MINIMUM STREET WIDTH MEASUREMENTS PER THE APPROVED OFD FIRE MASTER PLAN.
- 2. PERMANENT, TEMPORARY, AND PHASED EMERGENCY ACCESS ROADS SHALL BE DESIGNED AND MAINTAINED TO SUPPORT AN IMPOSED LOAD OF 68,000 LBS. AND SURFACED TO PROVIDE ALL-WEATHER DRIVING CAPABILITIES.
- 3. ADDITIONAL FIRE LANE MARKINGS MAY BE REQUIRED AT THE TIME OF INSPECTION DEPENDING ON FIELD CONDITIONS.
- 4. ADDRESS NUMBERS SHALL BE LOCATED AND BE OF A COLOR AND SIZED SO AS TO BE PLAINLY VISIBLE AND LEGIBLE FROM THE ROADWAY.
- 5. ACCESS GATES SHALL BE APPROVED PRIOR TO INSTALLATION AND SHALL BE IN COMPLIANCE WITH CHAPTER 5 OF THE CFC.
- 6. APPROVED ACCESS WALKWAYS SHALL BE PROVIDED TO ALL REQUIRED OPENINGS AND ALL RESCUE WINDOWS.
- 7. VEGETATION SHALL BE SELECTED AND MAINTAINED IN SUCH A MANNER AS TO ALLOW IMMEDIATE ACCESS TO ALL HYDRANTS, VALVES, FIRE DEPARTMENT CONNECTIONS, PULL STATIONS, EXTINGUISHERS, SPRINKLER RISERS, ALARM CONTROL PANELS, RESCUE WINDOWS, AND OTHER DEVICES OR AREAS USED FOR FIREFIGHTING PURPOSES.

 VEGETATION OR BUILDING FEATURES SHALL NOT OBSTRUCT ADDRESS NUMBERS OR INHIBIT THE FUNCTIONING OF ALARM BELLS, HORNS, OR STROBES.
- 8. DUMPSTERS AND TRASH CONTAINERS LARGER THAN 1.5 CUBIC YARDS SHALL NOT BE STORED IN BUILDINGS OR PLACED WITHIN 5 FEET OF COMBUSTIBLE WALLS, OPENINGS OR COMBUSTIBLE ROOF EAVE LINES UNLESS PROTECTED BY AN APPROVED SPRINKLER SYSTEM.
- 9. ANY FUTURE MODIFICATION TO THE APPROVED FIRE MASTER PLAN OR APPROVED SITE PLAN, INCLUDING BUT NOT LIMITED TO ROAD WIDTH, GRADE, SPEED HUMPS, TURNING RADII, GATES OR OTHER OBSTRUCTIONS, SHALL REQUIRE REVIEW, INSPECTION, AND APPROVAL BY THE OFD.
- IO. APPROVAL OF THIS PLAN SHALL NOT BE CONSTRUED AS APPROVAL OF ANY INFORMATION OR PROJECT CONDITIONS OTHER THAN THOSE ITEMS AND REQUIREMENTS IDENTIFIED IN RELATED PORTIONS OF THE 2019 CFC AND CBC AND ORANGE MUNICIPAL CODE. THIS PROJECT MAY BE SUBJECT TO ADDITIONAL REQUIREMENTS NOT STATED HEREIN UPON EXAMINATION OF ACTUAL SITE AND PROJECT CONDITIONS OR DISCLOSURE OF ADDITIONAL INFORMATION. PROJECT-SPECIFIC REQUIREMENTS (INCLUDE ONLY THOSE NOTES THAT ARE APPLICABLE TO THE PROJECT AS DESIGNED; SOME NOTES MAY NEED TO BE MODIFIED TO ADDRESS SPECIFIC PROJECT CONDITIONS)
- II. AN UNDERGROUND PIPING PLAN IS REQUIRED FOR THE INSTALLATION OF AN AUTOMATIC FIRE SPRINKLER SYSTEM OR FOR A PRIVATE FIRE HYDRANT SYSTEM. A SEPARATE PLAN SUBMITTAL IS REQUIRED.
- I2. A CHEMICAL CLASSIFICATION AND HAZARDOUS MATERIALS COMPLIANCE PLAN SHALL BE APPROVED BY THE OFD PRIOR TO ANY HAZARDOUS MATERIALS BEING STORED OR USED ON SITE. A SEPARATE PLAN SUBMITTAL IS REQUIRED.
- 13. BUILDINGS USED FOR HIGH-PILED STORAGE SHALL COMPLY WITH CFC REQUIREMENTS. A SEPARATE PLAN SUBMITTAL IS REQUIRED IF MATERIALS WILL BE STORED HIGHER THAN 12 FEET FOR LOWER-HAZARD COMMODITIES, OR HIGHER THAN FIVE FEET FOR HIGH-HAZARD COMMODITIES SUCH AS PLASTICS, RUBBER, FLAMMABLE/COMBUSTIBLE LIQUIDS, TIRES, CARPET, ETC.
- 14. AN AUTOMATIC FIRE SPRINKLER SYSTEM SHALL BE INSTALLED IN ACCORDANCE WITH APPLICABLE CODES AND ORDINANCES, AMENDMENTS, AND GUIDELINES. SPRINKLER SYSTEMS, OTHER THAN THOSE LISTED IN CFC CHAPTER 9, SHALL BE MONITORED BY AN APPROVED CENTRAL STATION. SEPARATE PLAN SUBMITTALS FOR THE SPRINKLER AND MONITORING SYSTEMS ARE REQUIRED. DESIGN OF AN AUTOMATIC FIRE SPRINKLER SYSTEM SHALL BE BASED ON A CURRENT FLOW TEST (WITHIN 12 MONTHS OF THE SUBMITTED DESIGN) WHICH HAS BEEN CONDUCT PER NFPA 13 REQUIREMENTS AND WITNESSED BY A FIRE DEPARTMENT REPRESENTATIVE AND PER ORANGE MUNICIPAL CODE.
- 15. BUILDINGS CONTAINING INDUSTRIAL REFRIGERATION SYSTEMS SHALL COMPLY WITH CFC REQUIREMENTS. A SEPARATE PLAN SUBMITTAL IS REQUIRED IF REFRIGERANT QUANTITIES EXCEED THRESHOLDS.
- I6. A FIRE ALARM SYSTEM SHALL BE INSTALLED IN ACCORDANCE WITH APPLICABLE CODES AND ORDINANCES, AMENDMENTS, AND GUIDELINES. A SEPARATE PLAN SUBMITTAL IS REQUIRED.
- IT. COMPRESSED GAS CYLINDERS AND/OR TANKS SHALL BE INSTALLED IN ACCORDANCE WITH APPLICABLE CODES AND ORDINANCES. A SEPARATE PLAN SUBMITTAL IS REQUIRED IF QUANTITIES EXCEED THRESHOLDS.
- 18. STRUCTURES LOCATED IN A FIRE HAZARD SEVERITY ZONE, SPECIAL FIRE PROTECTION AREA, OR WILDLAND-URBAN INTERFACE FIRE AREA ARE SUBJECT TO THE CONSTRUCTION REQUIREMENTS PRESCRIBED IN CHAPTER 7A OF THE 2019 CBC AND/OR SECTION 327 OF THE 2016 CRC. CONSTRUCTION MATERIALS/METHODS ARE REVIEWED AND INSPECTED BY THE BUILDING DEPARTMENT.


FIRE FLOW TEST


THE FOLLOWING FIRE FLOW TEST INFORMATION WAS OBTAINED:

• A FIELD TEST DATED MAY 19, 2020 INDICATED THE WATER SYSTEM IS CAPABLE OF SUPPLYING 1,710 G.P.M. AT 20 PSI RESIDUAL PRESSURE ON THE HYDRANT LOCATED AT THE CUL-DE-SAC OF STRUCK AVENUE.

DEFERRED SUBMITTALS

- FIRE SPRINKLER PLAN
 FIRE SPRINKLER PLAN
- UNDERGROUND FIRE LINE SERVICE
 FIRE SPRINKLER MONITORING/ALAR
- FIRE SPRINKLER MONITORING/ALARM SYSTEMSEMERGENCY RESPONDER RADIO COMMUNICATION SYSTEM
- RACK STORAGEUNDERGROUND/ABOVEGROUND STORAGE TANKS

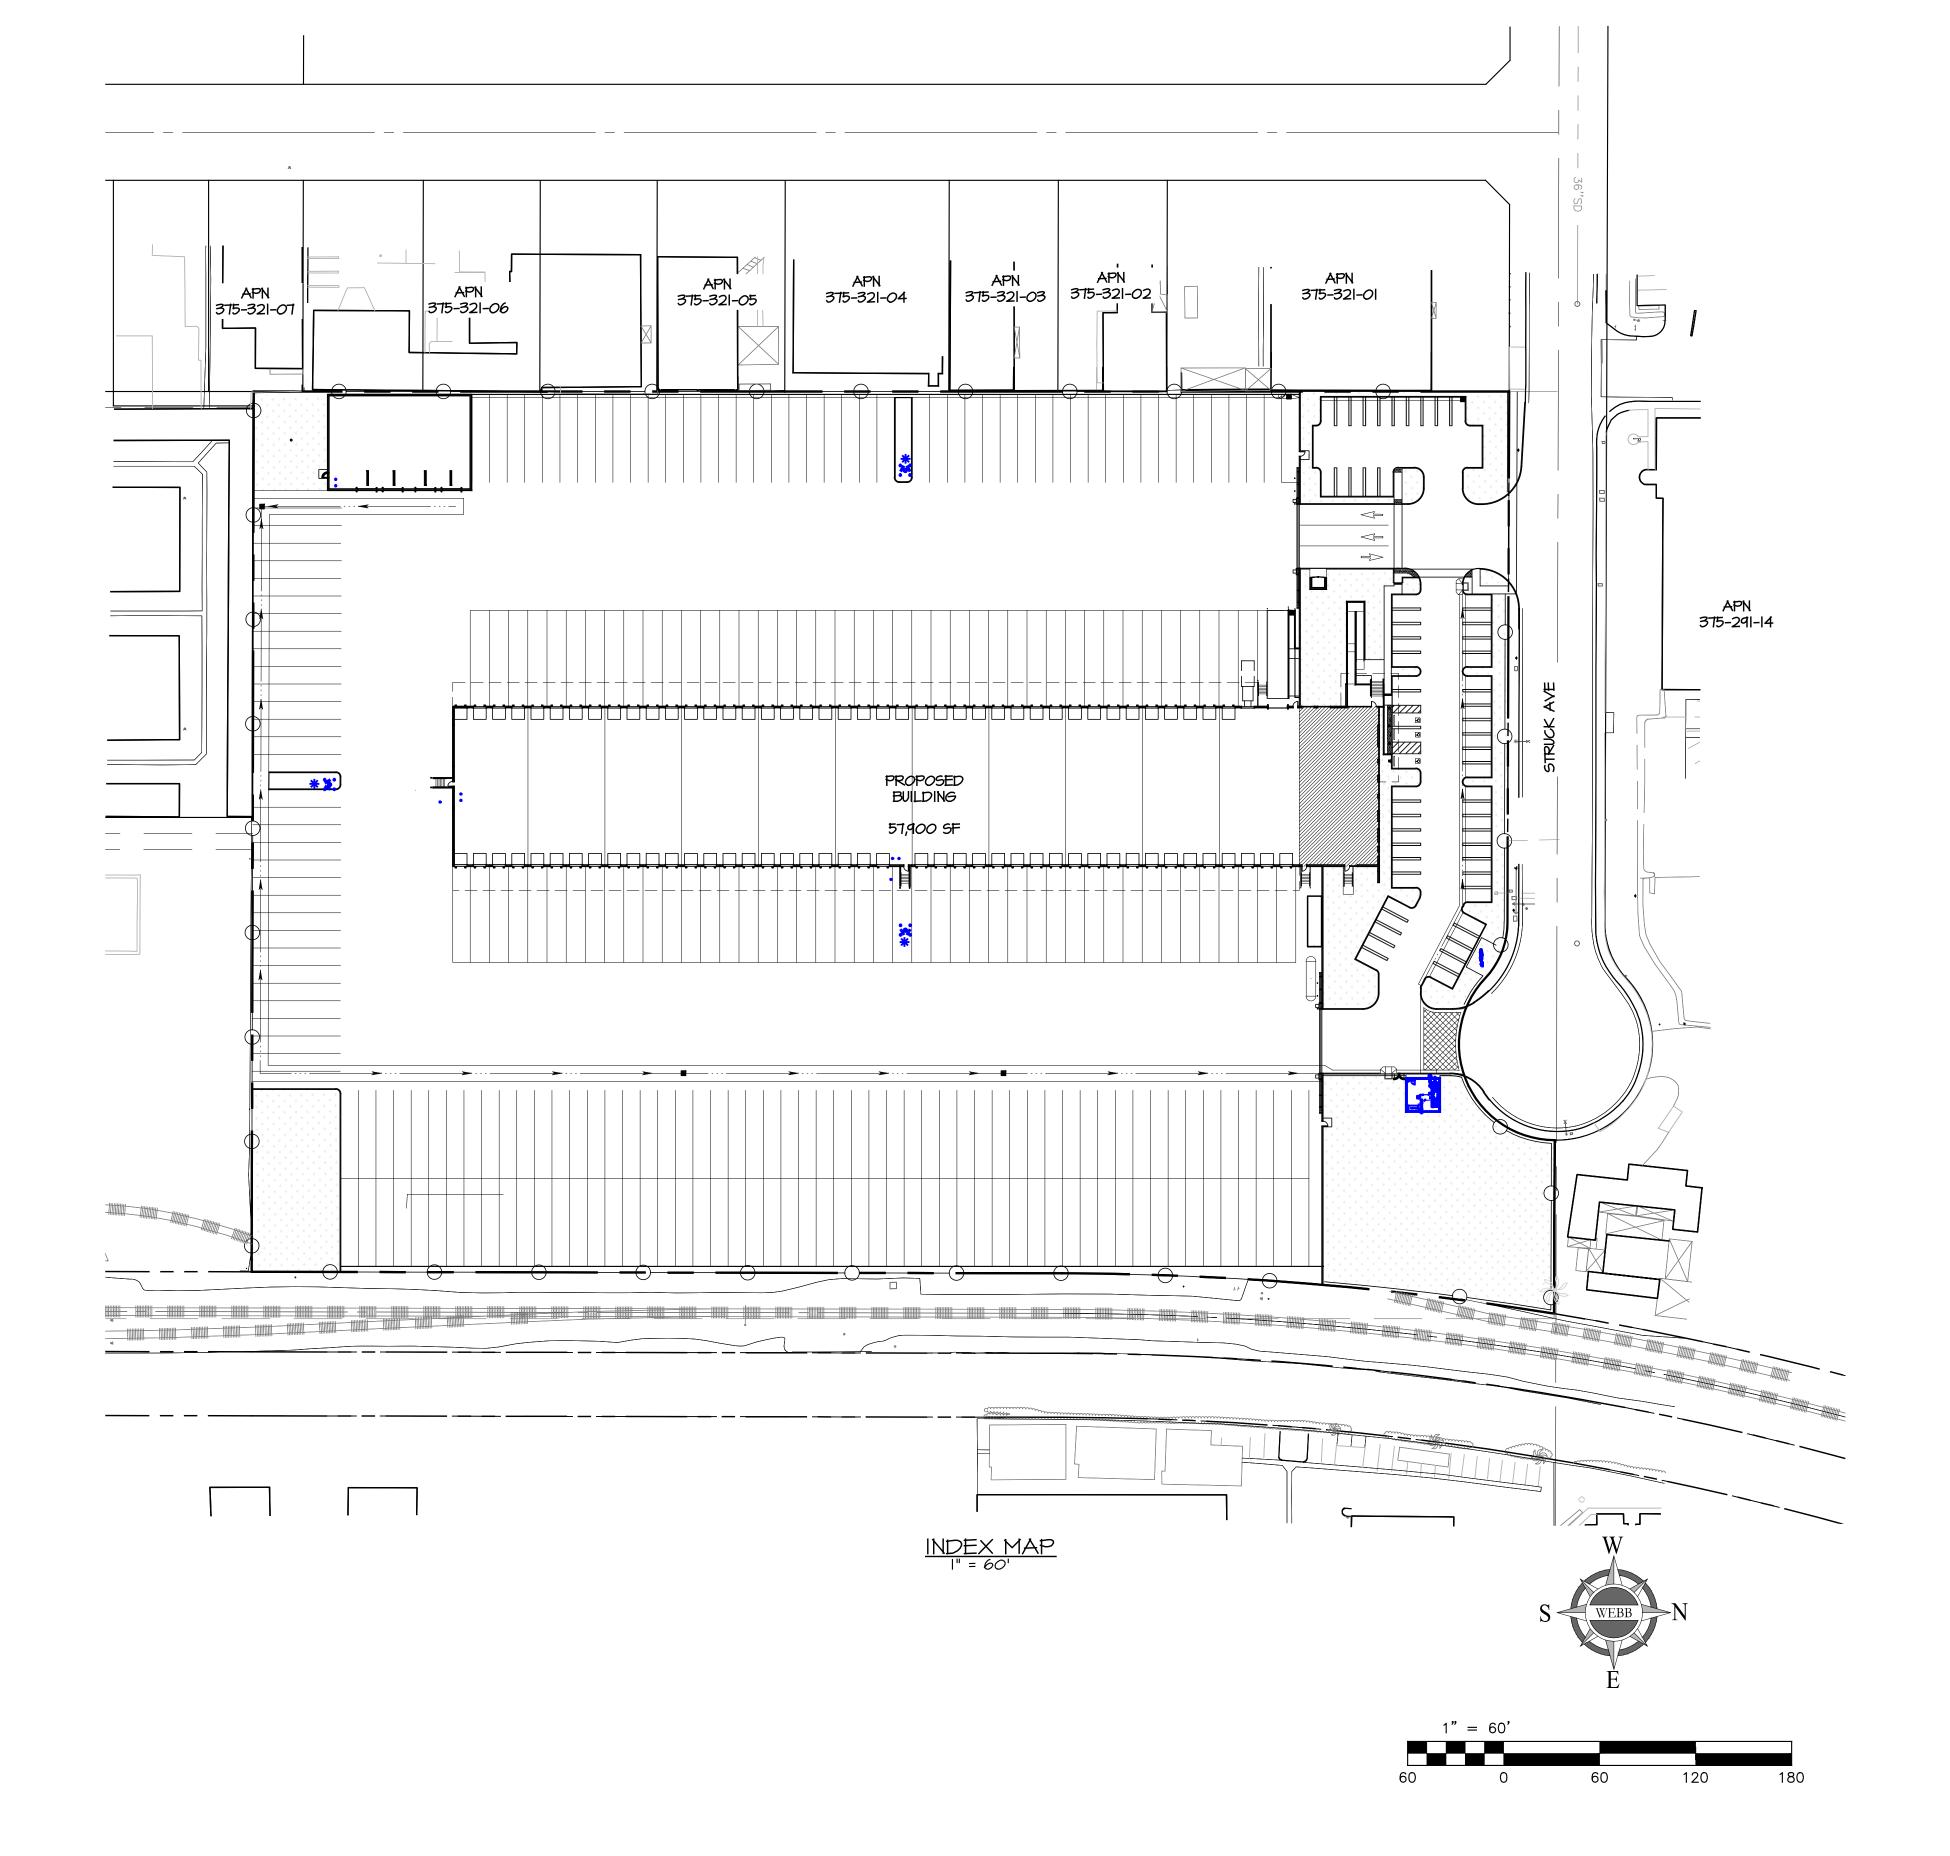

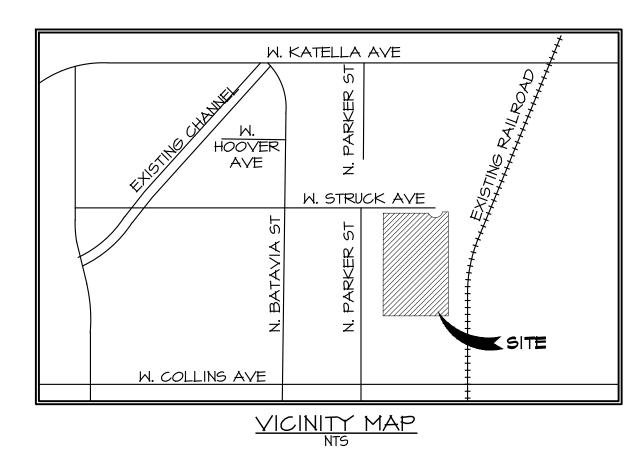

ENGINEER

3788 McCRAY STREET

RIVERSIDE, CA 92506

TEL: (951) 320-6001

FAX: (951) 788-1256

ACREAGE

ALBERT A. WEBB ASSOCIATES

CONTACT: BYANKA VELASCO

EMAIL: BYANKA. VELASCO@WEBBASSOCIATES.COM

ASSESSOR'S PARCEL NO.

LOT ACREAGE: 9.98 AC (434,883 SF)

APPLICANT/OWNER

PROLOGIS-EXCHANGE ORANGE INDUS

PROLOGIS-EXCHANGE ORANGE INDUSTRIAL CTR 6 LLC 17777 CENTER COURT DR. N, SUITE 100 CERRITOS CA, 90703 CONTACT: JOHN CARTER EMAIL: JCARTER@PROLOGIS.COM TEL: (562) 345-9327

ARCHITECT

HPA ARCHITECTURE
18831 BARDEEN AVENUE, SUITE 100
1RVINE, CA 92612
CONTACT: JAIME CRUZ

EMAIL: JAIME@HPARCHS.COM

SITE ADDRESS 543 W STRUCK AVENUE ORANGE, CA 92867

TEL: (949) 863-1770

SCOPE OF WORK

PROPOSE THE DEMOLITION OF THE EXISTING BUILDING AND IMPROVEMENTS LOCATED AT 534 WEST STRUCK AVENUE IN THE CITY OF ORANGE TO DEVELOP A 57,900± SF STANDALONE BUILDING AND SURROUNDING IMPROVEMENTS.

<u>UTILITIES</u>

WATER _____ORANGE COUNTY WATER DISTRICT
SEWER ____ORANGE COUNTY WATER DISTRICT
GAS _____SOUTHERN CALIFORNIA GAS COMPANY
ELECTRIC ____SOUTHERN CALIFORNIA EDISON
TELEPHONE ___VERIZON/SPECTRUM

LAND USE

PROPOSED ZONING:

EXISTING LAND USE: LIGHT INDUSTRIAL EXISTING ZONING: M-2 INDUSTRIAL PROPOSED LAND USE: LIGHT INDUSTRIAL

TELEVISION ____ INDIVIDUAL RECEPTION

EXISTING BUILDING

BUILDING AREA: 40,000± SF

PROPOSED BUILDING
BUILDING AREA: 57,900 SF

CONSTRUCTION TYPE: III-B

MAX. BUILDING HEIGHT: 45'

BUILDING DATA

SITE ADDRESS: 543 W STRUCK AVENUE, ORANGE, CA 92867
PROPOSED BUILDING AREA: 57,900 SF
OCCUPANCY: LOW HAZARD STORAGE/BUSINESS

SPRINKLER TYPE: NFPA 13
REQUIRED FIRE FLOW REQUIREMENTS: 2,500 GPM AT 20 PSI FOR 4 HOURS

M-2 INDUSTRIAL

WHITE LETTERS, 3" MINIMUM IN HEIGHT


PAINTED RED (2 COATS)

CONCRETE CURB

CONCRETE CURB SHALL BE PAINTED RED AND EVERY (30') THIRTY
FEET SHALL BE LABELED IN WHITE LETTERS, 3" MINIMUM IN HEIGHT,
SPELLING OUT: "FIRE LANE - NO PARKING"

PAINTED RED CURB DETAIL


	CALE: N/ ATE: 4/16/202 ESIGNED: R HECKED: BJ	H WEDD	RIVERSIDE CA. 92506 PH. (951) 686-1070	LAND USE PROJECT APPLICATION TITLE SHEET	W.O. 2020-0017 SHEET — OF IØ SHEETS
	LN CK REF:	PLOT DATE:	2-Eah-21	534 W STRUCK AVENUE	DWG. NO.

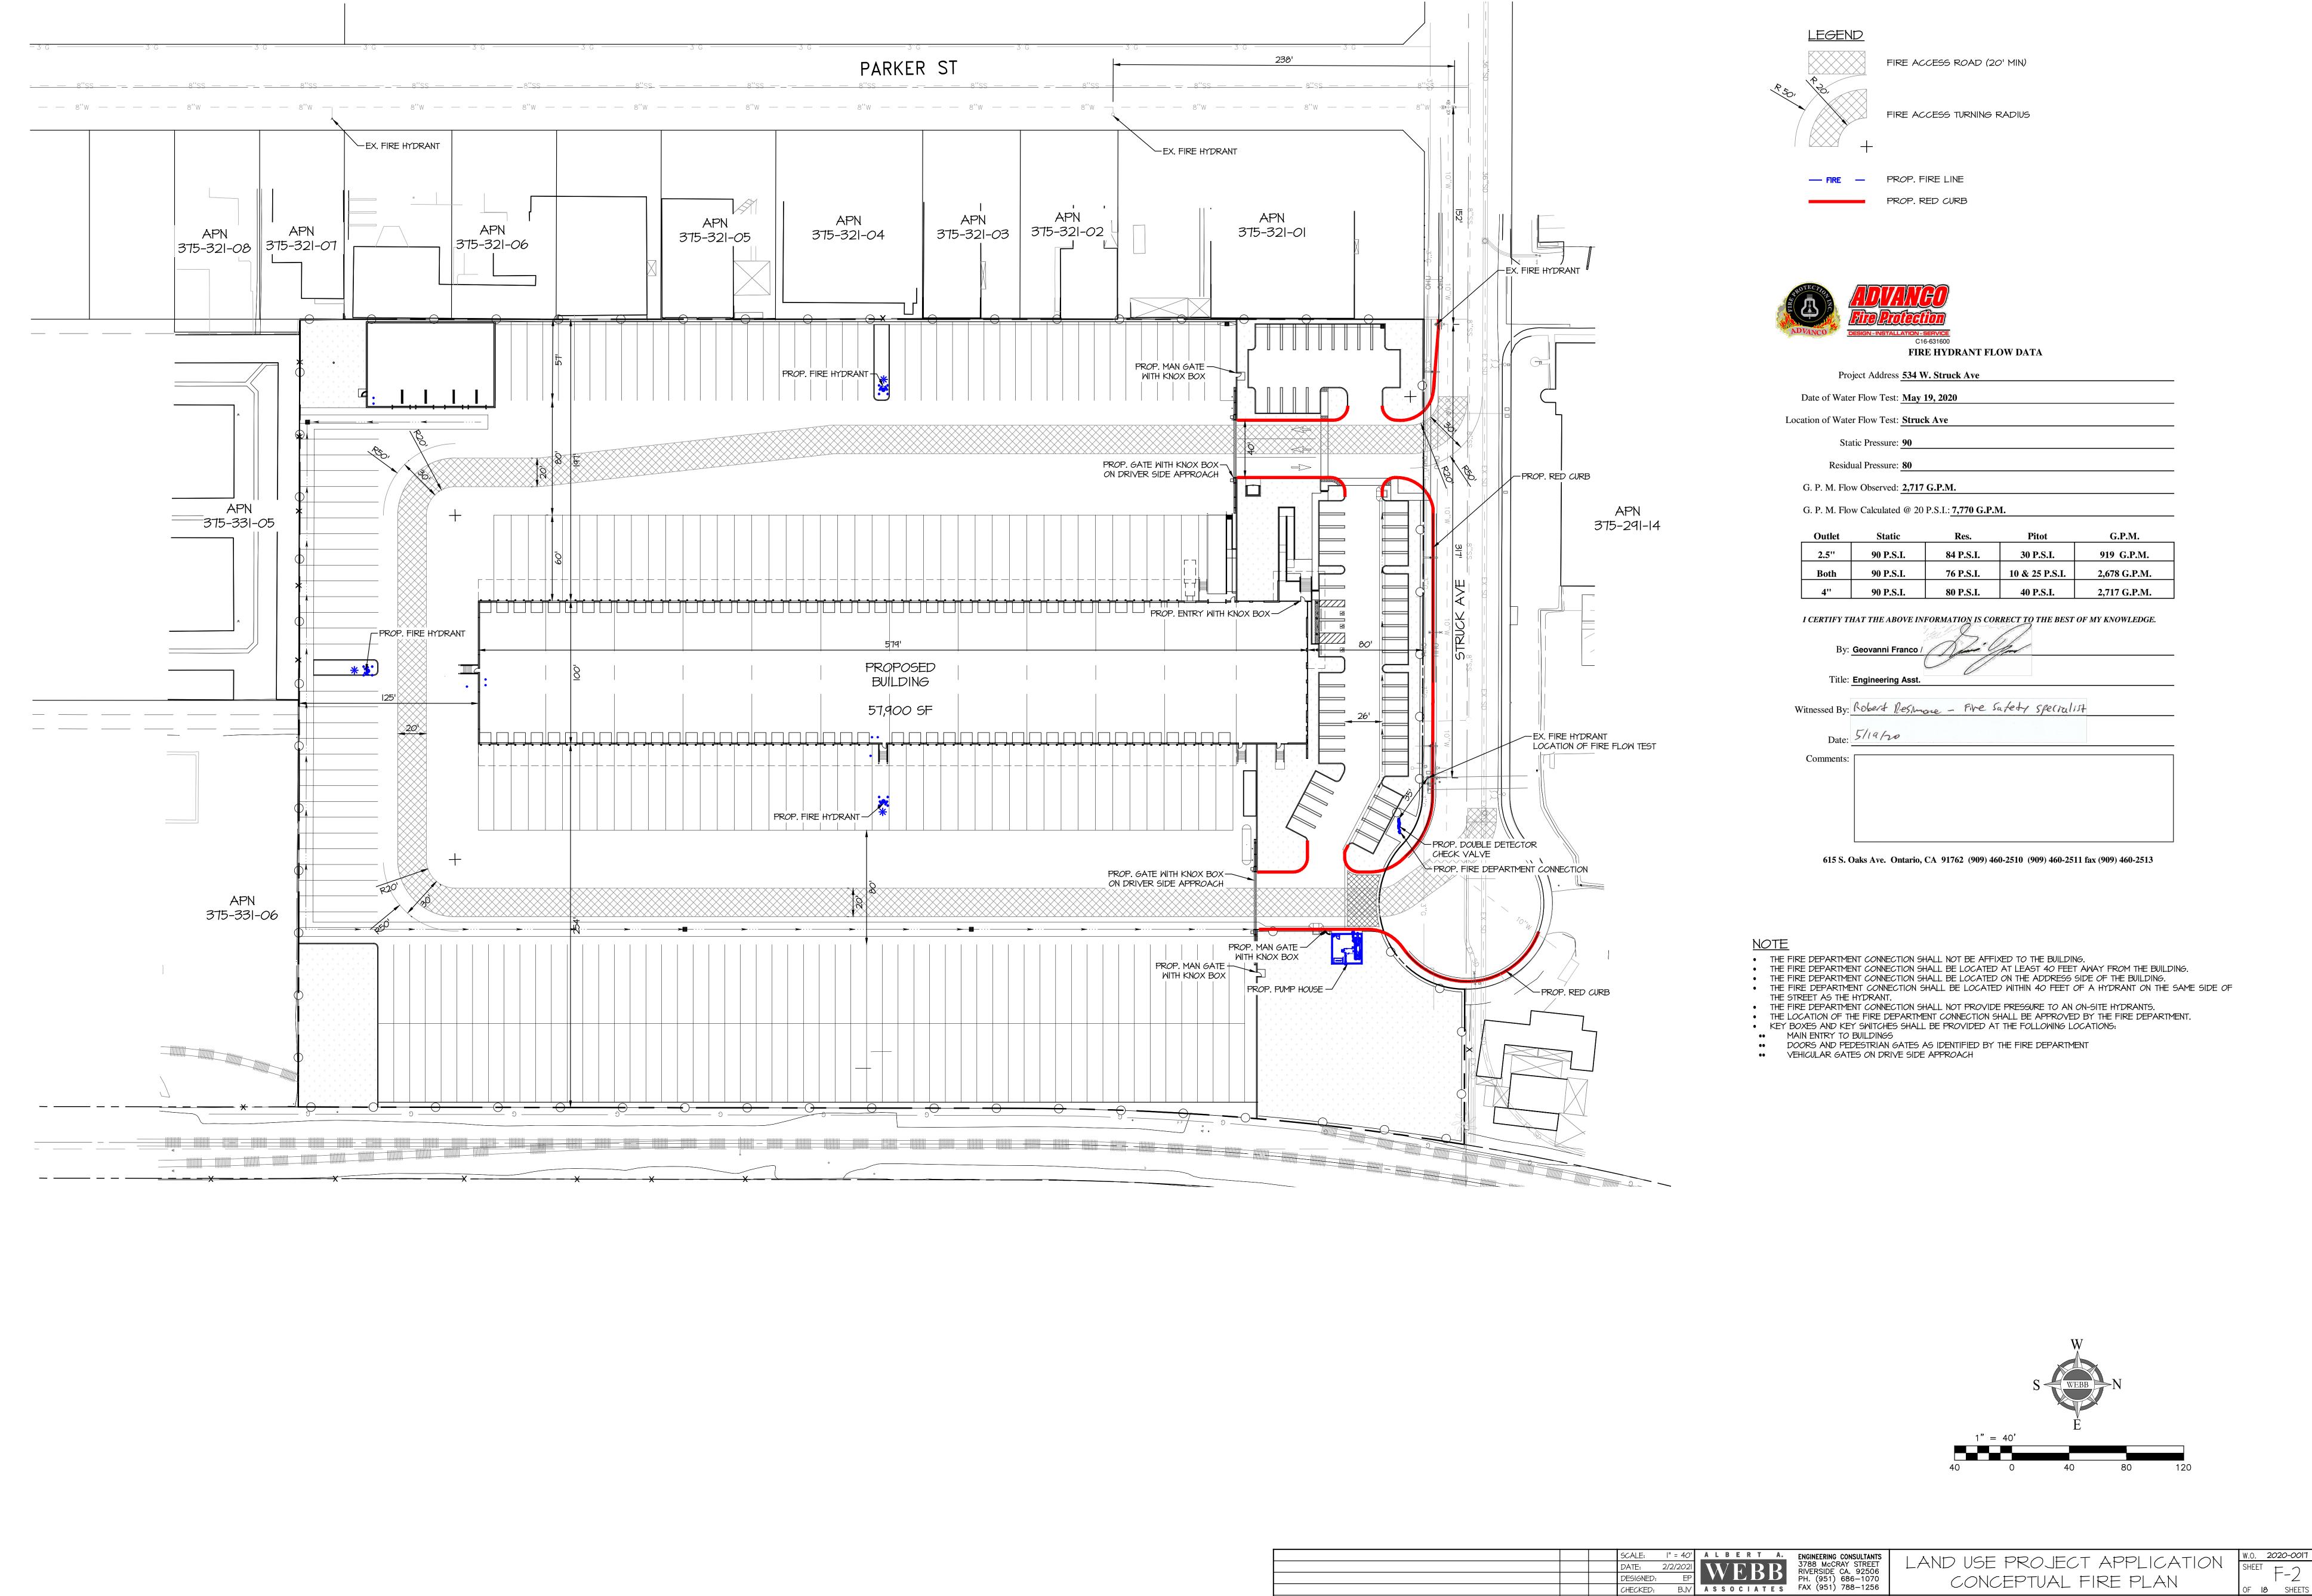

CONCEPTUAL FIRE PLAN OF 18 SHEETS DWG. NO. 534 W. STRUCK AVENUE

PLOT DATE: 2-Feb-21

REVISIONS

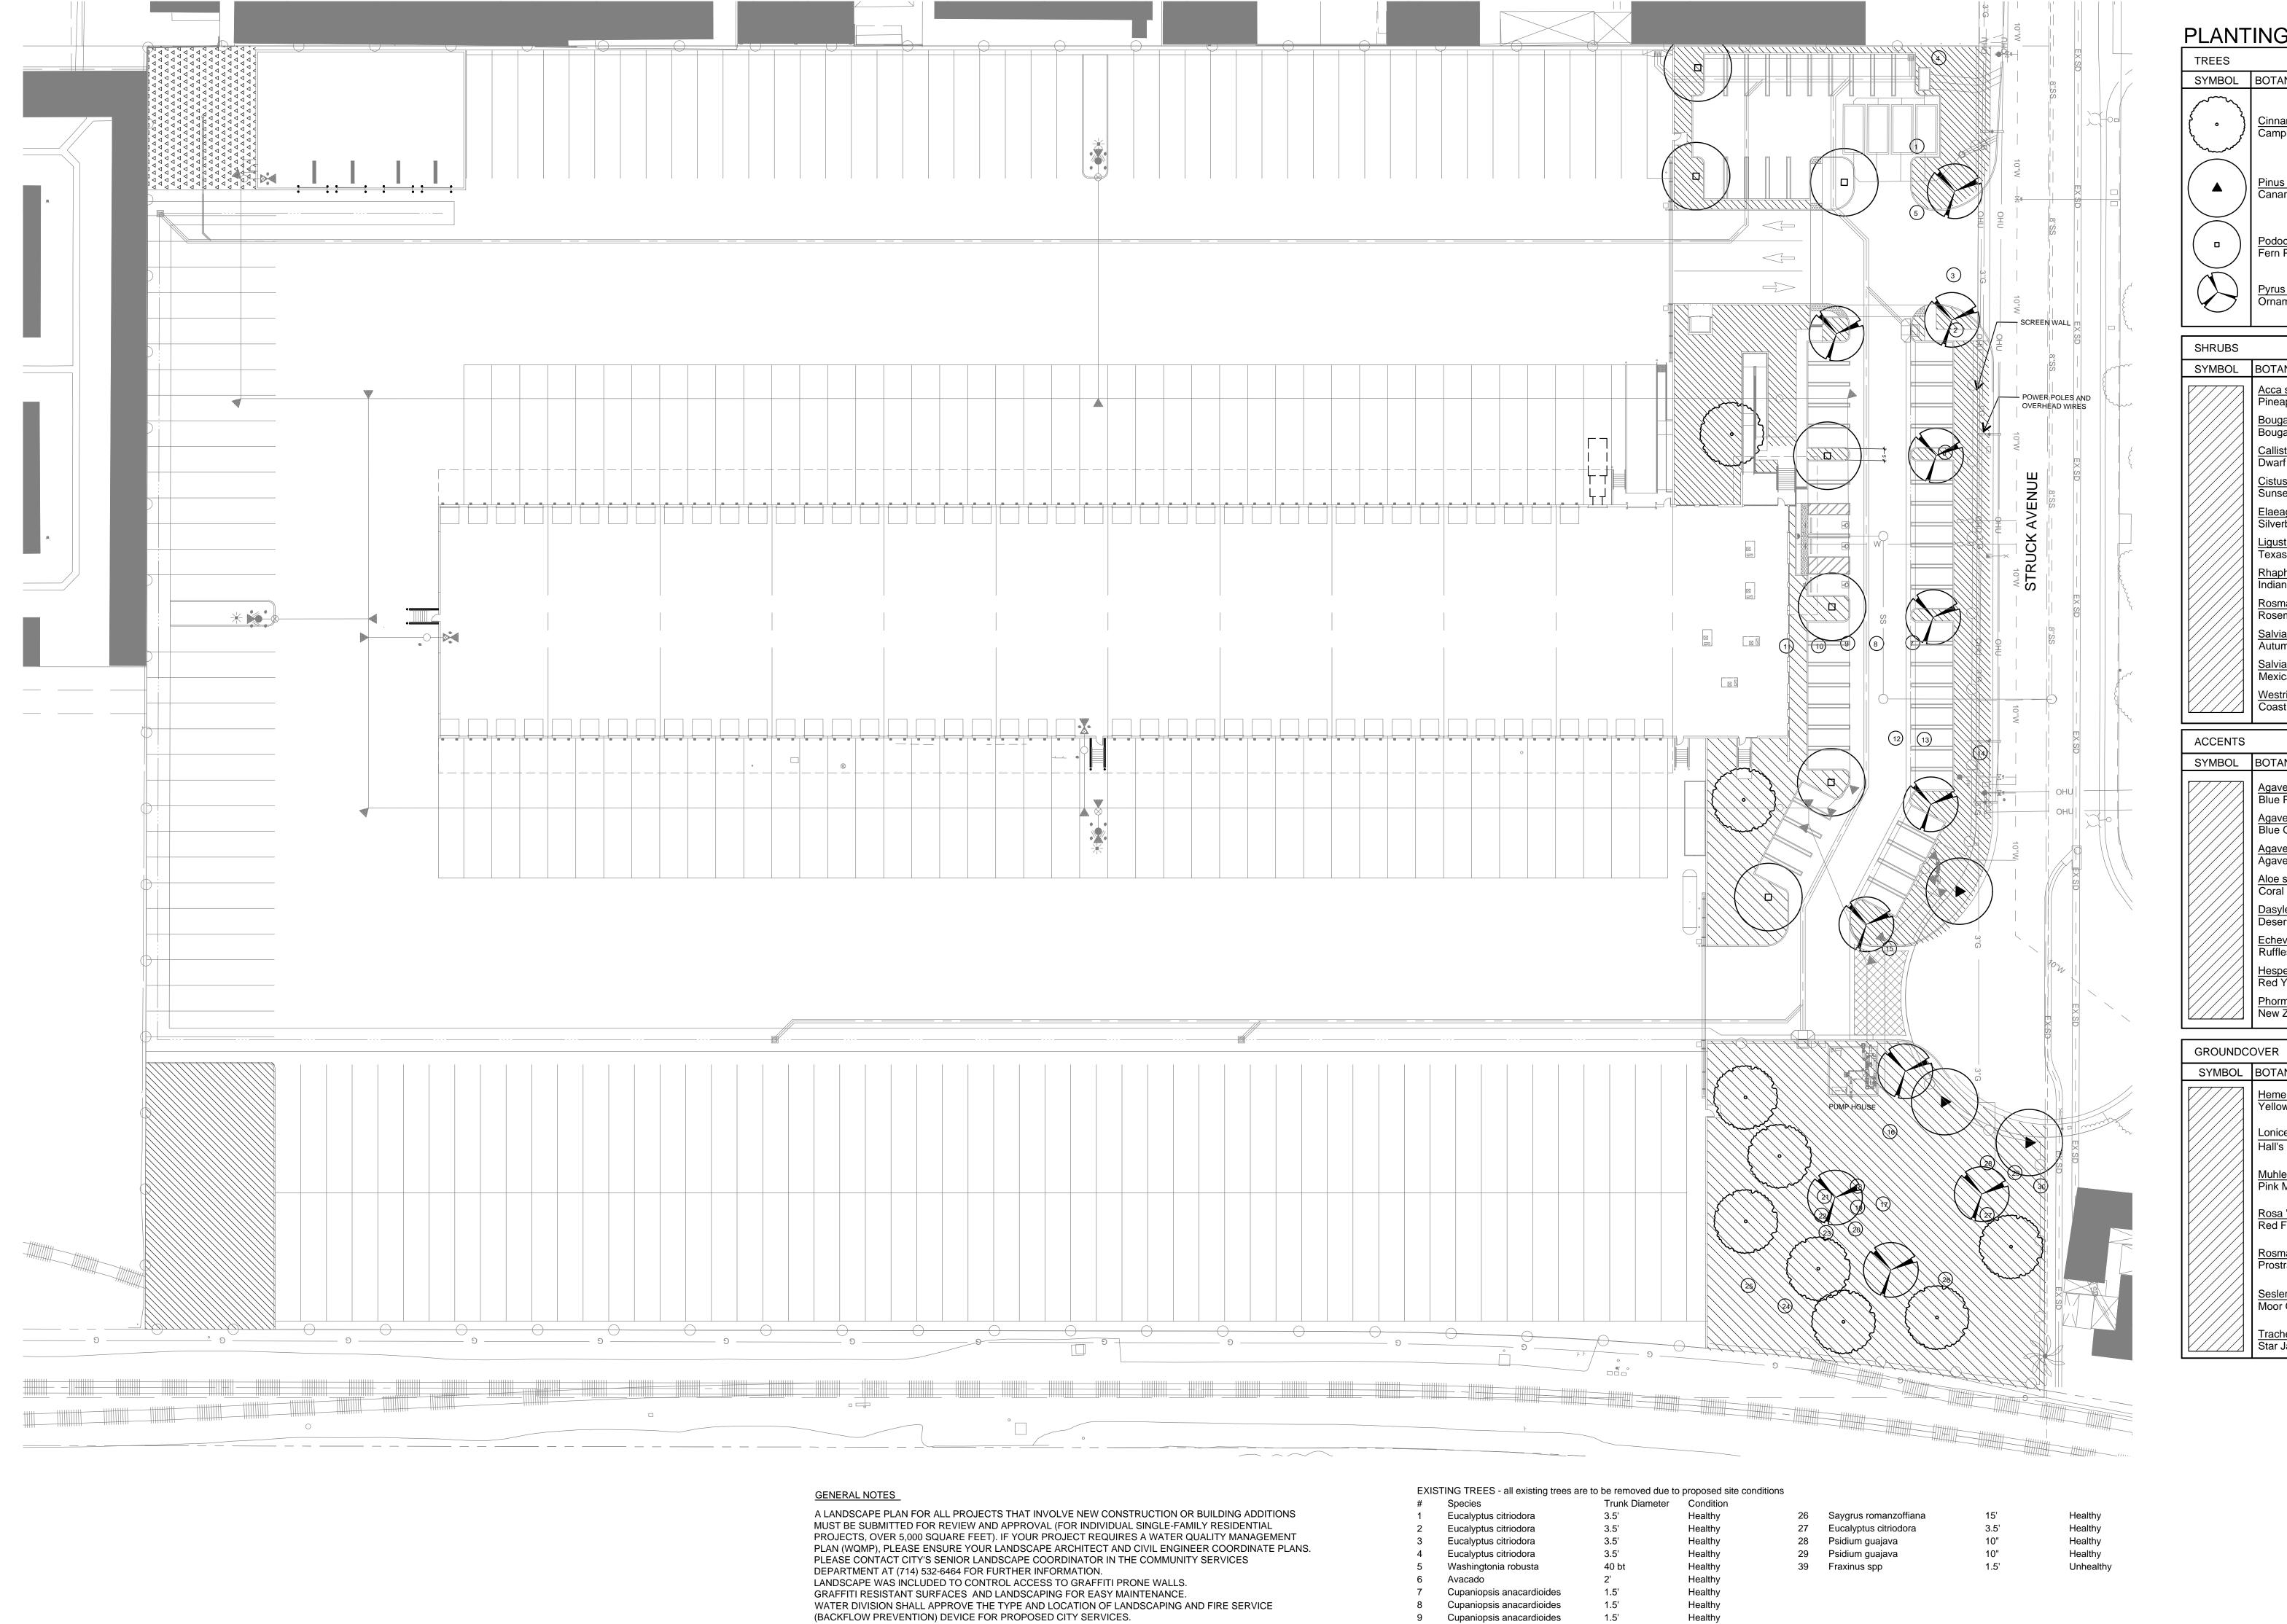

	PLANTING LEGEND
_	

TREES					
SYMBOL	BOTANICAL/COMMON NAME	SIZE	QTY	WUCOLS	REMARKS
	Cinnamomum camphora Camphor Tree	24" Box	9	М	Standard
A	Pinus canariensis Canary Island Pine	24" Box	3	L	Standard
	Podocarpus gracilior Fern Pine	24" Box	7	L	Standard
\bigcirc	Pyrus kawakami Ornamental Pear	36" Box 24" Box	4 7	L	Standard

SYMBOL	BOTANICAL/COMMON NAME	SIZE	WUCOLS	SPACING
	Acca sellowiana Pineapple Guava	5 Gal	L	3' OC
	Bougainvillea spp. Bougainvillea	5 Gal	L	3' OC
	Callistemon 'Little John' Dwarf Bottle Brush	5 Gal	L	3' OC
	Cistus 'Sunset Pink' Sunset Pink Rockrose	5 Gal	L	3' OC
	Elaeagnus pungens Silverberry	5 Gal	L	4' OC
	Ligustrum j. Texanum Texas Privet	5 Gal	М	3' OC
	Rhaphiolepis i. 'Springtime' Indian Hawthorn	5 Gal	L	3' OC
	Rosmarinus o. 'Tuscan Blue' Rosemary	5 Gal	L	3' OC
	Salvia greggii Autumn Sage	5 Gal	L	3' OC
	Salvia leucantha Mexican Sage	5 Gal	L	4' OC
	Westringia fruticosa Coast Rosemary	5 Gal	L	5' OC

L					
	SYMBOL	BOTANICAL/COMMON NAME	SIZE	WUCOLS	SPACING
		Agave 'Blue Flame' Blue Flame Agave	5 Gal	L	3' OC
		Agave 'Blue Glow Blue Glow Agave	5 Gal	L	3' OC
		Agave victoria-reginae Agave	5 Gal	L	3' OC
		Aloe striata Coral Aloe	1 Gal	L	2' OC
		Dasylerion wheeleri Desert Spoon	5 Gal	L	4' OC
		Echeveria 'Ruffles' Ruffles Echeveria	5 Gal	L	1' OC
		Hesperaloe parviflora Red Yucca	5 Gal	L	3' OC
		Phormium 'Bronze Baby' New Zealand Flax	5 Gal	L	3' OC

SYMBOL	BOTANICAL/COMMON NAME	SIZE	SPACING	WUCOLS
	Hemerocallis hybridus-Yellow Yellow Day Lily	1 Gal	24" O.C.	М
	Lonicera j. 'Halliana' Hall's Honeysuckle	1 Gal	48" O.C.	L
	Muhlenbergia capillaris Pink Muhly	1 Gal	36" O.C.	L
	Rosa 'Flower Carpet' -Red Red Flower Carpet Rose	1 Gal	30" O.C.	L
	Rosmarinus o. 'Huntington Carpet' Prostrate Rosemary	1 Gal	48" O.C.	L
	Sesleria autumnalis Moor Grass	1 Gal	18" O.C.	М
	Trachelopspermum jasminiodes Star Jasmine	1 Gal	24" O.C.	М

PRIOR TO CITY APPROVAL OF LANDSCAPE PLANS, THE APPLICANT SHALL REVIEW THE APPROVED WATER QUALITY MANAGEMENT PLAN AND ENSURE THE PROPOSED LANDSCAPE PLANS ARE CONSISTENT WITH

THE PROJECT GRADING PLANS. THE PLANS MUST SHOW ANY PROPOSED STORM WATER TREATMENT BEST MANAGEMENT PRACTICES SUCH AS BIORETENTION PLANTERS, DRYWELLS, PERMEABLE PAVERS,

ALL ABOVE GROUND EQUIPMENT IS TO BE SUFFICIENTLY SCREENED BY PLANT MATERIAL. ALL PARKING VISIBLE TO PUBLIC SHALL BE SCREENED WITH 3' HIGH 5 GALLON SHRUBS AT 3' OC.

OR ANY OTHER PROPOSED SURFACE WATER QUALITY BMPS.

XIS	TING TREES - all existing trees ar	re to be removed due to	proposed site conditio	ns		
<u>!</u>	Species	Trunk Diameter	Condition			
	Eucalyptus citriodora	3.5'	Healthy	26	Saygrus romanzoffiana	15'
<u>.</u>	Eucalyptus citriodora	3.5'	Healthy	27	Eucalyptus citriodora	3.5'
}	Eucalyptus citriodora	3.5'	Healthy	28	Psidium guajava	10"
1	Eucalyptus citriodora	3.5'	Healthy	29	Psidium guajava	10"
,	Washingtonia robusta	40 bt	Healthy	39	Fraxinus spp	1.5'
;	Avacado	2'	Healthy			
•	Cupaniopsis anacardioides	1.5'	Healthy			
}	Cupaniopsis anacardioides	1.5'	Healthy			
)	Cupaniopsis anacardioides	1.5'	Healthy			
0	Cupaniopsis anacardioides	1.5'	Healthy			
1	Cupaniopsis anacardioides	1.5'	Healthy			
2	Cupaniopsis anacardioides	1.5'	Healthy			
3	Cupaniopsis anacardioides	1.5'	Healthy			
4	Eriobotrya japonica	1.5'	Healthy			
5	Olea europaea	2.5'	Unhealthy			
6	Fraxinus spp	1.5'	Healthy			

Healthy


Healthy

17 Fraxinus spp

18-23 Archontophoenix cunninghamiana 15'

25 Archontophoenix cunninghamiana 15'

24 Cupaniopsis anacardioides

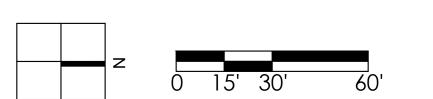


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Prologis

City of Orange, California



HUNTER LANDSCAPE 711 FEE ANA STREET PLACENTIA, CA 92870 FAX 714.986.2408

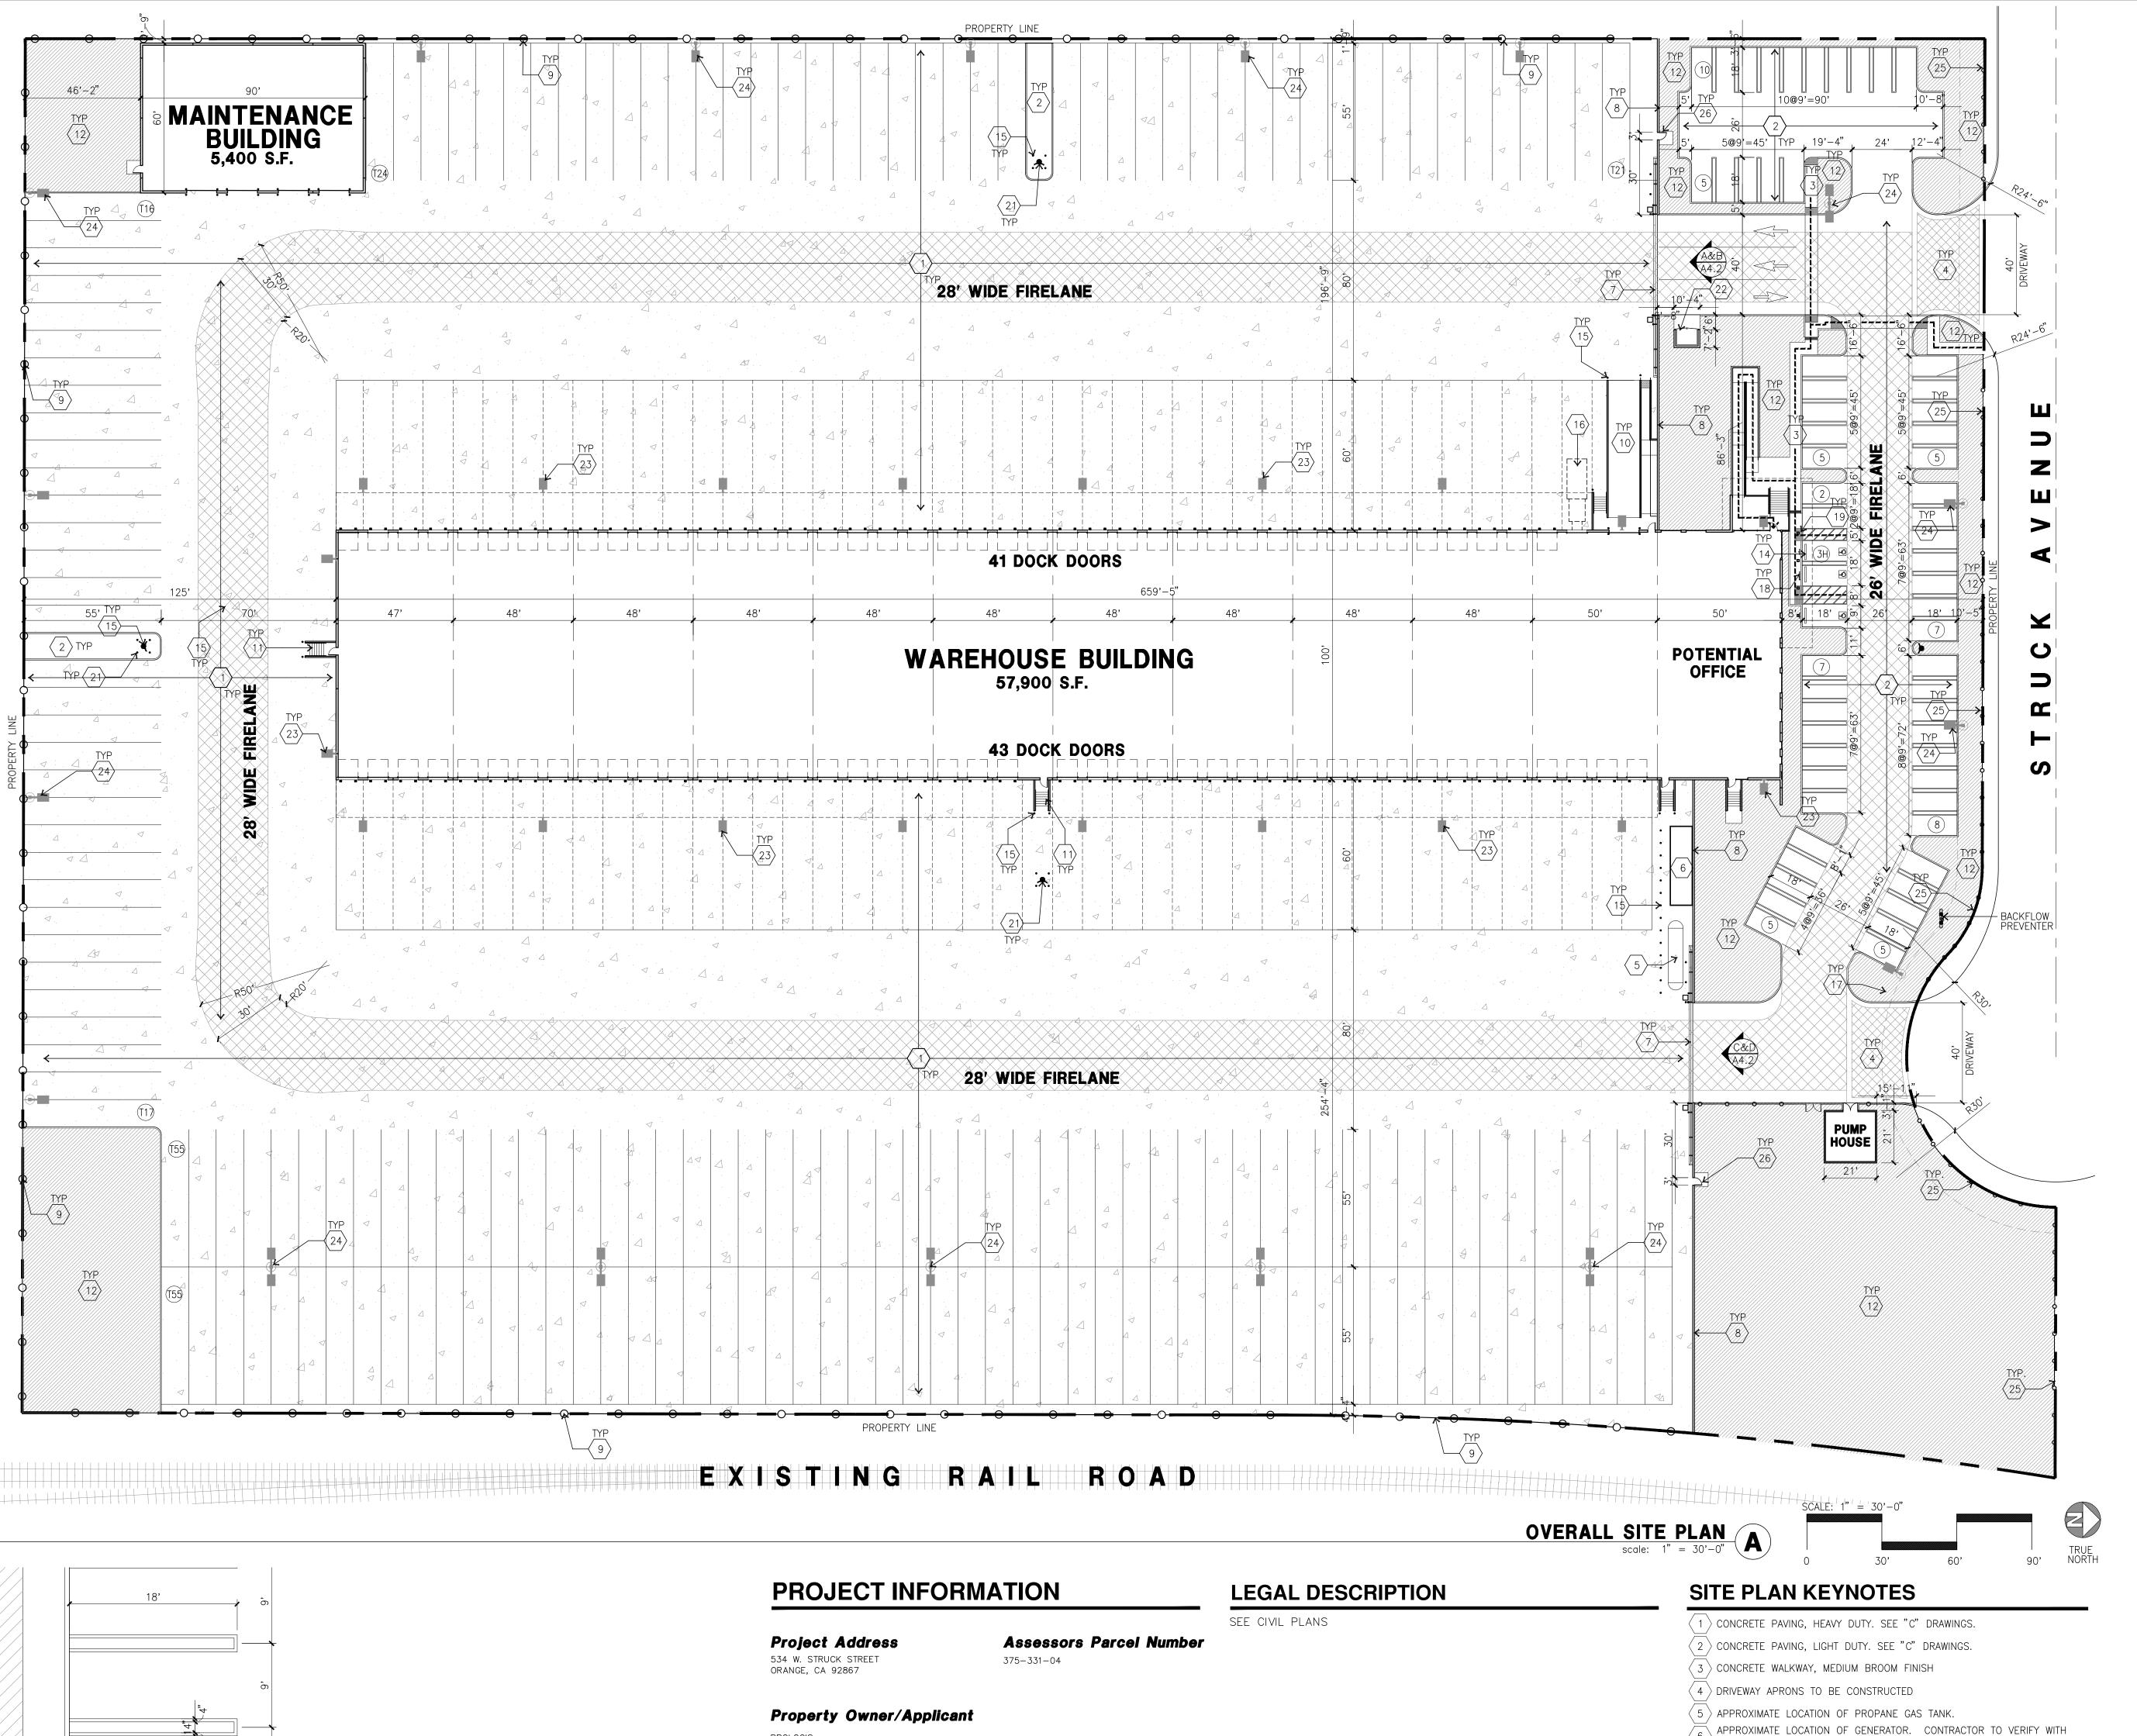

AUTO PARKING STRIPING, TYP. scale: 1/8" = 1'-0" B

PROLOGIS 17777 CENTER COURT DR N, STE 100 CERRITOS, CA 90703 PHONE: 562.345.9237 CONTACT: JOHN CARTER

Applicant's Representatives

HPA, INC. 18831 BARDEEN AVE. - STE #100 IRVINE, CA 92612 CONTACT: JAIME CRUZ PHONE: (949)-862-2110

Zoning

M-2

BUILDING USAGE


MAINTENANCE BUILDING USAGE CONSISTS OF SERVICING OF TENANT

- \ PROVIDE 8' HIGH METAL GATES W/ KNOX-BOX PER FIRE DEPARTMENT / STANDARDS PER DRIVEWAY.
- \langle 8 \rangle 8' HIGH CONCRETE TILT-UP SCREEN WALL.
- $\left\langle 9\right\rangle 8$ ' HIGH TUBE METAL FENCE.
- \langle 10angle CONCRETE RAMP W/ 42" HIGH CONCRETE WALL. 11 EXTERIOR CONCRETE STAIR.
- (12) LANDSCAPE. ALL LANDSCAPE AREAS INDICATED BY SHADING.
- 13 SMOKING AREA.
- $\langle 14 \rangle$ PRE-CAST CONCRETE WHEEL STOP.
- (15) CONCRETE FILLED GUARD POST "6 DIA. U.N.O. 42" H,
- $\langle 16 \rangle$ TRASH COMPACTOR.
- (17) ACCESSIBLE ENTRY SIGN.
- (18) ACCESSIBLE PARKING STALL SIGN.
- $\langle 19 \rangle$ TRUNCATED DOME.
- $\langle 20 \rangle$ MWS BOX. SEE "C" DWGS.
- $\langle 21 \rangle$ FIRE HYDRANT.
- TRASH ENCLOSURE, 6' HIGH CONCRETE WALLS WITH SELF-LATCHING $\frac{22}{}$ OPAQUE METAL GATES, PER CITY REQUIREMENTS.

 $\langle 26 \rangle$ 7' HIGH TUBE METAL MAN GATE WITH PANIC HARDWARE.

- (23) WALL MOUNTED LIGHT FIXTURE.
- (24) EXTERIOR PARKING LIGHT POLE.
- $\langle 25 \rangle$ 8' HIGH TUBE STEEL FENCE PER CITY REQUIREMENTS.

AERIAL MAP

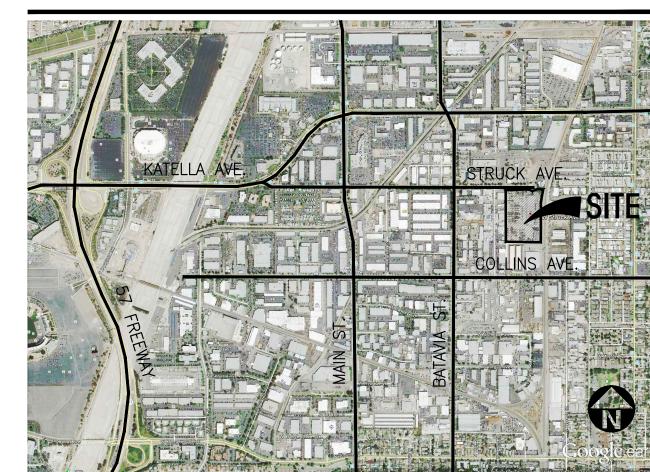

TABULATION

SITE AREA	
In s.f.	432,780 s.f.
In acres	9.94 ac
BUILDING AREA	
Office	5,000 s.f.
Warehouse	52,900 s.f.
TOTAL	57,900 s.f.
Maintenance Buidling	5,400 s.f.
TOTAL	63,300 s.f.
COVERAGE	14.6%
AUTO PARKING REQUIRED	
Office: 1/250 s.f.	20 stalls
Whse: 1/2,000 s.f.	27 stalls
TOTAL	47 stalls
AUTO PARKING PROVIDED	
Standard (9' x 18')	59 stalls
Accessible (9' x 18')	2 stalls
Accessible (12' x 18')	1 stalls
TOTAL	62 stalls
TRAILER PARKING PROVIDED	
Trailer (10' x 55')	188 stalls
ZONING ORDINANCE FOR CITY	
Zoning Designation - Indust	trial (M-2)
MAXIMUM BUILDING HEIGHT A	LLOWED
Height - 45'	
MAXIMUM FLOOR AREA RATIO	2
FAR75	
<u>SETBACKS</u>	
Struct Ave 10'	
Interior side & Rear - 0'	

SITE PLAN GENERAL NOTES

1. THE SITE PLAN BASED ON THE SOILS REPORT PREPARED BY: GEOTEK, INC.

2. IF SOILS ARE EXPANSIVE IN NATURE, USE STEEL REINFORCING FOR ALL SITE

3. ALL DIMENSIONS ARE TO THE FACE OF CONCRETE WALL, FACE OF CONCRETE CURB OR GRID LINE U.N.O.

4. SEE "C" PLANS FOR ALL CONCRETE CURBS, GUTTERS AND SWALES. 5. THE ENTIRE PROJECT SHALL BE PERMANENTLY MAINTAINED WITH AN

AUTOMATIC IRRIGATION SYSTEM.

6. SEE "C" DRAWINGS FOR POINT OF CONNECTIONS TO OFF-SITE UTILITIES. CONTRACTOR SHALL VERIFY ACTUAL UTILITY LOCATIONS. 7. PROVIDE POSITIVE DRAINAGE AWAY FROM BLDG. SEE "C" DRAWINGS.

8. CONTRACTOR TO REFER TO "C" DRAWINGS FOR ALL HORIZONTAL CONTROL

DIMENSIONS. SITE PLANS ARE FOR GUIDANCE AND STARTING LAYOUT POINTS. 9. SEE "C"DRAWINGS FOR FINISH GRADE ELEVATIONS.

10. CONCRETE SIDEWALKS TO BE A MINIMUM OF 4" THICK W/ TOOLED JOINTS

AT 6' O.C. EXPANSION/CONSTRUCTION JOINTS SHALL BE A MAXIMUM 12' EA. WAY. EXPANSION JOINTS TO HAVE COMPRESSIVE EXPANSION FILLER MATERIAL

OF 1/4". FINISH TO BE A MEDIUM BROOM FINISH U.N.O. 11. PAINT CURBS AND PROVIDE SIGNS TO INFORM OF FIRE LANES AS REQUIRED

BY FIRE DEPARTMENT. 12. CONSTRUCTION DOCUMENTS PERTAINING TO THE LANDSCAPE AND IRRIGATION

OF THE ENTIRE PROJECT SITE SHALL BE SUBMITTED TO THE BUILDING DEPARTMENT AND APPROVED BY PUBLIC FACILITIES DEVELOPMENT PRIOR TO ISSUANCE OF BUILDING PERMITS.

13. PRIOR TO FINAL CITY INSPECTION, THE LANDSCAPE ARCHITECT SHALL SUBMIT A CERTIFICATE OF COMPLETION TO PUBLIC FACILITIES DEVELOPMENT.

14. ALL LANDSCAPE AND IRRIGATION DESIGNS SHALL MEET CURRENT CITY STANDARDS AS LISTED IN GUIDELINES OR AS OBTAINED FROM PUBLIC FACILITIES 15. ALL VERTICAL MOUNTING POLES OF CHAIN LINK FENCING SHALL BE CAPPED.

16. LANDSCAPED AREAS SHALL BE DELINEATED WITH A MINIMUM SIX INCHES (6")

SITE PLAN GENERAL NOTES

, d d	CONCRETE PAVING. SEE "C" DRWGS. FOR THICKNESS
	STANDARD PARKING STALL (9' X 18')

HANDICAP PARKING STALL (9' X 18') W/ 5' ACCESSIBLE AISLE

HANDICAP PARKING STALL (VAN)

(9' X 18') W/ 7'-6"

ACCESSIBLE AISLE LANDSCAPED AREA

28' WIDE FIRELANE


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ORANGE

STRUCK ST

534 W. STRUCK STREET

ORANGE, CA

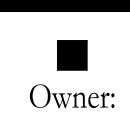

Civil:	
Structural:	
Mechanical:	
Plumbing:	
Electrical:	
Landscape:	

Fire Protection:

Soils Engineer:


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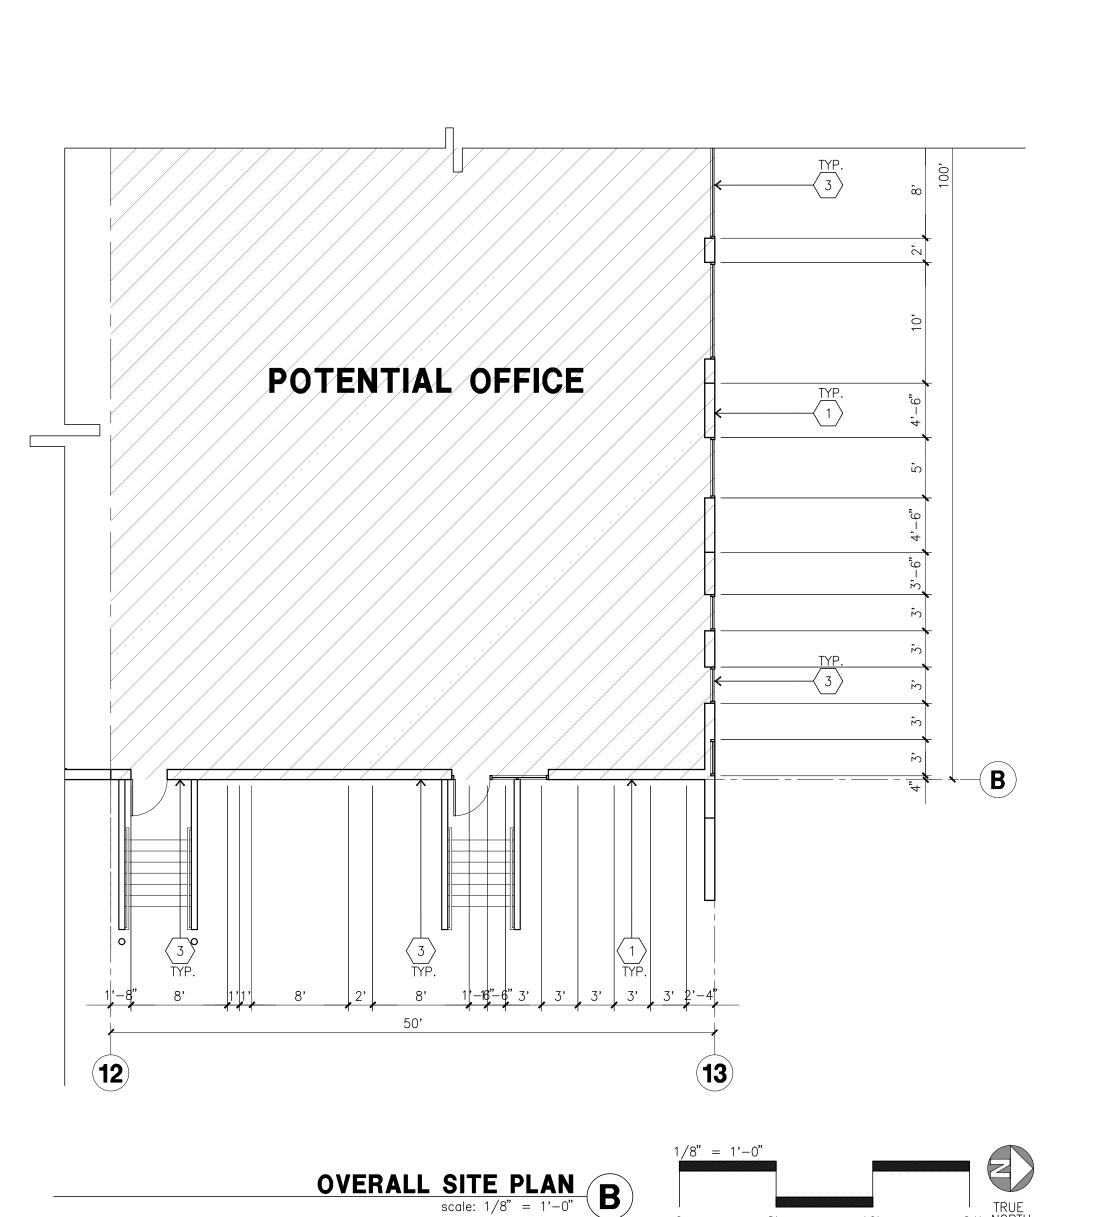
7/12/21


Project Number:

Drawn by:

Revision:



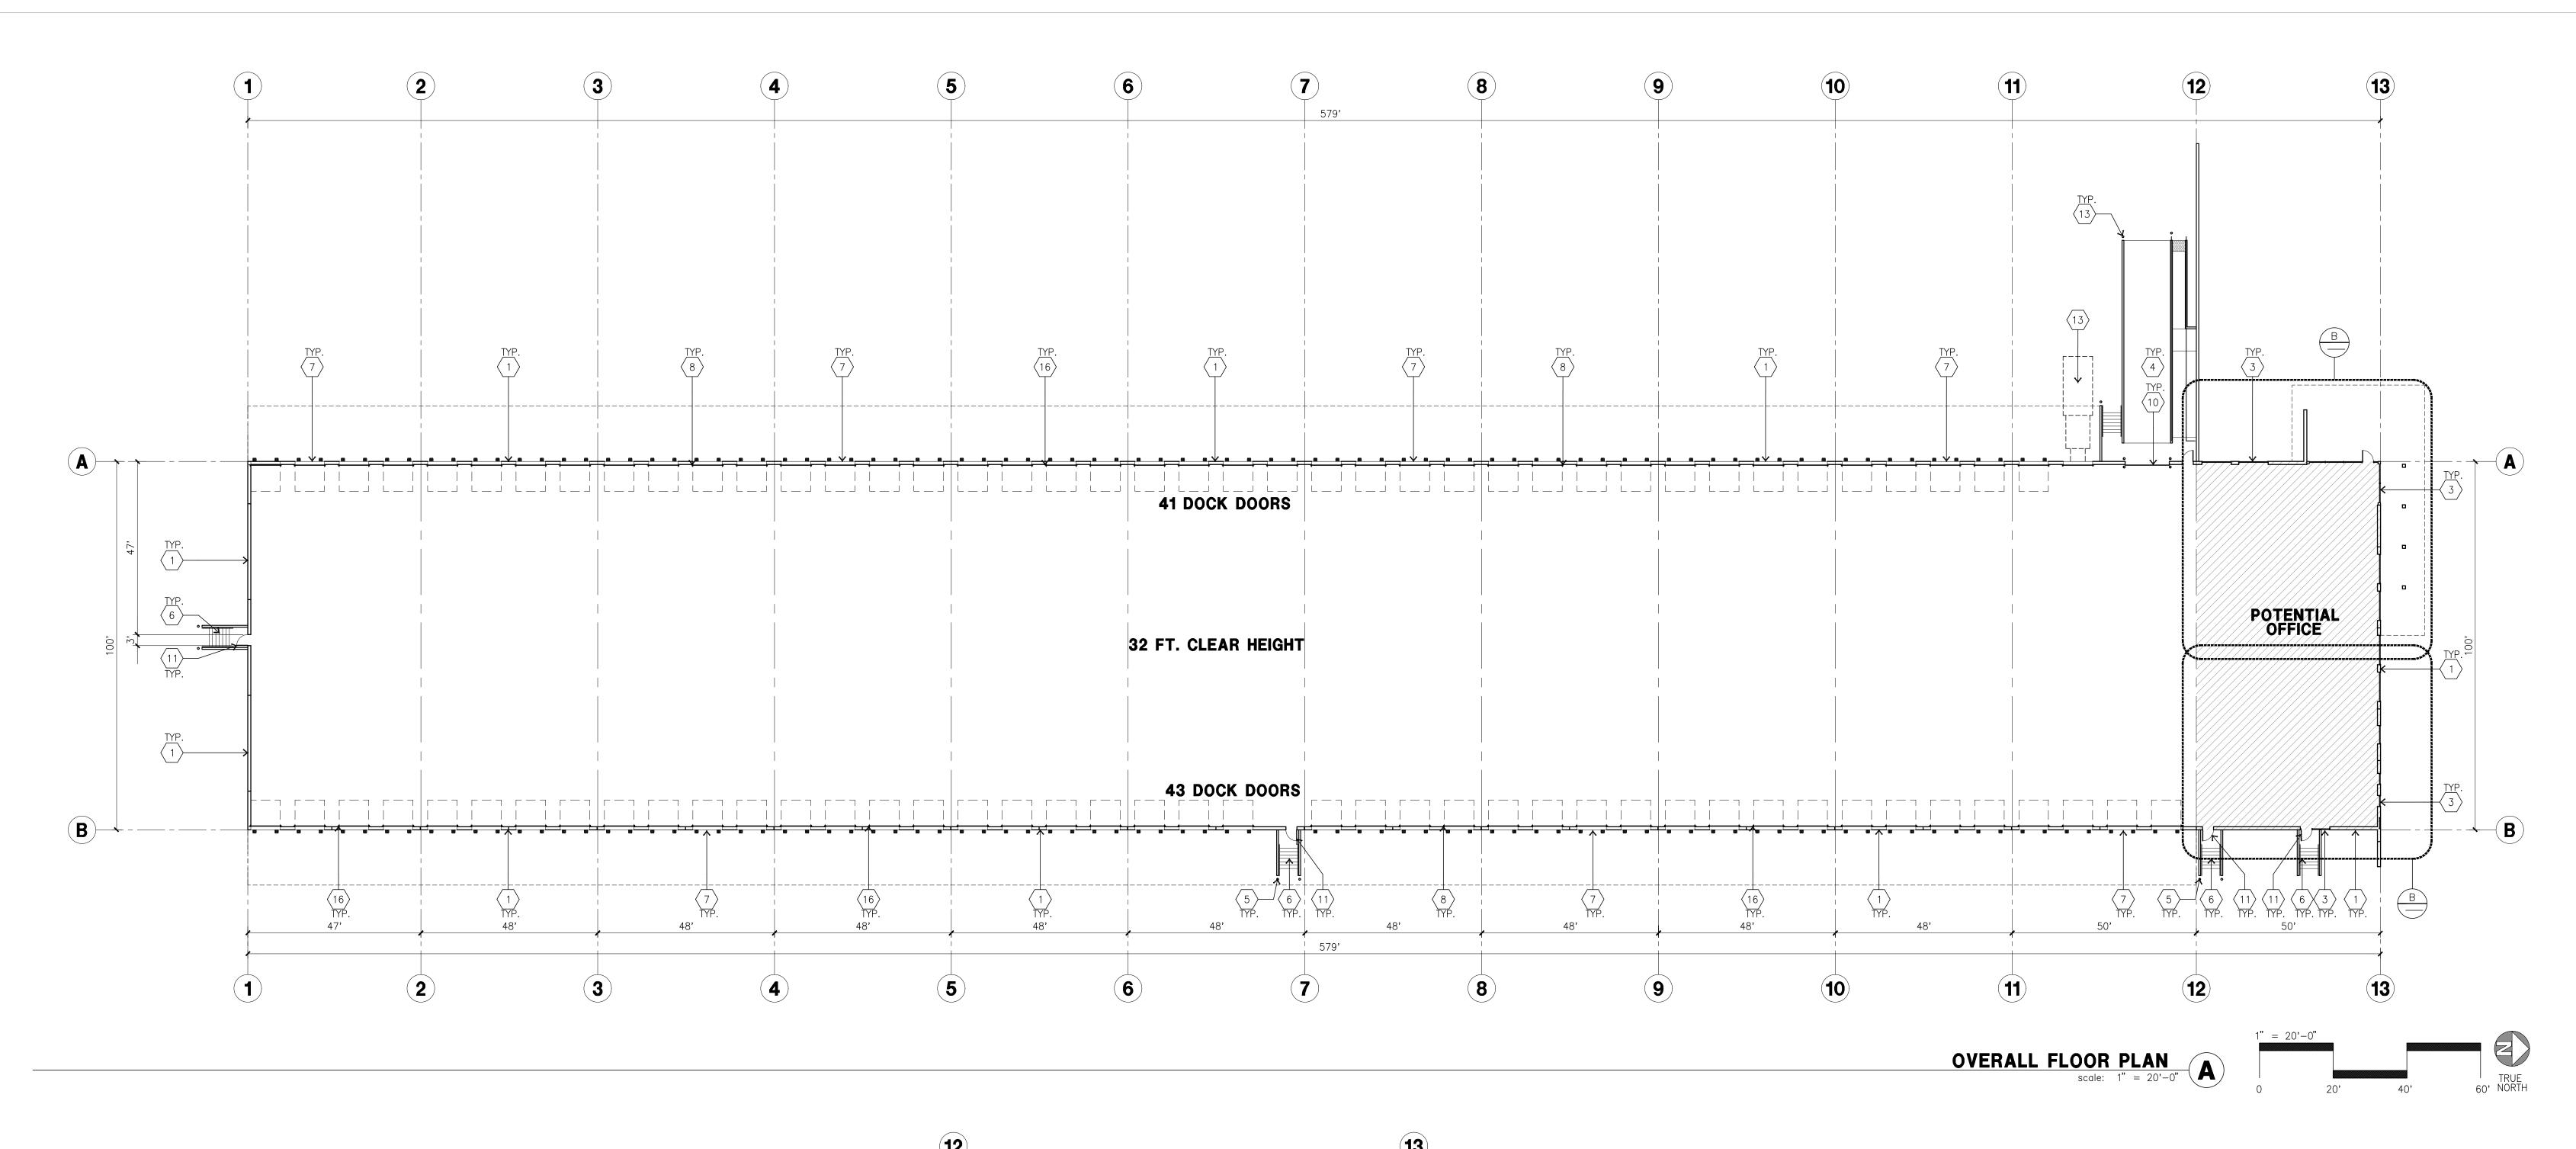

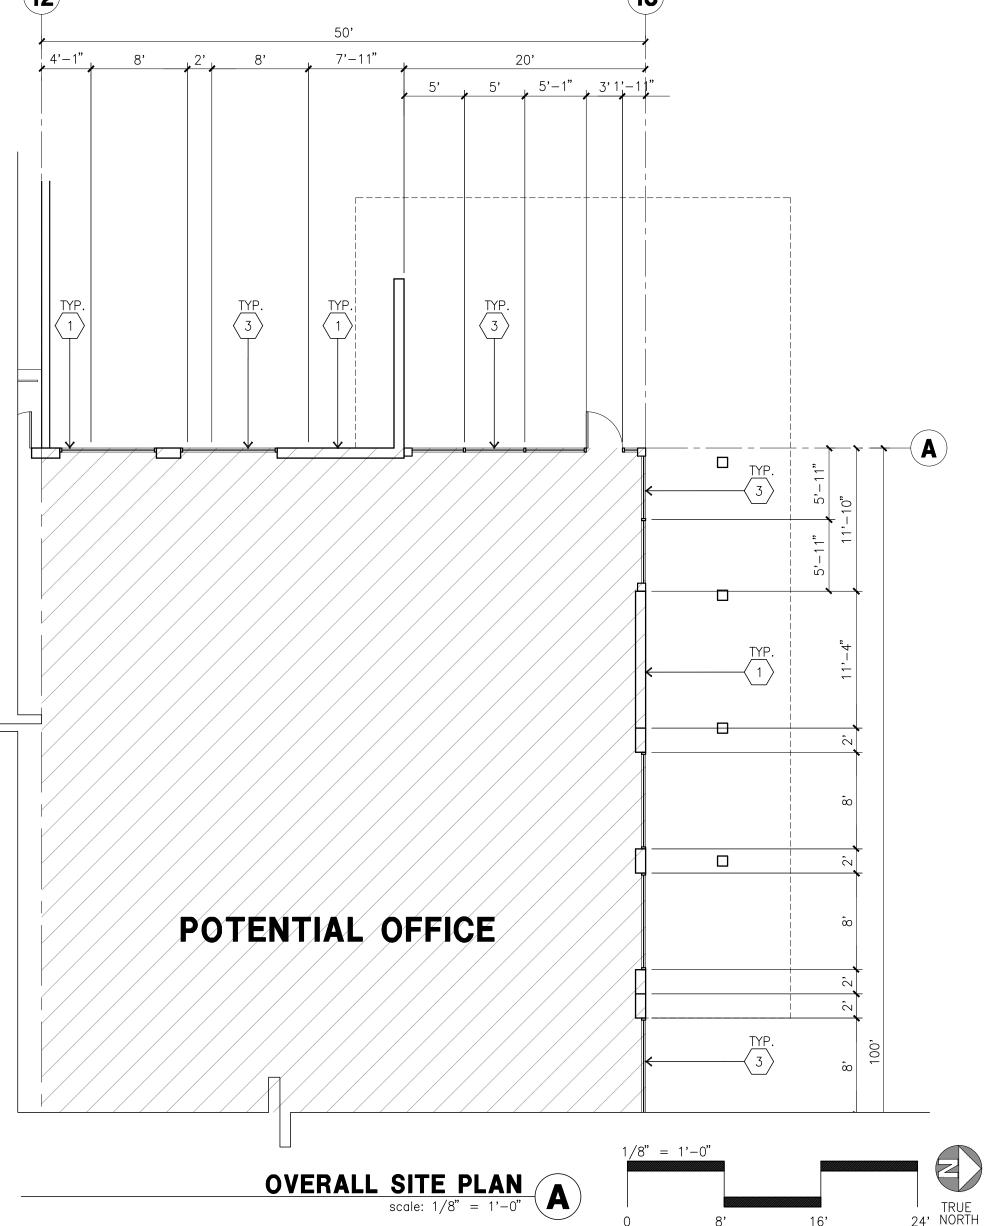

FLOOR PLAN KEYNOTES

- \langle 1 \rangle CONCRETE TILT-UP PANEL.
- 2 > STRUCTURAL STEEL COLUMN.
- \ TYPICAL STOREFRONT SYSTEM WITH GLAZING. SEE OFFICE BLOW-UP AND / ELEVATIONS FOR SIZE, COLOR AND LOCATIONS. `\ CONCRETE RAMP W/ 42"HIGH CONC TILT-UP GUARD WALL OR BUILDING
- / WALL ON BOTH SIDE OF RAMP. 5 CONC. FILLED GUARD POST. 6" DIA. U.N.O.. 42"H.
- \ EXTERIOR CONCRETE STAIR W/ 42"HIGH CONC TILT-UP GUARD WALL OR BUILDING WALL ON BOTH SIDE OF RAMP.
- \langle 7 \rangle 9' X 10' TRUCK DOOR, SECTIONAL O'H., STANDARD GRADE.
- 8 Z GUARD
- (9) DOCK DOOR BUMPER TYPICAL.
- (10) 12' X 14' DRIVE THRU. SECTIONAL O.H., STANDARD GRADE.
- $\langle 11 \rangle$ 3' X 7' HOLLOW METAL EXTERIOR MAN DOOR.
- (12) METAL CANOPY ABOVE. $\langle 13 \rangle$ TRASH COMPACTOR.

FLOOR PLAN GENERAL NOTES

- 1. THIS BUILDING IS DESIGNED FOR HIGH PILE STORAGE WITH FIRE ACCESS MAN DOORS AT 100' MAXIMUM O.C. A SEPARATE PERMIT WILL BE REQUIRED FOR ANY
- RACKING/CONVEYER SYSTEMS. 2. FIRE HOSE LOCATIONS SHALL BE APPROVED PER FIRE DEPARTMENT.
- 3. SEE "C" DRAWINGS FOR FINISH SURFACE ELEVATIONS.
- 4. WAREHOUSE INTERIOR CONCRETE WALLS ARE PAINTED WHITE. COLUMNS ARE TO RECEIVE PRIMER ONLY. ALL GYP. BD. WALLS IN WAREHOUSE TO RECEIVE 1 COAT OF WHITE TO COVER.
- 5. SLOPE POUR STRIP 1/2" TO EXTERIOR AT ALL MANDOOR EXITS. SEE "S" DRAWINGS FOR POUR STRIP LOCATION. 6. ALL DIMENSIONS ARE TO THE FACE OF CONCRETE PANEL WALL, GRIDLINE, OR
- FACE OF STUD U.N.O. 7. SEE CIVIL DRAWINGS FOR POINT OF CONNECTIONS TO OFF-SITE UTILITIES. CONTRACTOR TO VERIFY ACTUAL UTILITY LOCATIONS. PLUMBING/ELECTRICAL
- 8. FOR DOOR TYPES AND SIZES, SEE DETAIL SHEET -. NOTE: ALL DOORS PER DOOR SCHEDULE ARE FINISH OPENINGS. 9. CONTRACTOR TO PROTECT AND KEEP THE FLOOR SLAB CLEAN. ALL
- EQUIPMENT TO BE DIAPERED INCLUDING CARS AND TRUCKS. 10. ALL EXIT MAN DOORS IN WAREHOUSE TO HAVE ILLUMINATED EXIT SIGN HARDWARE.
- 11. HIGHLY FLAMMABLE AND COMBUSTIBLE MATERIAL SHALL NOT BE USED OR STORED IN THIS BUILDING. 12. EACH EXTERIOR EXIT DOOR SHALL BE IDENTIFIED BY A TACTILE EXIT SIGN WITH THE WORDS "EXIT". THE MOUNTING HEIGHT FOR SUCH SIGNAGE SHALL BE
- 60" FROM FINISH FLOOR LEVEL TO THE CENTER OF THE SIGN. 13. NON-ACCESSIBLE DOOR. PROVIDE WARNING SIGN LOCATED IN THE INTERIOR SIDE PER CBC 1133B.1.1.1

14. ALL ROOF MOUNTED MATERIALS SHALL BE FULLY SCREENED FROM PUBLIC VIEW, SEE A/A4.1 OFFICE SECTION.

THESE NOTES ARE VERY MIN. REQUIREMENT. SEE "S" DWGS FOR ADDITIONAL REQUIREMENTS

FLOOR SLAB & POUR STRIPS REQ.

- 1. FLOOR COMPACTION 95% 2. TRENCH COMPACTION - 90%
- 3. BUILDING FLOOR SLAB: A. 6" THICK MIN. UN-REINFORCED CONCRETE OVER COMPACTED SOILS B. 3/4" - 16"LONG @ 12" O.C. DOWELS AT ALL CONSTRUCTION JOINTS 3/4" - 16"LONG @ 24" O.C. DOWELS IN DOWEL BASKET AT ALL
- CONTROL JOINTS. C. 4,000 P.S.I. REQUIREMENT.
- D. SLUMP TO BE 4" +/- 1"E. JOINT SPACING PER A.C.I. 302-IR-96
- F. SAW-CUT DEPTH 1/4 T; SOFT SAW-CUTTING WITHIN 2 HRS OF 4. CONTRACTOR TO BUILD FOR CLASS V FLOOR PER A.C.I. 302-IR-96 5. CONCRETE SLAB TO HAVE STEEL FLOAT HARD TROWEL BURNISHED FINISH.
- 6. CONTRACTOR TO CURE SLAB TO BE WET CURING USING BURLINE FOR 7 DAYS 7. ALL EQUIPMENT & MOVING VEHICLES SHALL BE DIAPERED. 8. NO CRANES, CONCRETE TRUCKS, OR ANYTHING HEAVIER WILL BE PLACED ON 9. SLAB TO BE FF50 FL35 MEASURED WITHIN 24 HOURS.
- 10. NO FLY ASH IN THE CONCRETE 11. WHERE ///// INDICATED, PROVIDE VAPOR BARRIER (15MIL STEGO OR EQUAL) UNDER THE CONCRETE SLAB. PROVIDE SAND ✓ PER SOILS ENGINEER OR MANUFACTURER'S

RECOMMENDATION. CONCRETE SLAB IN FUTURE OFFICE AREAS, WHERE SAND OVER VIQUEEN ARE REQUIRED, SHALL BE NATURALLY HYDRATED WITHOUT USE OF BURLENE, CURING COMPOUND, OR RELEASE AGENTS. CONTROL/CONSTRUCTION JOINTS SHALL NOT BE FILLED WITH MM-80 JOINT FILLER IN FUTURE OFFICE AREAS. 12. SEAL CONCRETE SLAB W/ "LIPIDOLITH" SEALER



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ORANGE, CA



Consultants:

Structural: Mechanical: Plumbing: Electrical: Landscape:


Fire Protection:


Soils Engineer:

Title: OVERALL FLOOR PLAN

15175 Project Number: Drawn by: 7/12/21 Date: Revision:

Sheet:

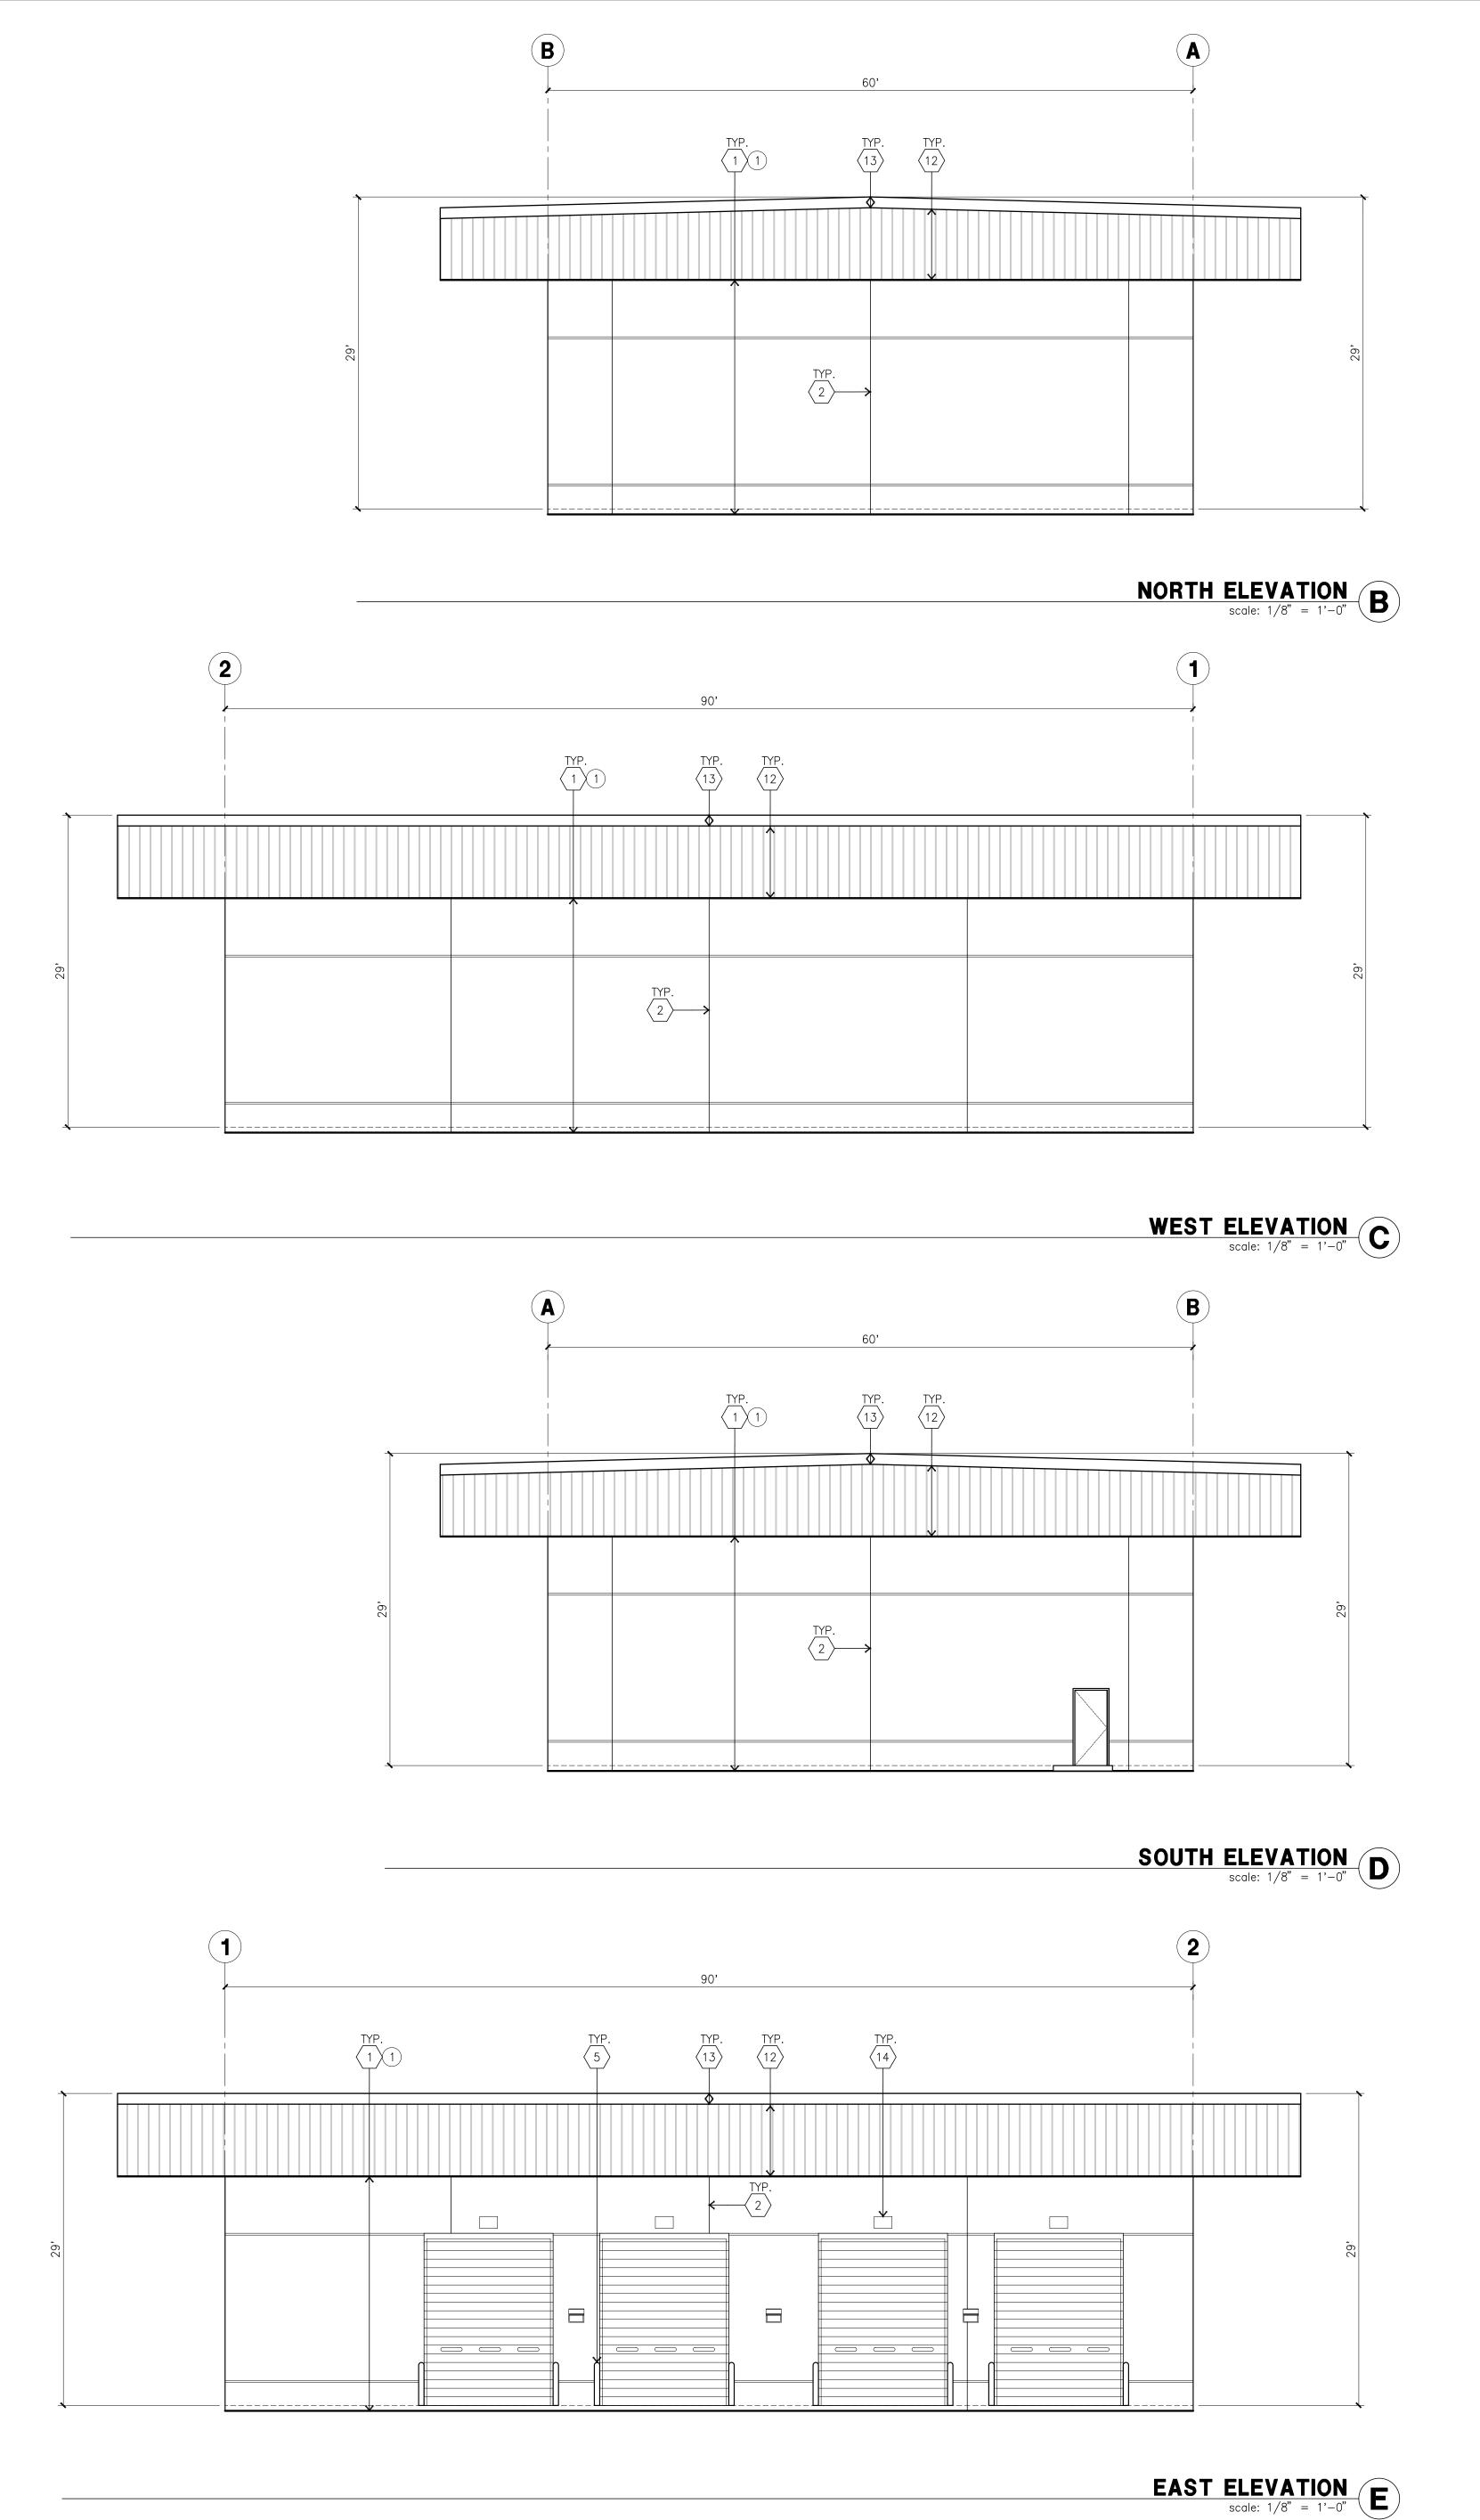

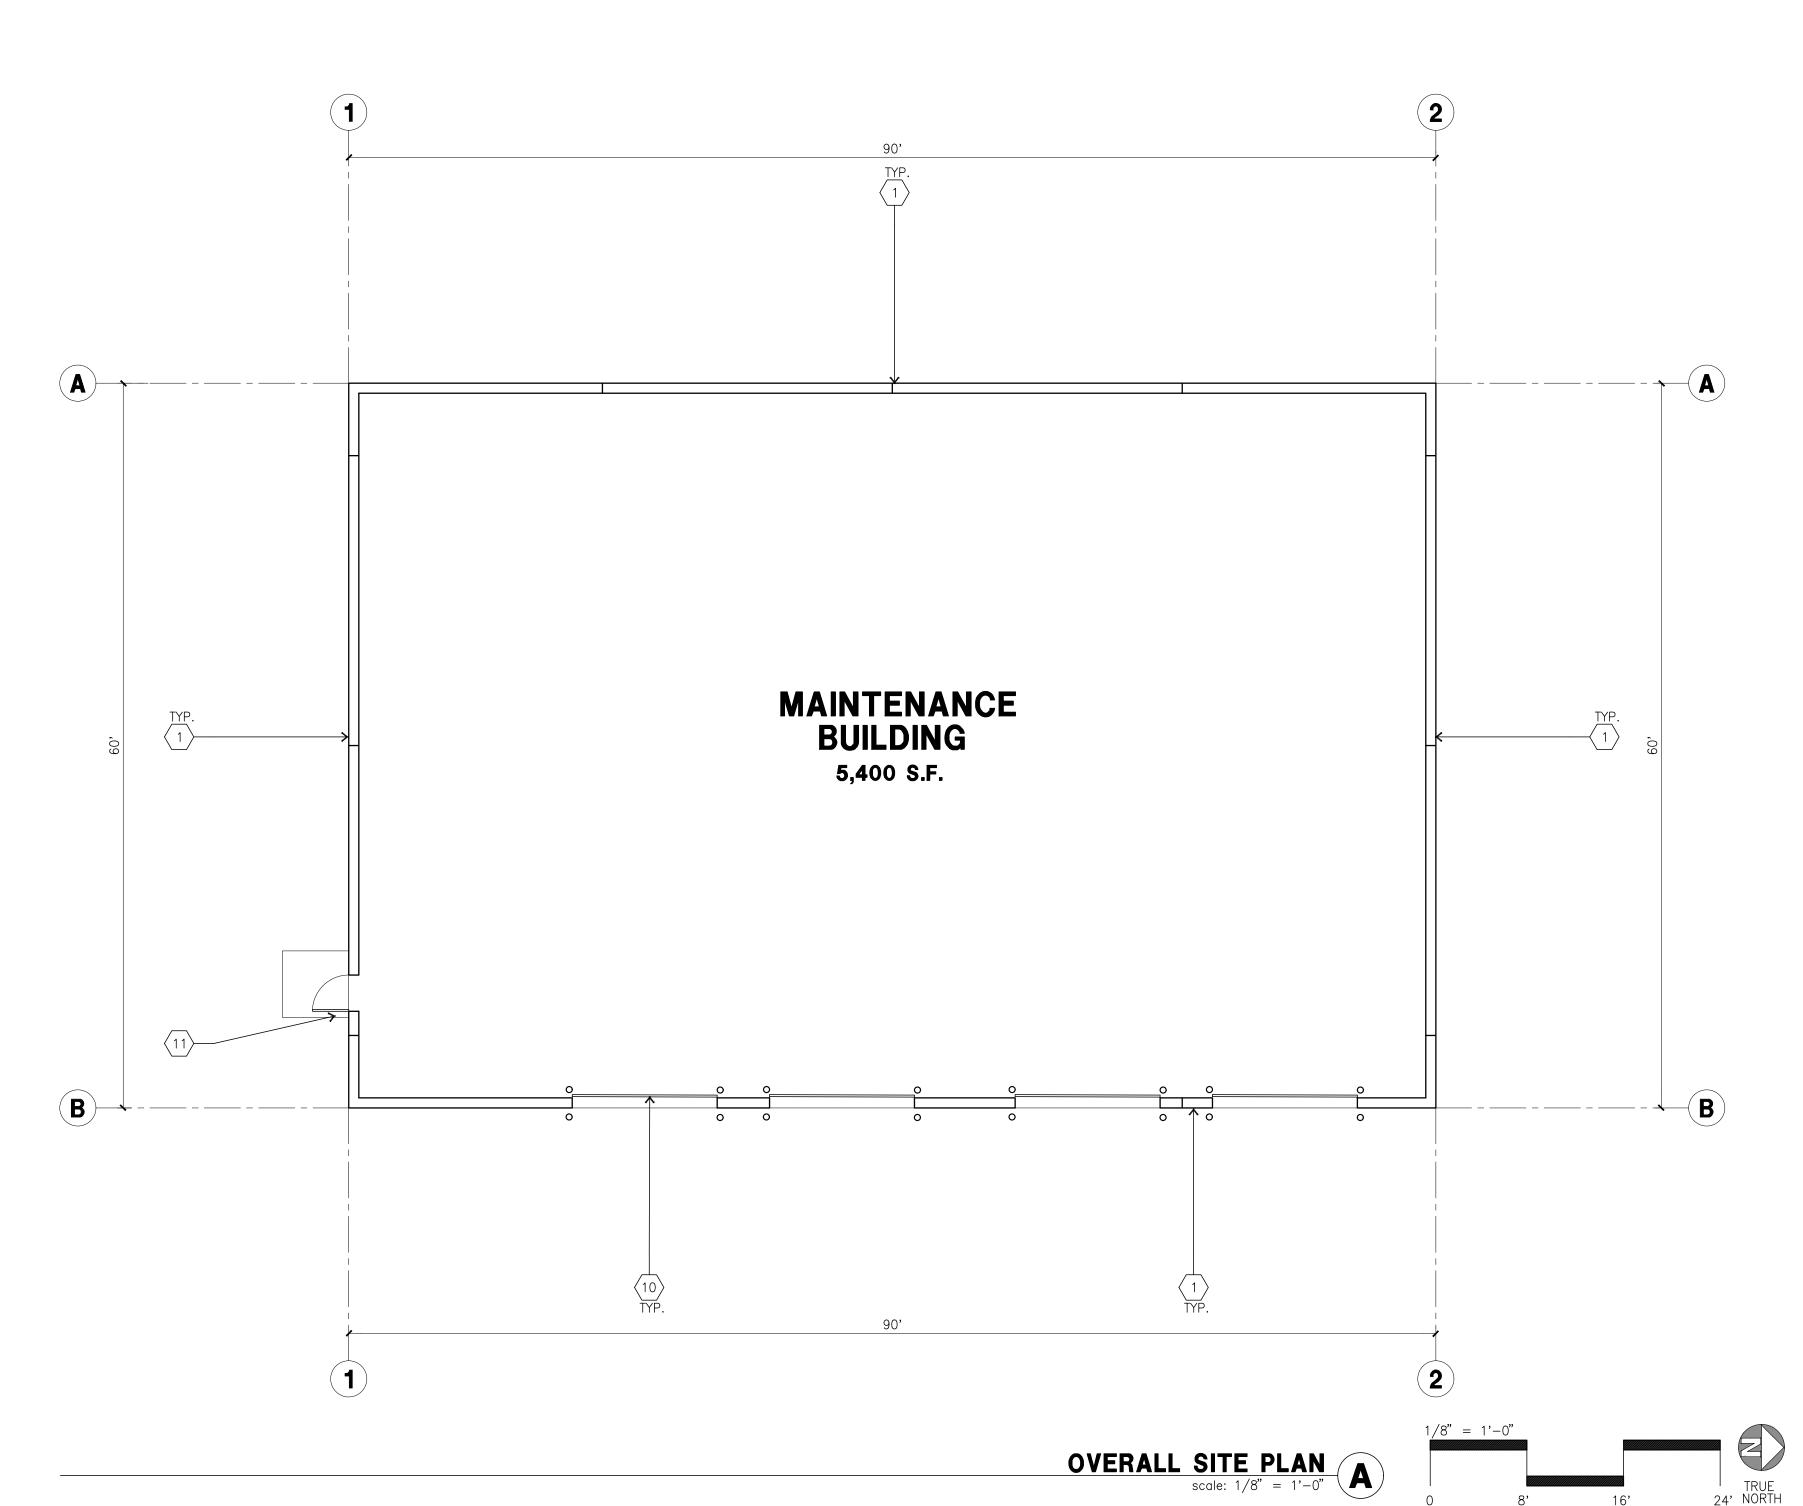

FLOOR PLAN KEYNOTES

(1) CONCRETE TILT-UP PANEL.

 \langle 2 \rangle STRUCTURAL STEEL COLUMN. TYPICAL STOREFRONT SYSTEM WITH GLAZING. SEE OFFICE BLOW-UP AND ELEVATIONS FOR SIZE, COLOR AND LOCATIONS.

CONCRETE RAMP W/ 42"HIGH CONC TILT-UP GUARD WALL OR BUILDING WALL ON BOTH SIDE OF RAMP. \langle 5 \rangle CONC. FILLED GUARD POST. 6" DIA. U.N.O.. 42"H.

6 EXTERIOR CONCRETE STAIR W/ 42"HIGH CONC TILT-UP GUARD WALL OR BUILDING WALL ON BOTH SIDE OF RAMP.

 \langle 7 \rangle 9' X 10' TRUCK DOOR, SECTIONAL O'H., STANDARD GRADE. \langle 8 \rangle Z GUARD

(9) DOCK DOOR BUMPER TYPICAL.

 $\langle 10 \rangle$ 12' X 14' DRIVE THRU. SECTIONAL O.H., STANDARD GRADE.

 $\langle 11 \rangle$ 3' X 7' HOLLOW METAL EXTERIOR MAN DOOR.

ELEVATION KEYNOTES

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 \langle 2 \rangle PANEL JOINT.

PANEL REVEAL. ALL REVEALS TO HAVE A MAX. OF 3/8" CHAMFER.

REVEAL COLOR TO MATCH ADJACENT BUILDING FIELD COLOR. U.N.O.

12' X 14' OVERHEAD DOOR @ DRIVE THRU. PROVIDE COMPLETE

WEATHER—STRIPPING PROTECTION ALL AROUND.

9' X 10' OVERHEAD DOOR @ DRIVE THRU. PROVIDE COMPLETE

WEATHER-STRIPPING PROTECTION ALL AROUND. 6 CONCRETE STAIR, LANDING AND GUARDRAIL W/ METAL PIPE HANDRAIL. PROVIDE NON SKID NOSING TO MEET ADA REQUIREMENTS. PROVIDE CONTRASTING COLORED 3" WIDE WARNING STRIPE INTEGRAL TO CONCRETE AT TOP LANDING AND BOTTOM TREAD PER ADA REQUIREMENTS.

HOLLOW METAL DOORS. PROVIDE COMPLETE WEATHER STRIPING ALL AROUND DOOR.

 \langle 8 \rangle DOCK DOOR BUMPER TYPICAL. ALUMINUM STOREFRONT FRAMING WITH TEMPERED GLAZING AT ALL DOORS, 9 SIDELITES ADJACENT TO DOORS AND GLAZING WITH BOTTOMS LESS THAN

18" ABOVE FINISH FLOOR ELEVATION. (10) METAL CANOPY.

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 $\langle 12 \rangle$ PRE FINISHED FLUSH SEAM 22 GAUGE METAL PANEL. (13) FULLY ADHERED TPO ROOF OVER DOCK.

14 DOCK NUMBER SIGN MOUNTED TO METAL FASCIA PANELS.

architecture

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Consultants:


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Structural:	-
Mechanical:	-
Plumbing:	-
Electrical:	-
Landscape:	-
Fire Protection:	-
Soils Engineer:	-


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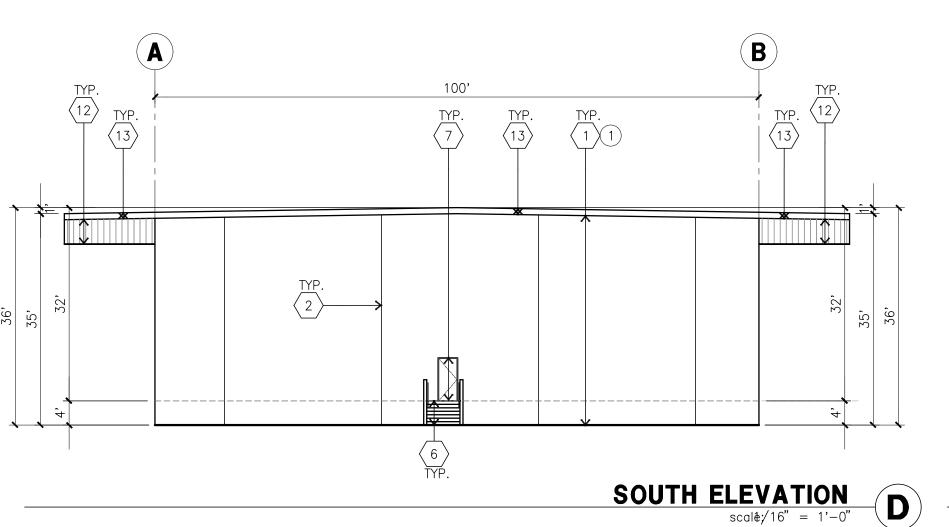
ELEVATION


15175 Project Number: Drawn by: 7/12/21 Date: Revision:


MAINTENANCE BUILDING



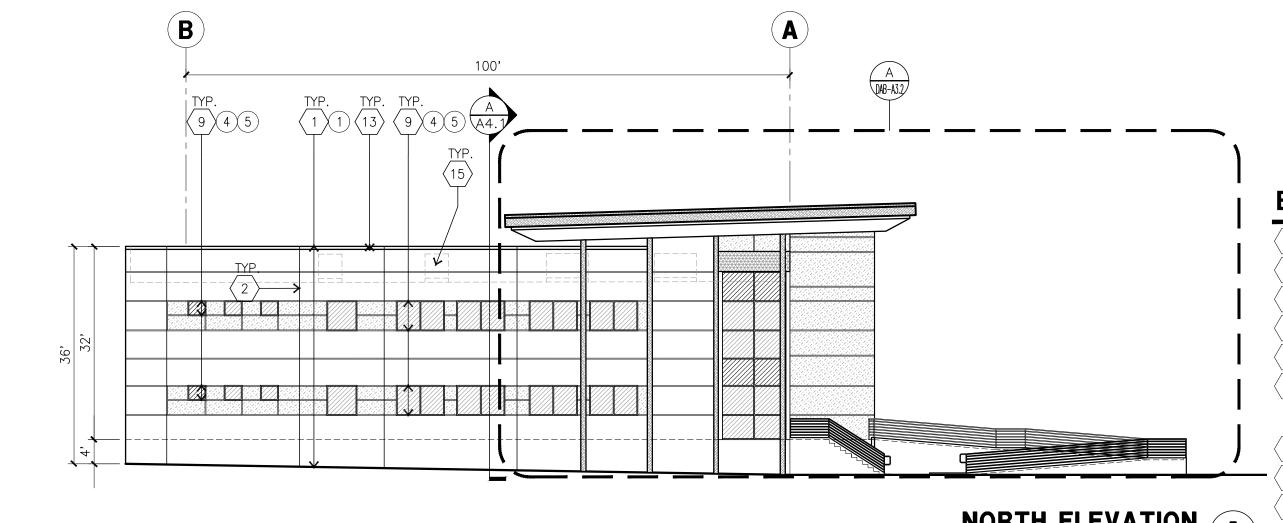

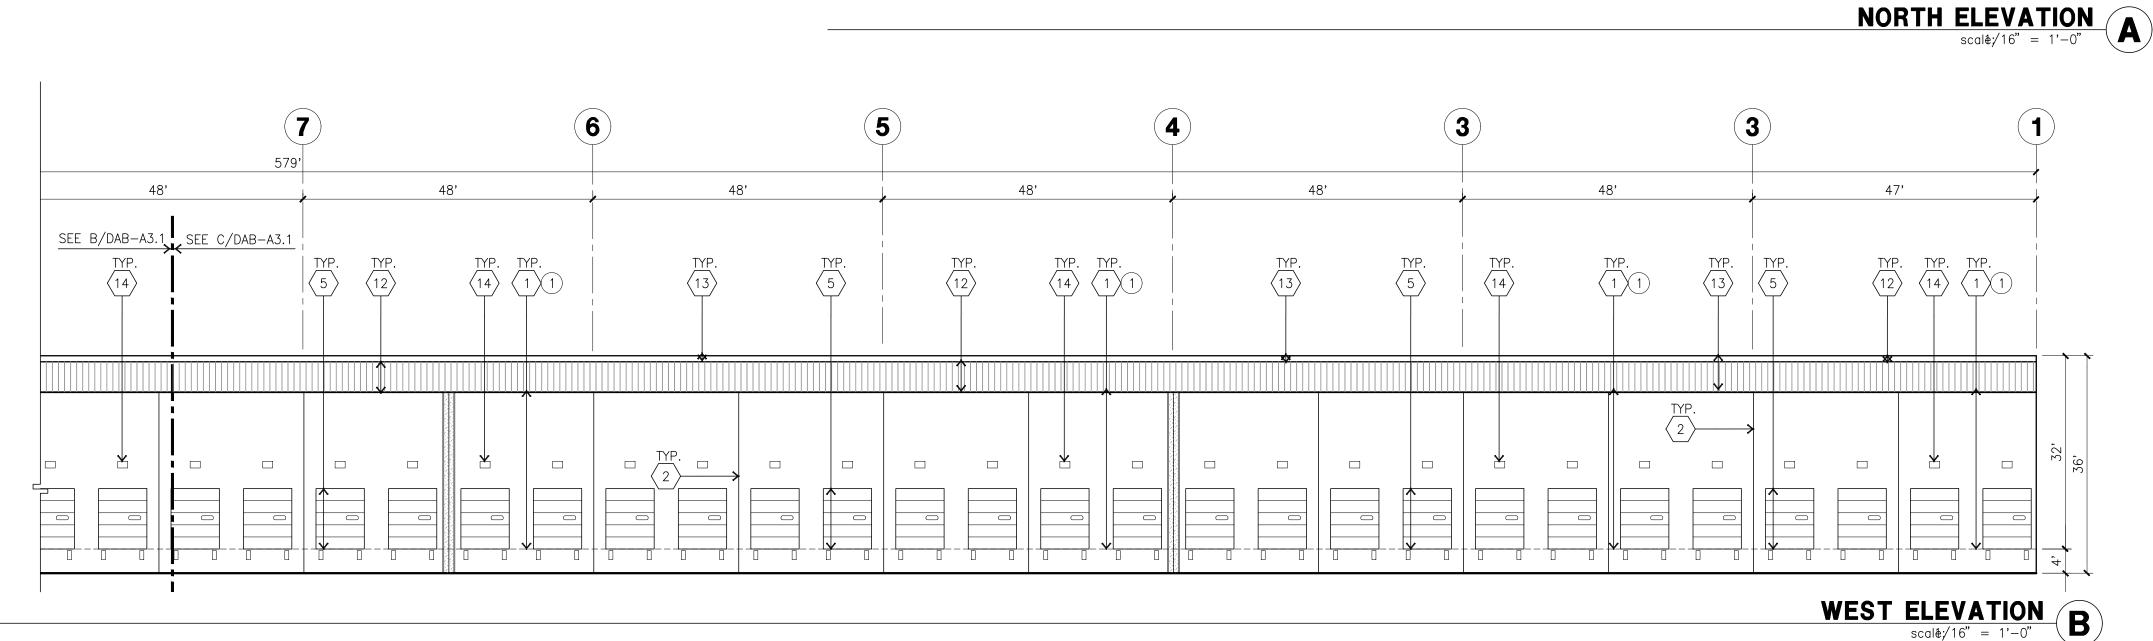

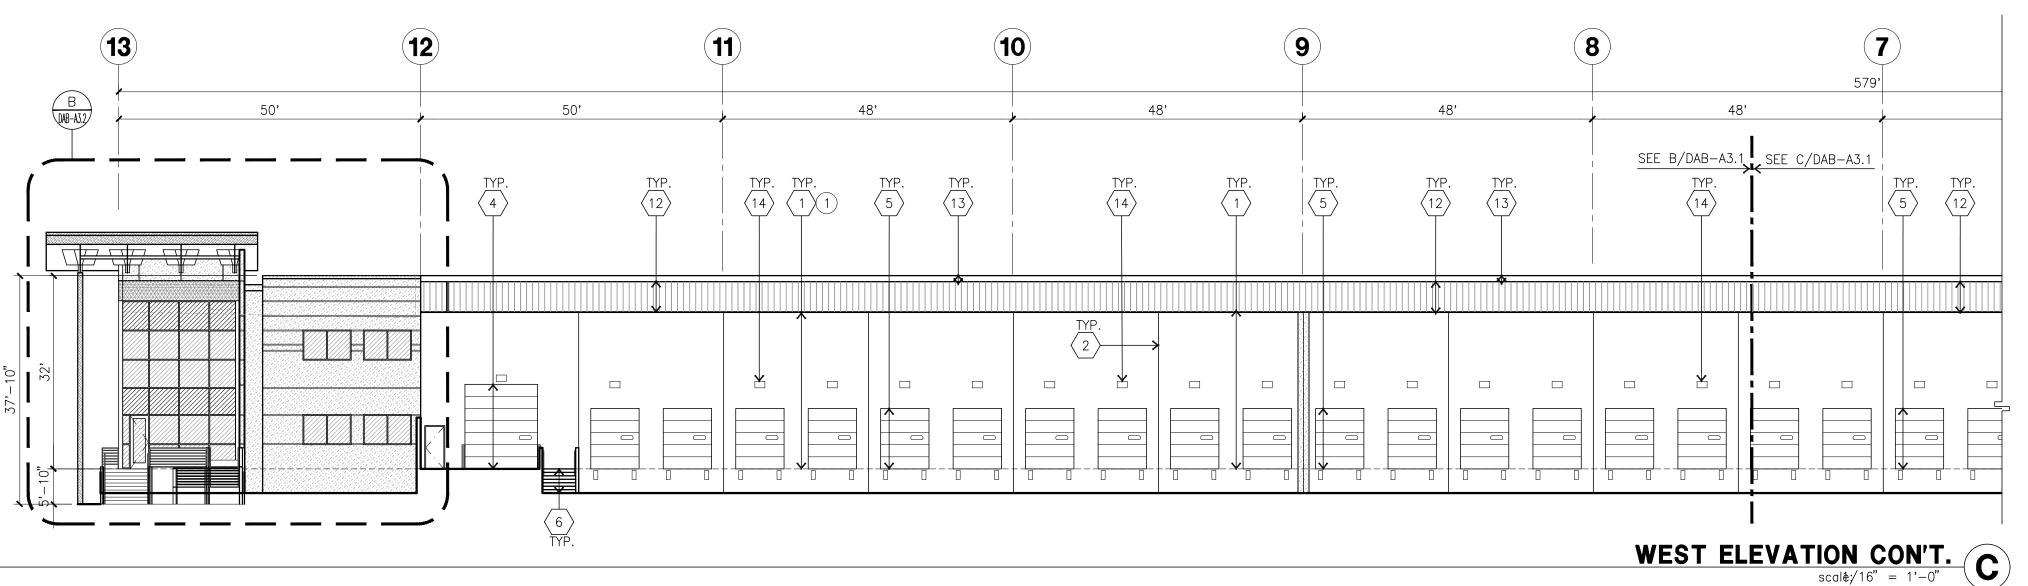

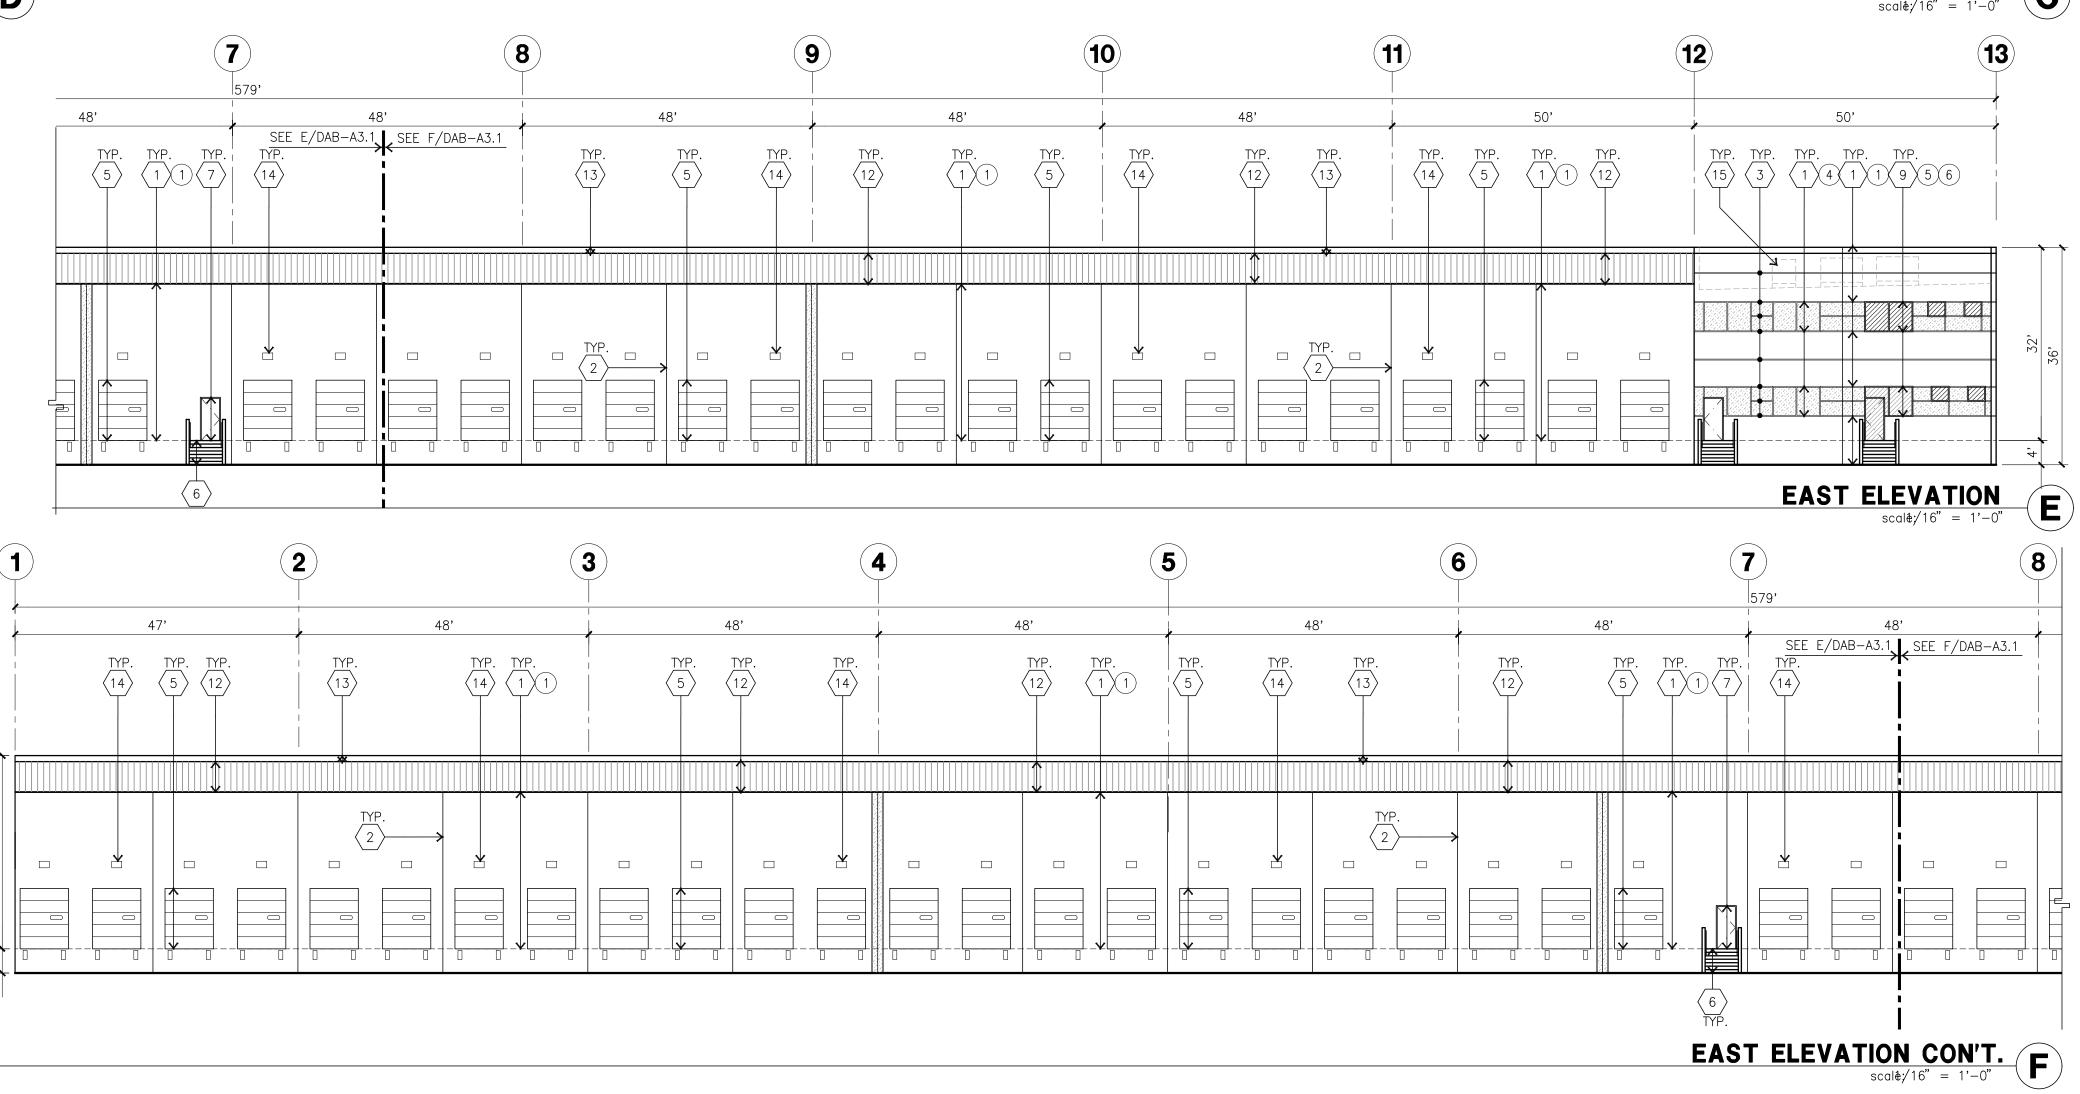

ELEVATION KEYNOTES

 \langle 1 \rangle CONCRETE TILT-UP PANEL.

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PANEL REVEAL. ALL REVEALS TO HAVE A MAX. OF 3/8" CHAMFER. REVEAL COLOR TO MATCH ADJACENT BUILDING FIELD COLOR. U.N.O. 12' X 14' OVERHEAD DOOR @ DRIVE THRU. PROVIDE COMPLETE WEATHER-STRIPPING PROTECTION ALL AROUND.

9' X 10' OVERHEAD DOOR @ DRIVE THRU. PROVIDE COMPLETE WEATHER-STRIPPING PROTECTION ALL AROUND. CONCRETE STAIR, LANDING AND GUARDRAIL W/ METAL PIPE HANDRAIL. PROVIDE NON SKID NOSING TO MEET ADA REQUIREMENTS. PROVIDE CONTRASTING COLORED 3" WIDE WARNING STRIPE INTEGRAL TO CONCRETE AT TOP LANDING AND BOTTOM TREAD PER ADA REQUIREMENTS. HOLLOW METAL DOORS. PROVIDE COMPLETE WEATHER STRIPING ALL AROUND DOOR.

DOCK DOOR BUMPER TYPICAL. ALUMINUM STOREFRONT FRAMING WITH TEMPERED GLAZING AT ALL DOORS, SIDELITES ADJACENT TO DOORS AND GLAZING WITH BOTTOMS LESS THAN 18" ABOVE FINISH FLOOR ELEVATION. METAL CANOPY.

(11) CONC. FILLED GUARD POST. 6" DIA. U.N.O.. 42"H.

 $\langle 12 \rangle$ PRE FINISHED FLUSH SEAM 22 GAUGE METAL PANEL.

(13) FULLY ADHERED TPO ROOF OVER DOCK.

 $\langle 14 \rangle$ DOCK NUMBER SIGN MOUNTED TO METAL FASCIA PANELS. $\langle 15 \rangle$ ROOF TOP HVAC UNIT, TYP.

ELEVATION GENERAL NOTES

1. ALL PAINT COLOR CHANGES TO OCCUR AT INSIDE CORNERS UNLESS NOTED OTHERWISE.

2. ALL PAINT FINISHES ARE TO BE FLAT UNLESS NOTED OTHERWISE.

3. T.O.P. EL.= TOP OF PARAPET ELEVATION.

4. F.F. = FINISH FLOOR ELEVATION.

5. STOREFRONT CONSTRUCTION: GLASS, METAL ATTACHMENTS AND LINTELS SHALL BE DESIGNED TO RESIST - MPH. EXPOSURE "C" WINDS. CONTRACTOR SHALL SUBMIT SHOP DRAWINGS PRIOR TO INSTALLATION.

COLORS. ARCHITECT AND OWNER SHALL APPROVE PRIOR TO PAINTING REMAINDER OF BUILDING. 7. BACK SIDE OF PARAPETS TO HAVE SMOOTH FINISH AND BE PAINTED WITH ELASTOMERIC PAINT.

6. CONTRACTOR SHALL FULLY PAINT ONE CONCRETE PANEL W/ SELECTED

8. FOR SPANDREL GLAZING, ALLOW SPACE BEHIND SPANDREL TO BREATH.

9. USE ADHESIVE BACK WOOD STRIPS FOR ALL REVEAL FORMS. 10. THE FIRST COAT OF PAINT TO BE ROLLED-ON AND THE SECOND COAT TO BE SPRAYED-ON

ELEVATION COLOR LEGEND/SCHED.

CONCRETE TILT-UP PANEL. COLOR: GREY PLD-8 DRAKE RGB: 146, 148, 141 CONCRETE TILT-UP PANEL. COLOR: GREY PLD-9 PURE WHITE RGB: 237, 236, 230 CONCRETE TILT-UP PANEL. COLOR: GREY PLD-6 SABLE RGB: 204, 201, 192

MULLIONS COLOR : CLEAR ANODIZED METAL CANOPY: ARCYLIC LATEX SYSTEMS HIGH GLOSS/HIGH PERFORMANCE IN PROLOGIS STD. GREY SCHEME PLD-9 PURE WHITE

GLAZING COLOR: GREEN REFLECTIVE GLAZING

GLAZING LEGEND

scale/16" = 1'-0"

NOTE: ALL EXTERIOR AND INTERIOR GLAZING SHALL BE TEMPERED.

SPANDREL GLASS WITH CONCRETE BEHIND INSULATED VISION GLASS SINGLE LITE VISION GLASS

IV : INSULATED VISION GLASS

1/4" PILKINGTON EVERGREEN ECLIPSE ADVANTAGE LOW E #2 TEMP. +

1/4" PPG SOLARBAN 60XL #3 TEMP.

1" INSULATED GLASS UNIT WITH 1/2" AIRSPACE

SPANDREL GLASS

SC : SPANDREL WITH CONCRETE BEHIND
1/4" PILKINGTON EVERGREEN SPANDREL TEMPERED

1/4" TEMPERED GLASS MULLIONS : ANODIZED CLEAR.

V : VISION GLASS



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Consultants:

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Fire Protection:

Soils Engineer:





Title: ELEVATION

Project Number: Drawn by: 7/12/21

Date: Revision:

DAB-A3.

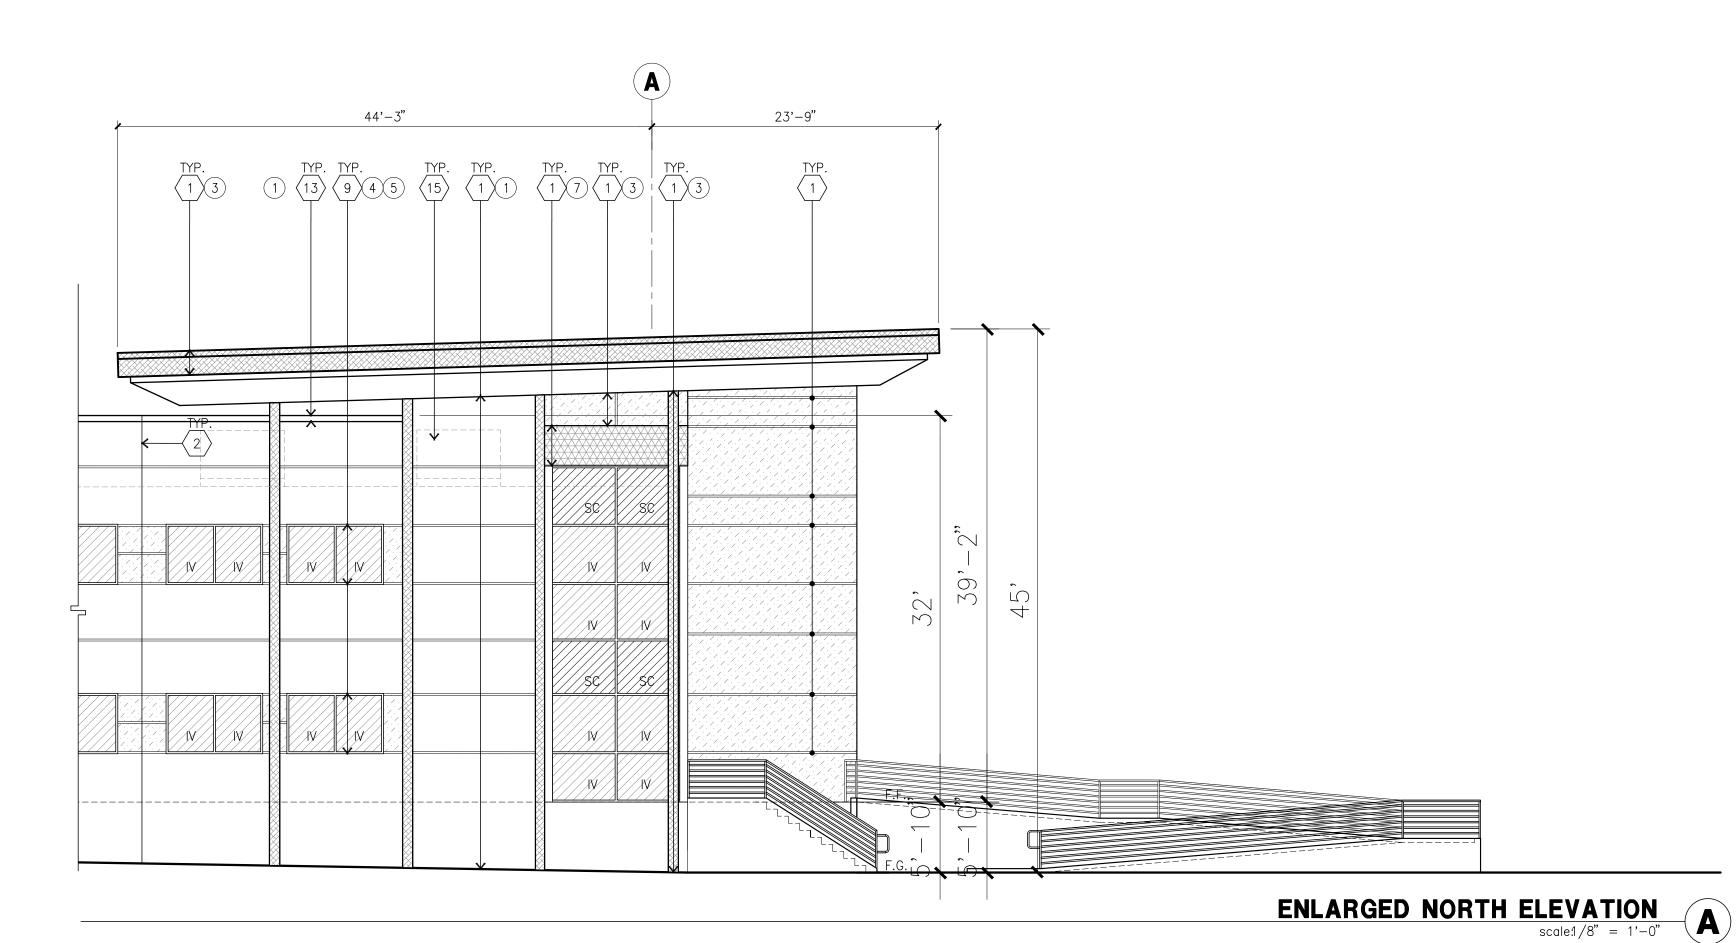

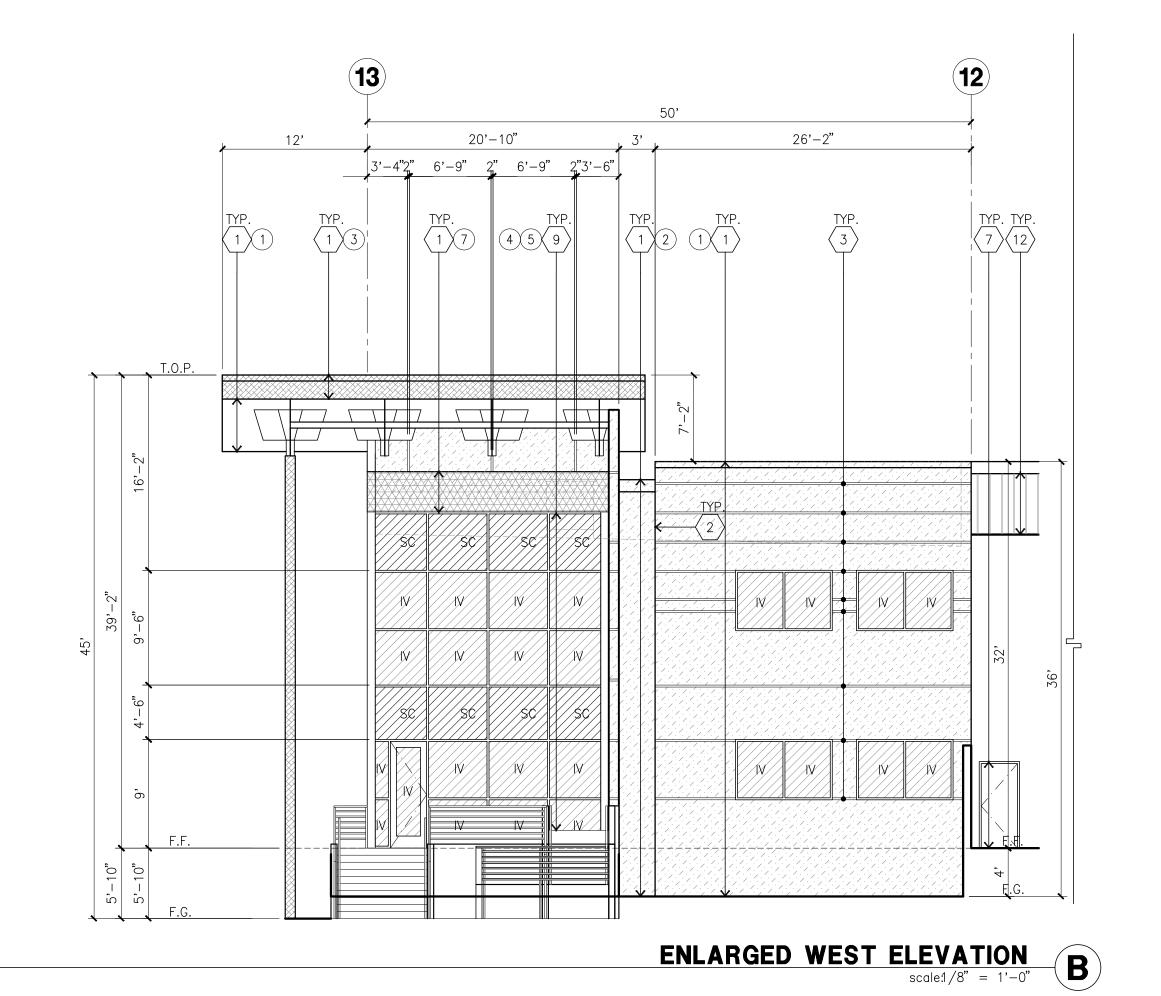

ELEVATION KEYNOTES

(1) CONCRETE TILT-UP PANEL.

 $\langle 2 \rangle$ PANEL JOINT.

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WEATHER-STRIPPING PROTECTION ALL AROUND. 9' X 10' OVERHEAD DOOR @ DRIVE THRU. PROVIDE COMPLETE / WEATHER-STRIPPING PROTECTION ALL AROUND.

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/ AROUND DOOR.

ALUMINUM STOREFRONT FRAMING WITH TEMPERED GLAZING AT ALL DOORS, $\stackrel{9}{>}$ sidelites adjacent to doors and glazing with bottoms less than $\stackrel{\circ}{}$ 18" ABOVE FINISH FLOOR ELEVATION. $\langle 10 \rangle$ METAL CANOPY.

(11) CONC. FILLED GUARD POST. 6" DIA. U.N.O.. 42"H.

(12) PRE FINISHED FLUSH SEAM 22 GAUGE METAL PANEL.

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 $\langle 15 \rangle$ ROOF TOP HVAC UNIT, TYP.

ELEVATION GENERAL NOTES

1. ALL PAINT COLOR CHANGES TO OCCUR AT INSIDE CORNERS UNLESS NOTED

2. ALL PAINT FINISHES ARE TO BE FLAT UNLESS NOTED OTHERWISE.

3. T.O.P. EL.= TOP OF PARAPET ELEVATION. 4. F.F. = FINISH FLOOR ELEVATION.

SUBMIT SHOP DRAWINGS PRIOR TO INSTALLATION.

5. STOREFRONT CONSTRUCTION: GLASS, METAL ATTACHMENTS AND LINTELS SHALL BE DESIGNED TO RESIST - MPH. EXPOSURE "C" WINDS. CONTRACTOR SHALL

6. CONTRACTOR SHALL FULLY PAINT ONE CONCRETE PANEL W/ SELECTED COLORS. ARCHITECT AND OWNER SHALL APPROVE PRIOR TO PAINTING REMAINDER OF BUILDING.

7. BACK SIDE OF PARAPETS TO HAVE SMOOTH FINISH AND BE PAINTED WITH ELASTOMERIC PAINT.

8. FOR SPANDREL GLAZING, ALLOW SPACE BEHIND SPANDREL TO BREATH.

9. USE ADHESIVE BACK WOOD STRIPS FOR ALL REVEAL FORMS. 10. THE FIRST COAT OF PAINT TO BE ROLLED-ON AND THE SECOND COAT TO BE SPRAYED-ON

ELEVATION COLOR LEGEND/SCHED.

CONCRETE TILT-UP PANEL. COLOR: GREY PLD-9 PURE WHITE RGB: 237, 236, 230 CONCRETE TILT-UP PANEL. COLOR: GREY PLD-6 SABLE RGB: 204, 201, 192

GLAZING COLOR : GREEN REFLECTIVE GLAZING

MULLIONS COLOR : CLEAR ANODIZED METAL CANOPY: ARCYLIC LATEX SYSTEMS HIGH GLOSS/HIGH
PERFORMANCE IN PROLOGIS STD. GREY SCHEME
PLD-9 PURE WHITE

GLAZING LEGEND

NOTE: ALL EXTERIOR AND INTERIOR GLAZING SHALL BE TEMPERED.

SPANDREL GLASS WITH CONCRETE BEHIND INSULATED VISION GLASS SINGLE LITE VISION GLASS

IV : INSULATED VISION GLASS

1/4" PILKINGTON EVERGREEN ECLIPSE ADVANTAGE LOW E #2 TEMP. +

1/4" PPG SOLARBAN 60XL #3 TEMP.

1" INSULATED GLASS UNIT WITH 1/2" AIRSPACE

SPANDREL GLASS

SC: SPANDREL WITH CONCRETE BEHIND
1/4" PILKINGTON EVERGREEN SPANDREL TEMPERED

V : VISION GLASS 1/4" **TEMPERED GLASS**

MULLIONS : ANODIZED CLEAR.



hpa, inc. 18831 bardeen avenue - ste. #100 irvine, ca 92612

tel: 949 •863 •1770

fax: 949 • 863 • 0851





Owner:



PROLOGIS 7777 CENTER COURT DR N, STE 100 CERRITOS, CA 90703 tel: 562.345.9237



ORANGE STRUCK ST

534 W. STRUCK STREET ORANGE, CA



Consultants:

Structural: Mechanical: Plumbing: Electrical: Landscape: Fire Protection:




Title: ELEVATION

Soils Engineer:

15175 Project Number: Drawn by: 7/12/21 Date:


Revision:

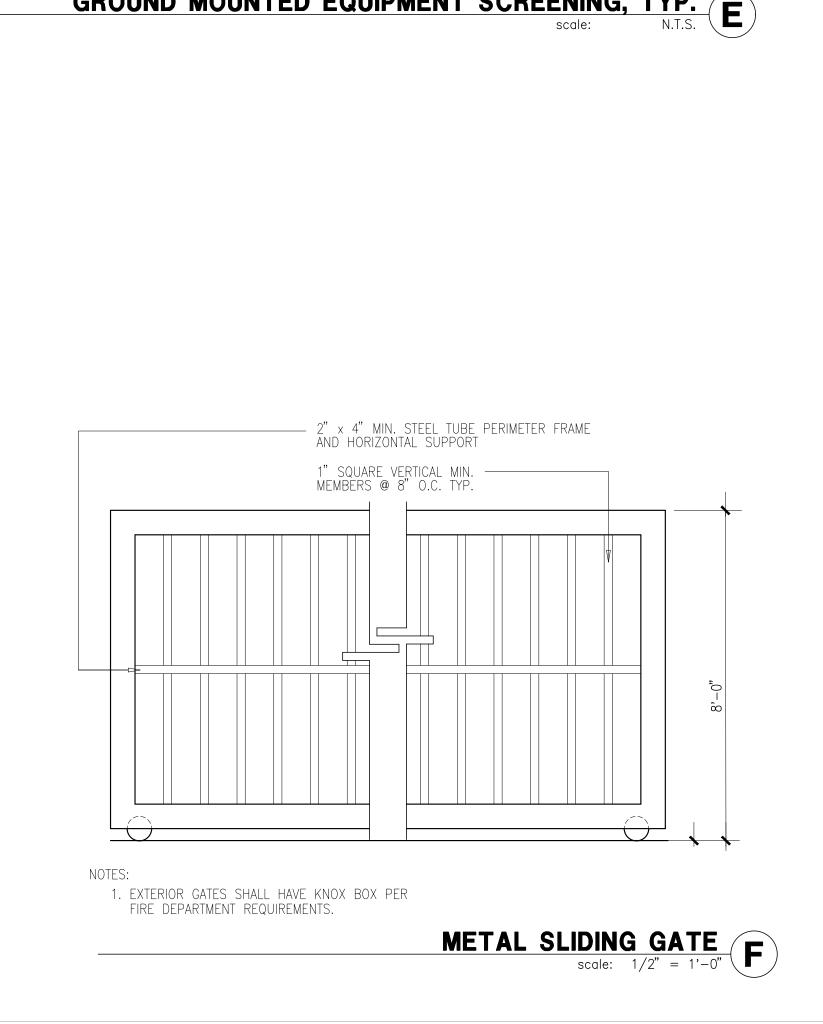

LANDSCAPE AREA (VARIES)

TYPICAL PARKING SECTION Scale: N.T.S.

AUTO PARKING

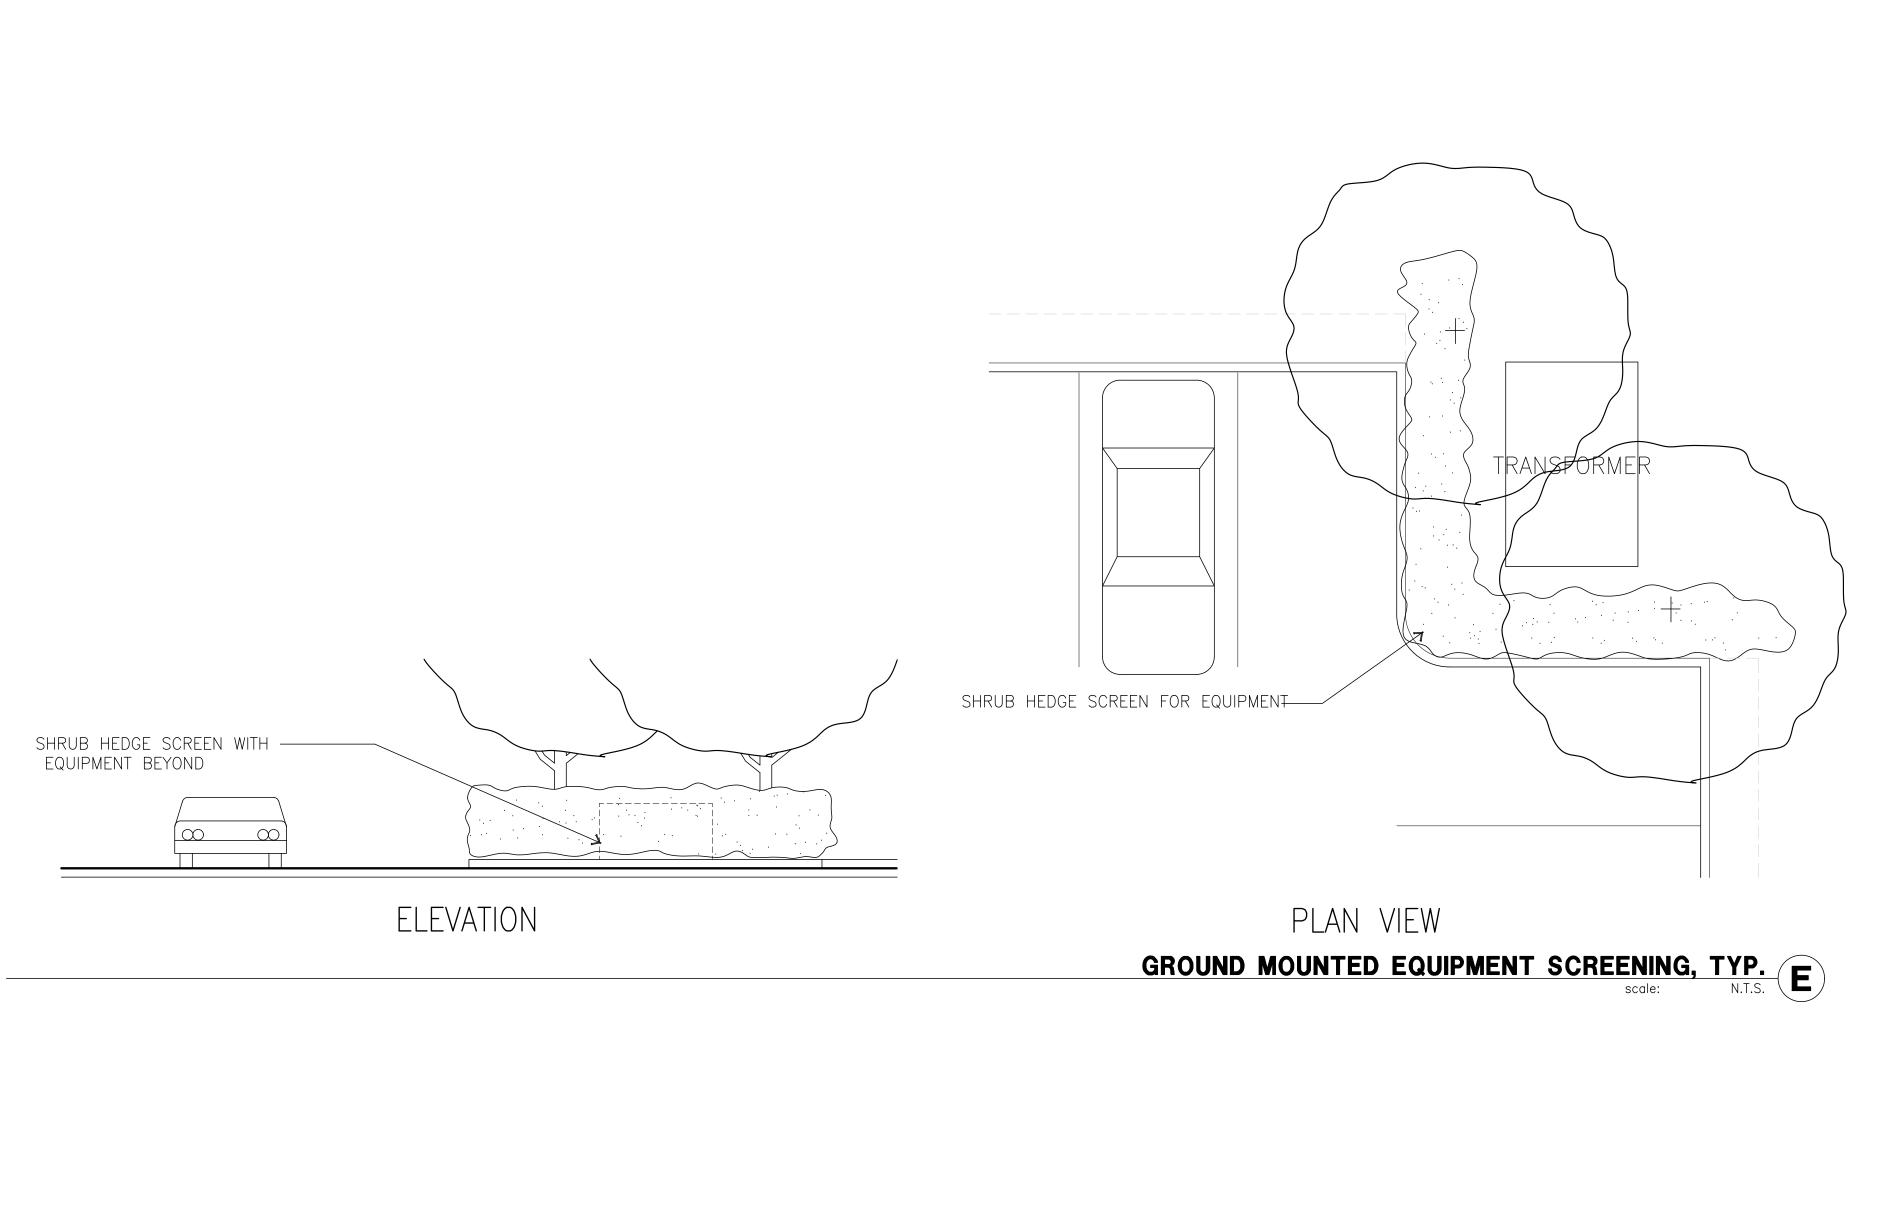

DIMENSION CONTROL POINT

DIMENSION CONTROL POINT

G OF REVEAL

BOTTOM OF REVEAL

1. DIMENSION CONTROL POINTS AT REVEALS AND EDGE OF CONCRETE OPENINGS WHERE OCCUR, SEE WALL SECTIONS.

2. PAINT COLOR CHANGES TO ALWAYS OCCUR AT CONTROL POINT "A" OR "B"

& CHANGE OF PAINT COLOR IF OCCURS.

— CONC. TILT—UP PANEL, SEE STRUCT. & FINISH SCHEDULE

& CHANGE OF PAINT COLOR IF OCCURS.

TYP. CONCRETE REVEAL Scale: N.T.S. C

DIMENSION CONTROL POINT

TOP OF REVEAL

NOTES:

1 1/2" STEEL PIPE RAILING

A-36 GALVANIZED STEEL RAIL.

CONCRETE FOOTING, SIZE —

6" X 6" CAST-IN-PLACE CONCRETE MOW CURB.

A-36 GALVANIZED STEEL
PICKETS 1: SQ. 16 GA
TUBULAR STEEL AT
6" O.C. WELDED TO OUTSIDE
OF FENCE.

AS REQUIRED.

A-36 GALVANIZED STEEL RAIL.

2" W X 2" H X 14 GA

TUBULAR STEEL CHANNELS.

CONCRETE FOOTING, SIZE COMPACTED SUBGRADE.

OR AS 18" CONCRETE FOOTING, SIZE COMPACTED SUBGRADE.

ELEVATION

6" X 6" CAST-IN-PLACE CUNCRETE MOW CURB.

CONC. WALK W/

— A-36 GALVANIZED STEEL POST 4" X 4" SQ. X 11 GA TUBULAR STEEL POSTS AT 8'-0" O.C. W/ CAP WELDED ALL AROUND.

1. ALL TERMINAL POSTS

TO BE 4' W X 4" D X
11 GA STELL TUBES W/ CAP
WELDED ALL AROUND.

3. CONCRETE MOW CURB IS
REQUIRED WHEN FENCE IS
ADJACENT TO TURF AREAS ONLY.
ALL OTHER PLANTER AREAS
ADJACENT TO FENCE WILL

5. PAINT BLACK PER THE SPEC.

8.8.8.8.8

3/4"

8.8.6

.

8.08.0

. . 0. . . 0. .

2. ALL FENCE COMPONENTS TO BE PRIMED AND PAINTED TO MATCH BLD'G.

NOT HAVE MOW CURB.

4. SAND AND GRIND ALL WENDS SMOOTH.

_ A_36 GALVANIZED STEEL POST

TUBULAR STEEL POSTS AT 8'-0"

6" O.C. WELDED TO OUTSIDE OF FENCE.


METAL FENCE DETAIL scale: N.T.S.


O.C. W/ CAP WELDED ALL AROUND.


- 4" X 4" SQ. X 11 GA

A-36 GALVANIZED STEEL PICKETS 1: SQ. 16 GA TUBULAR STEEL AT


PLAN VIEW

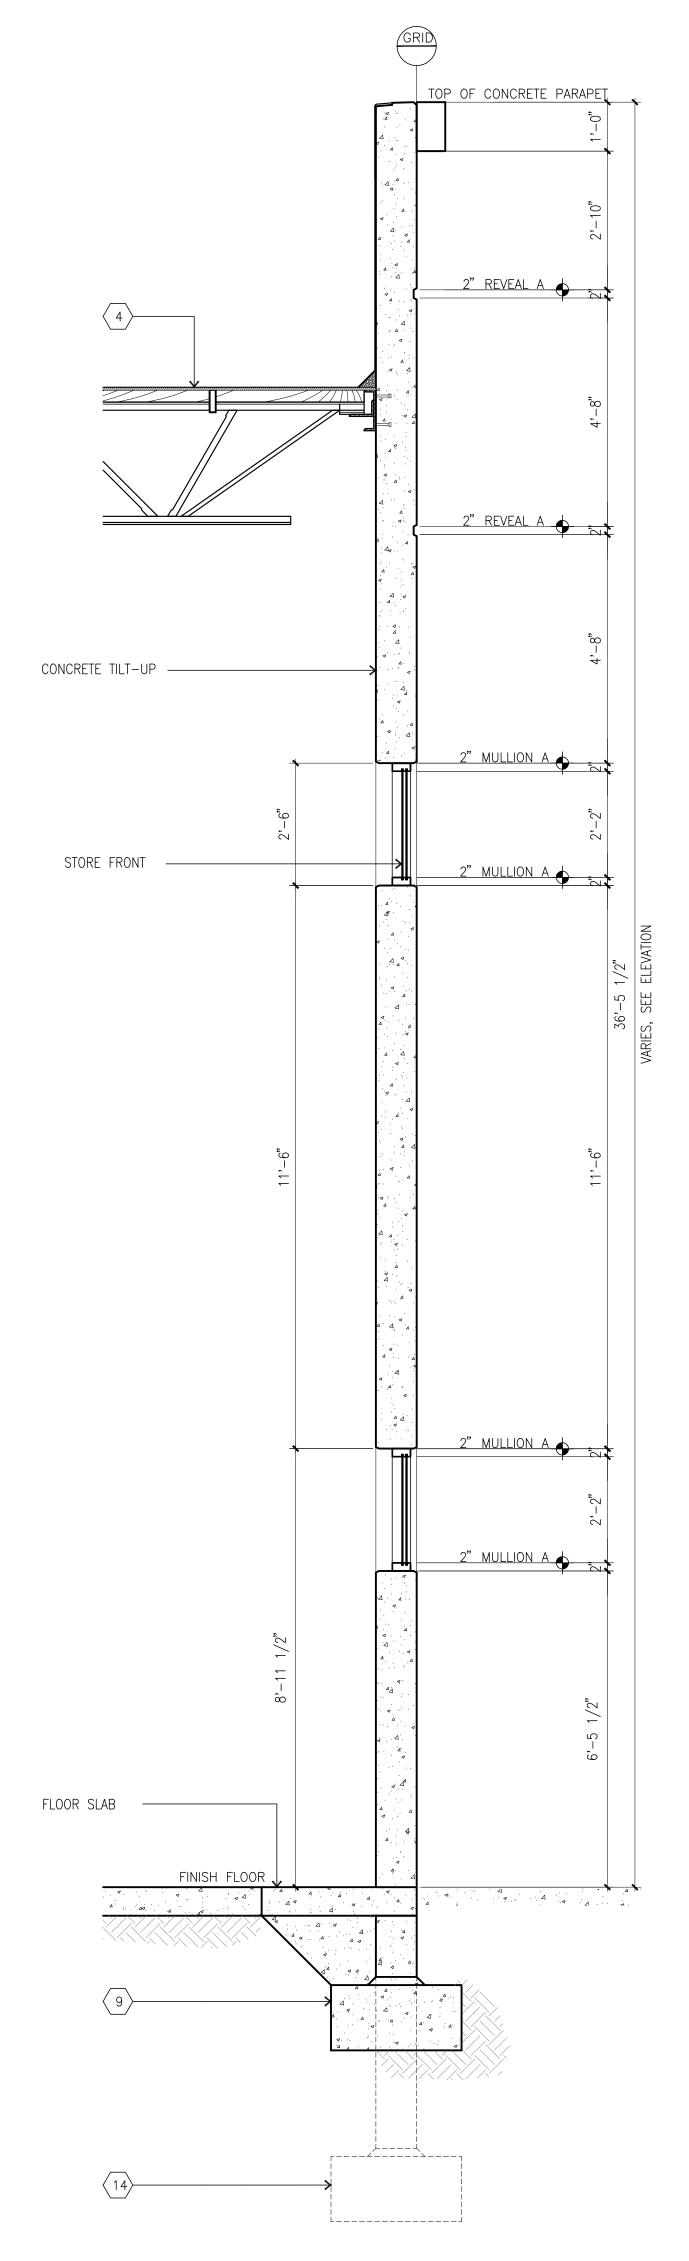


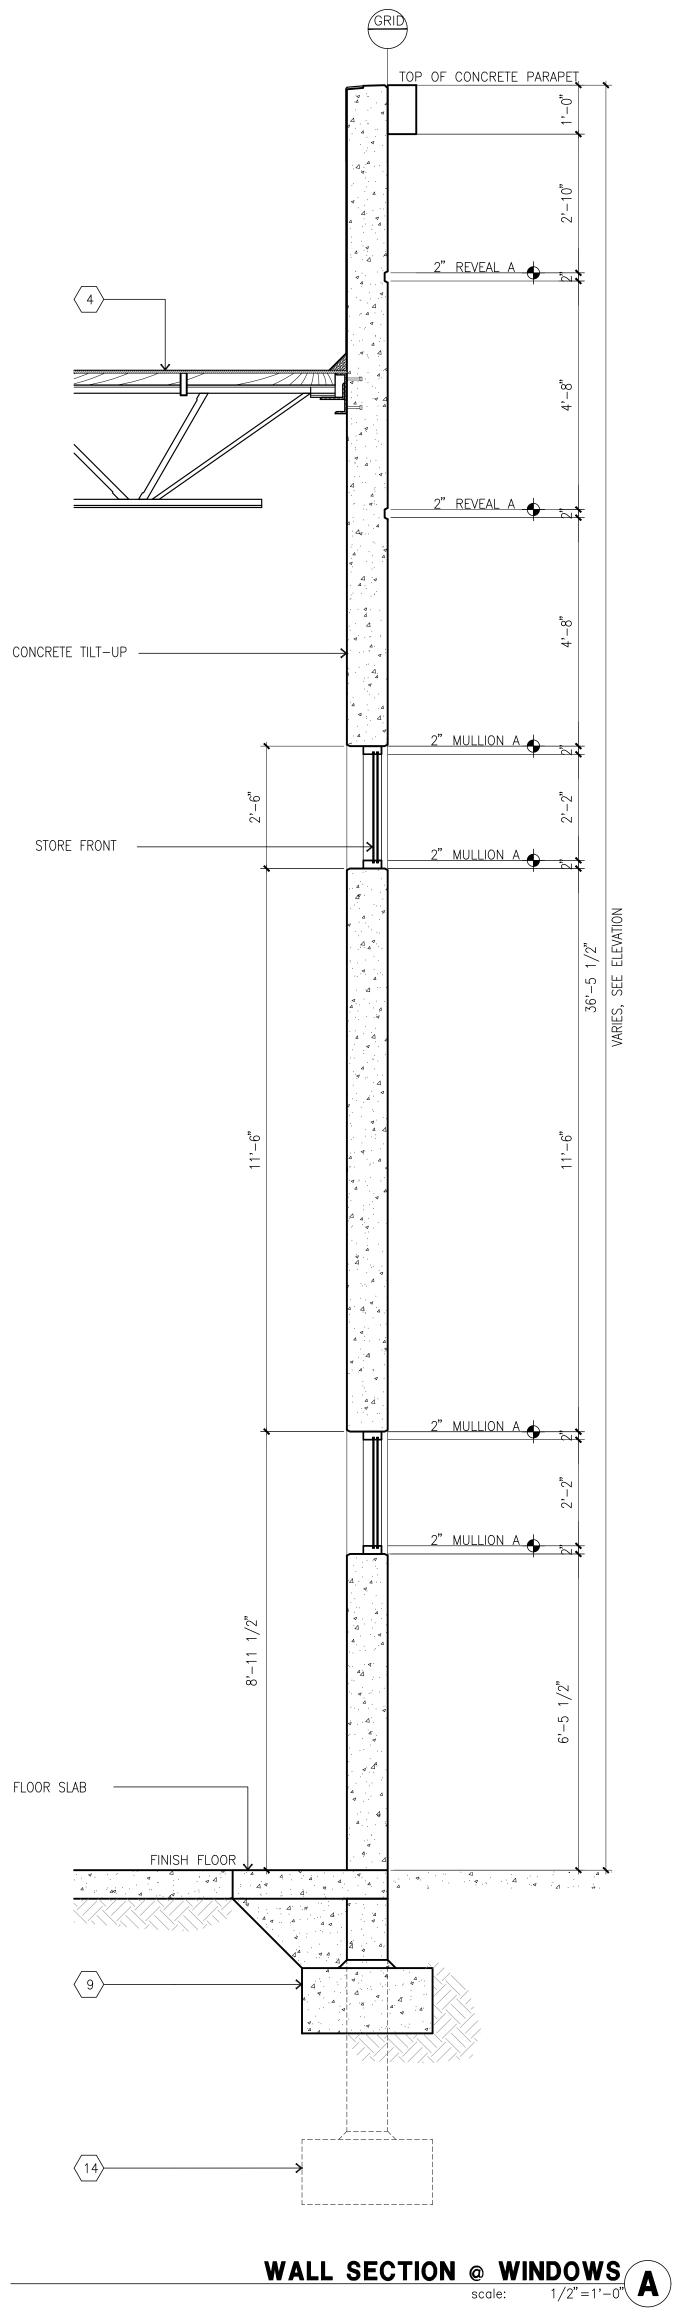

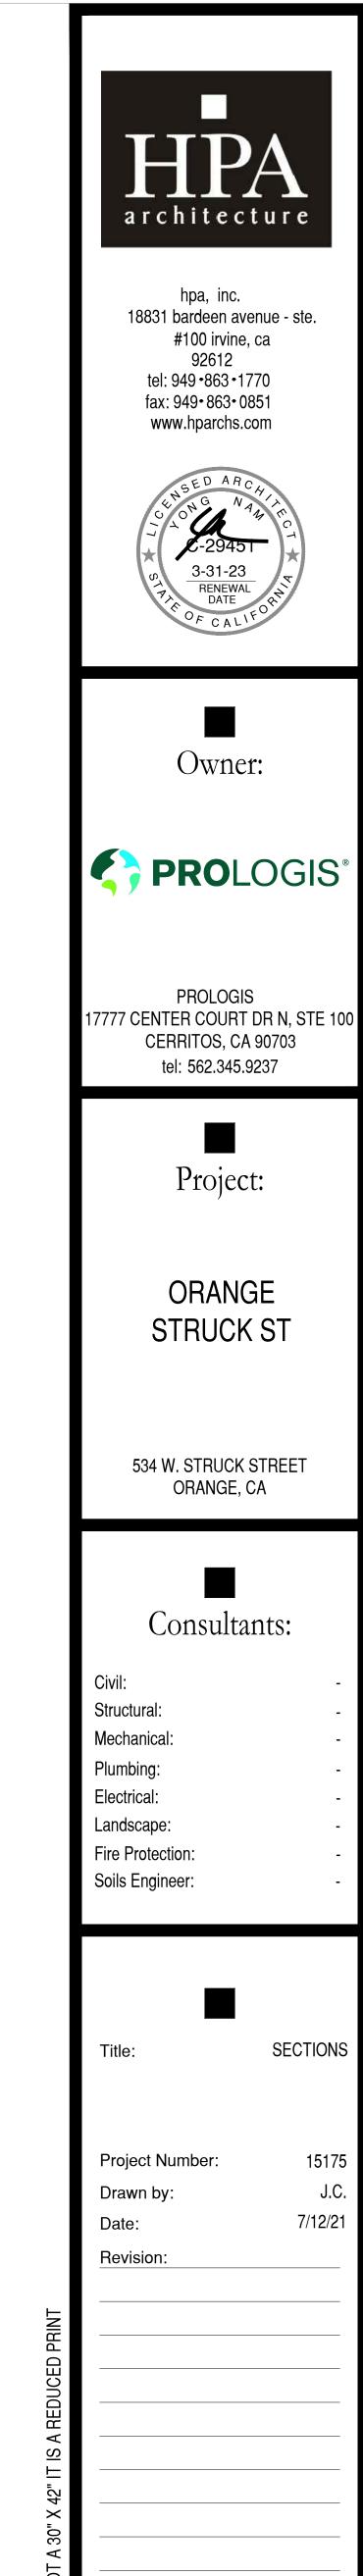

Sheet:

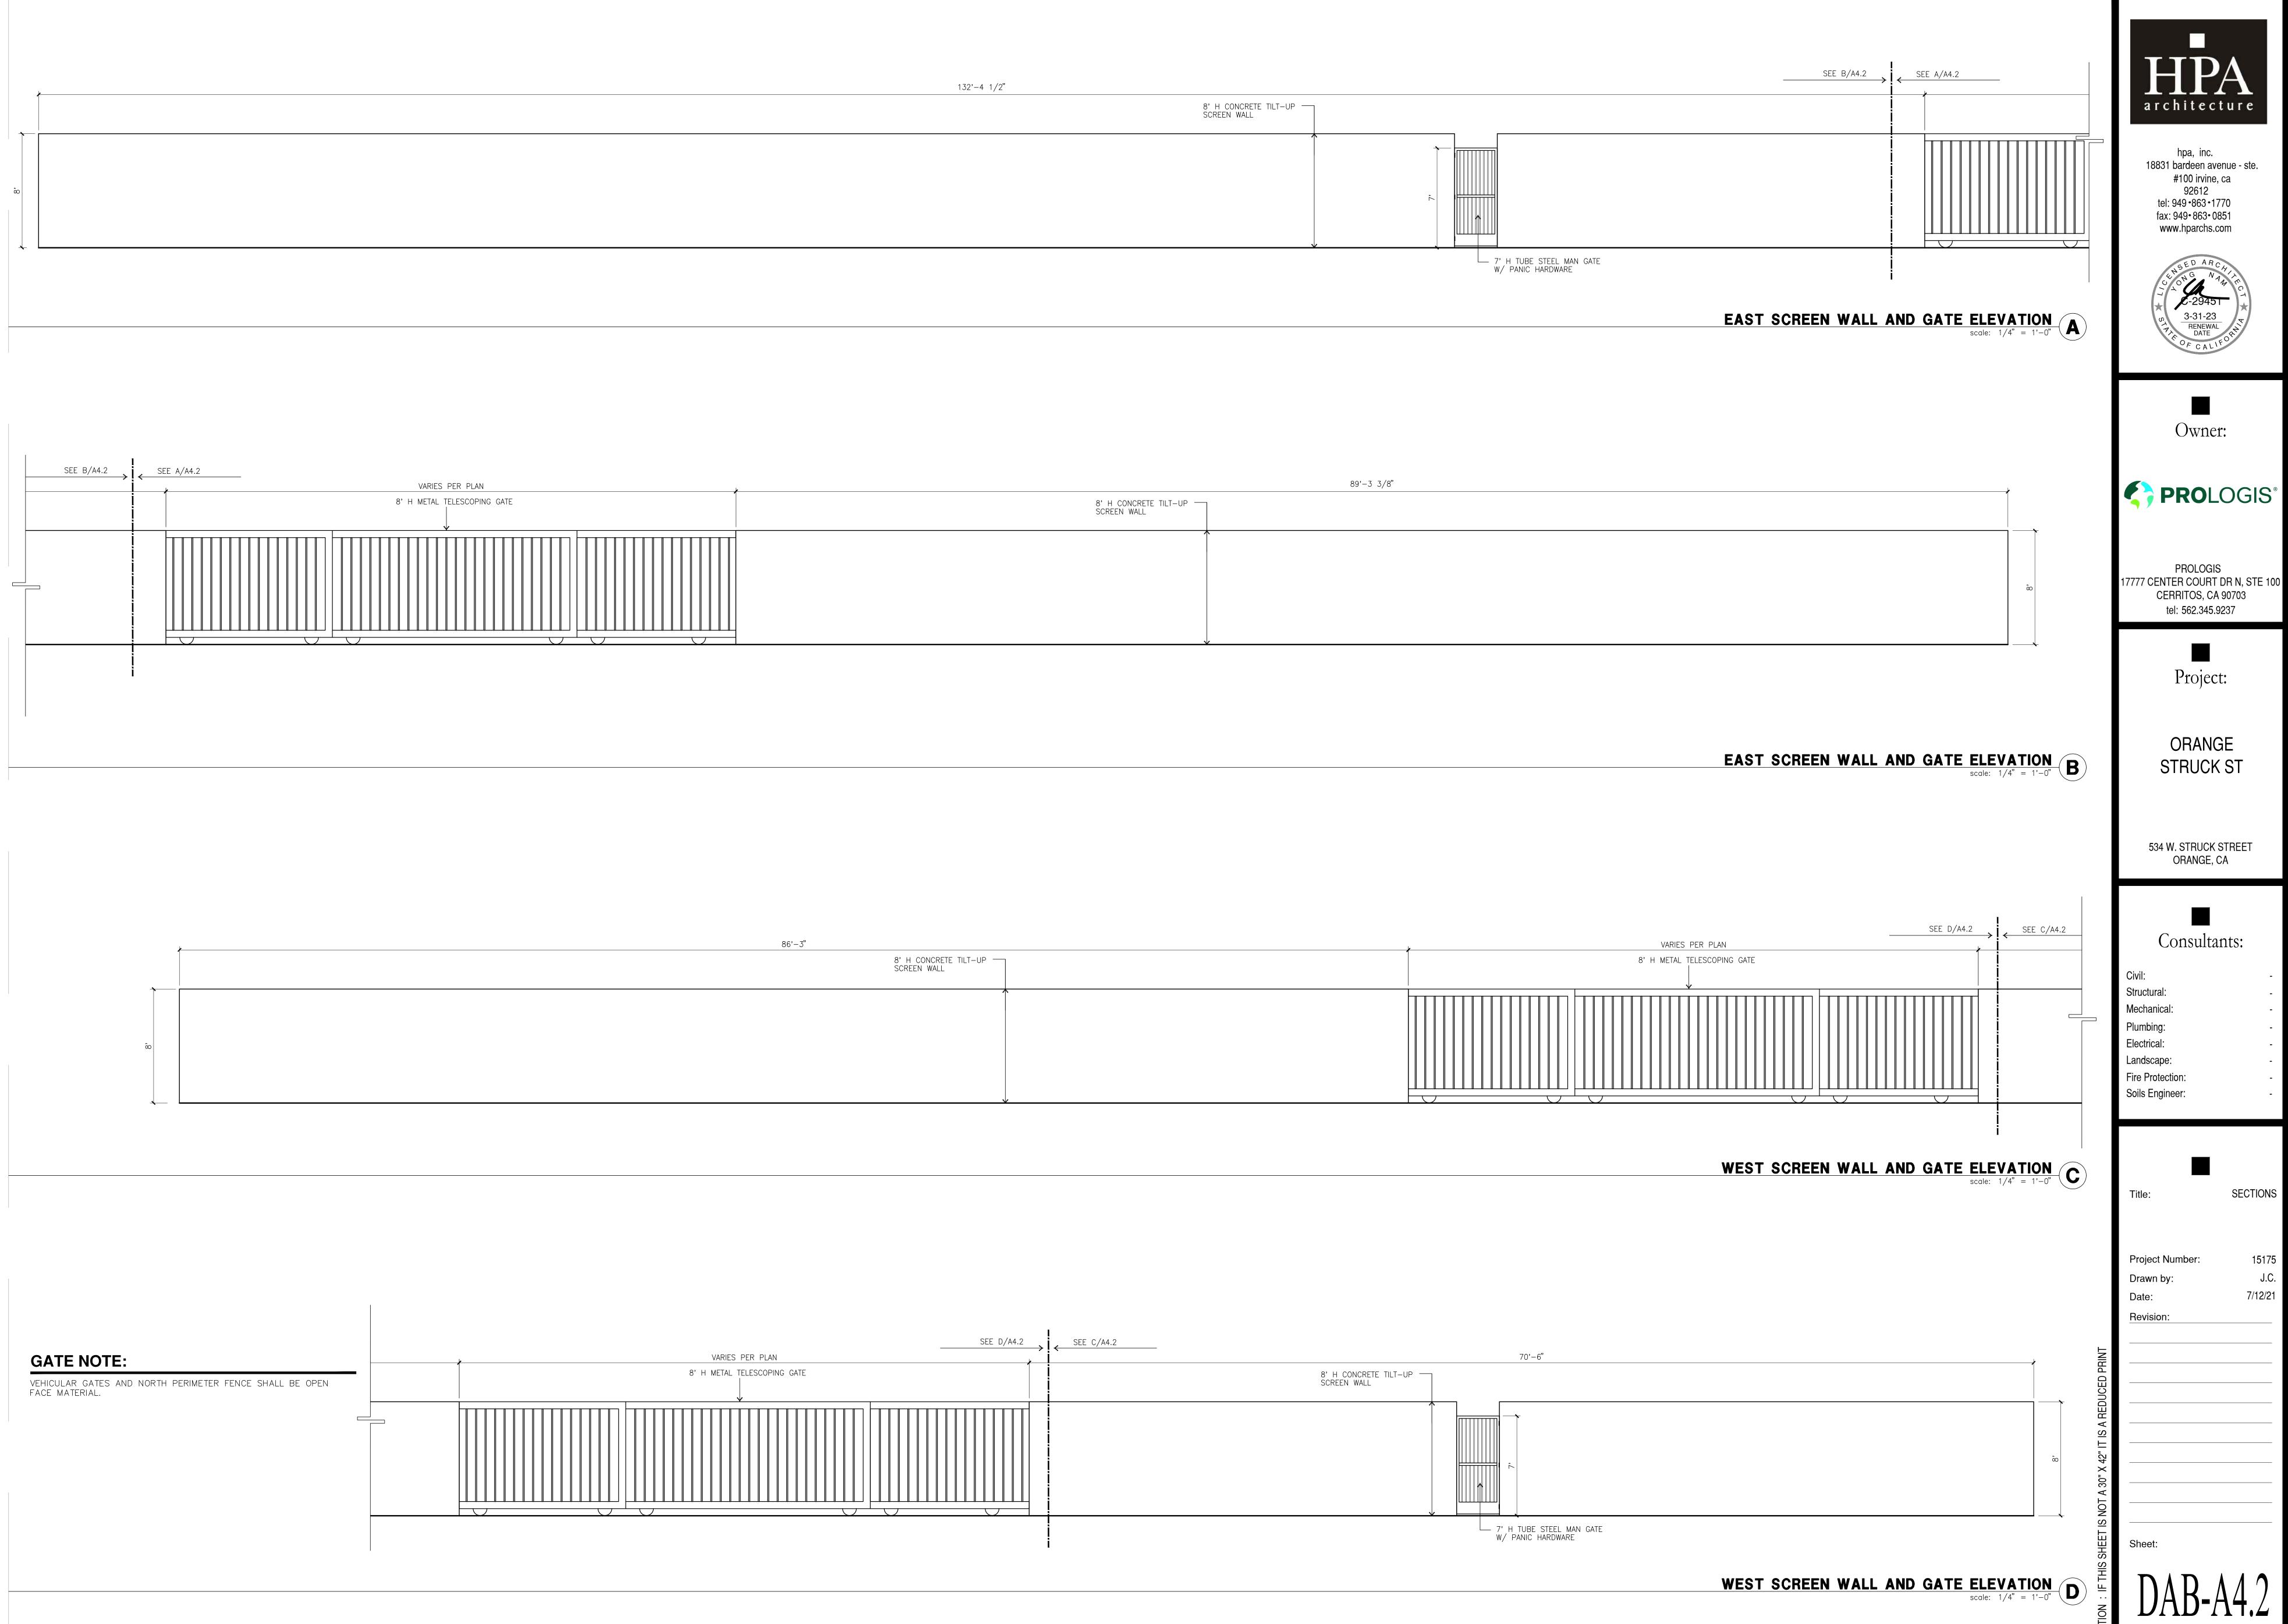

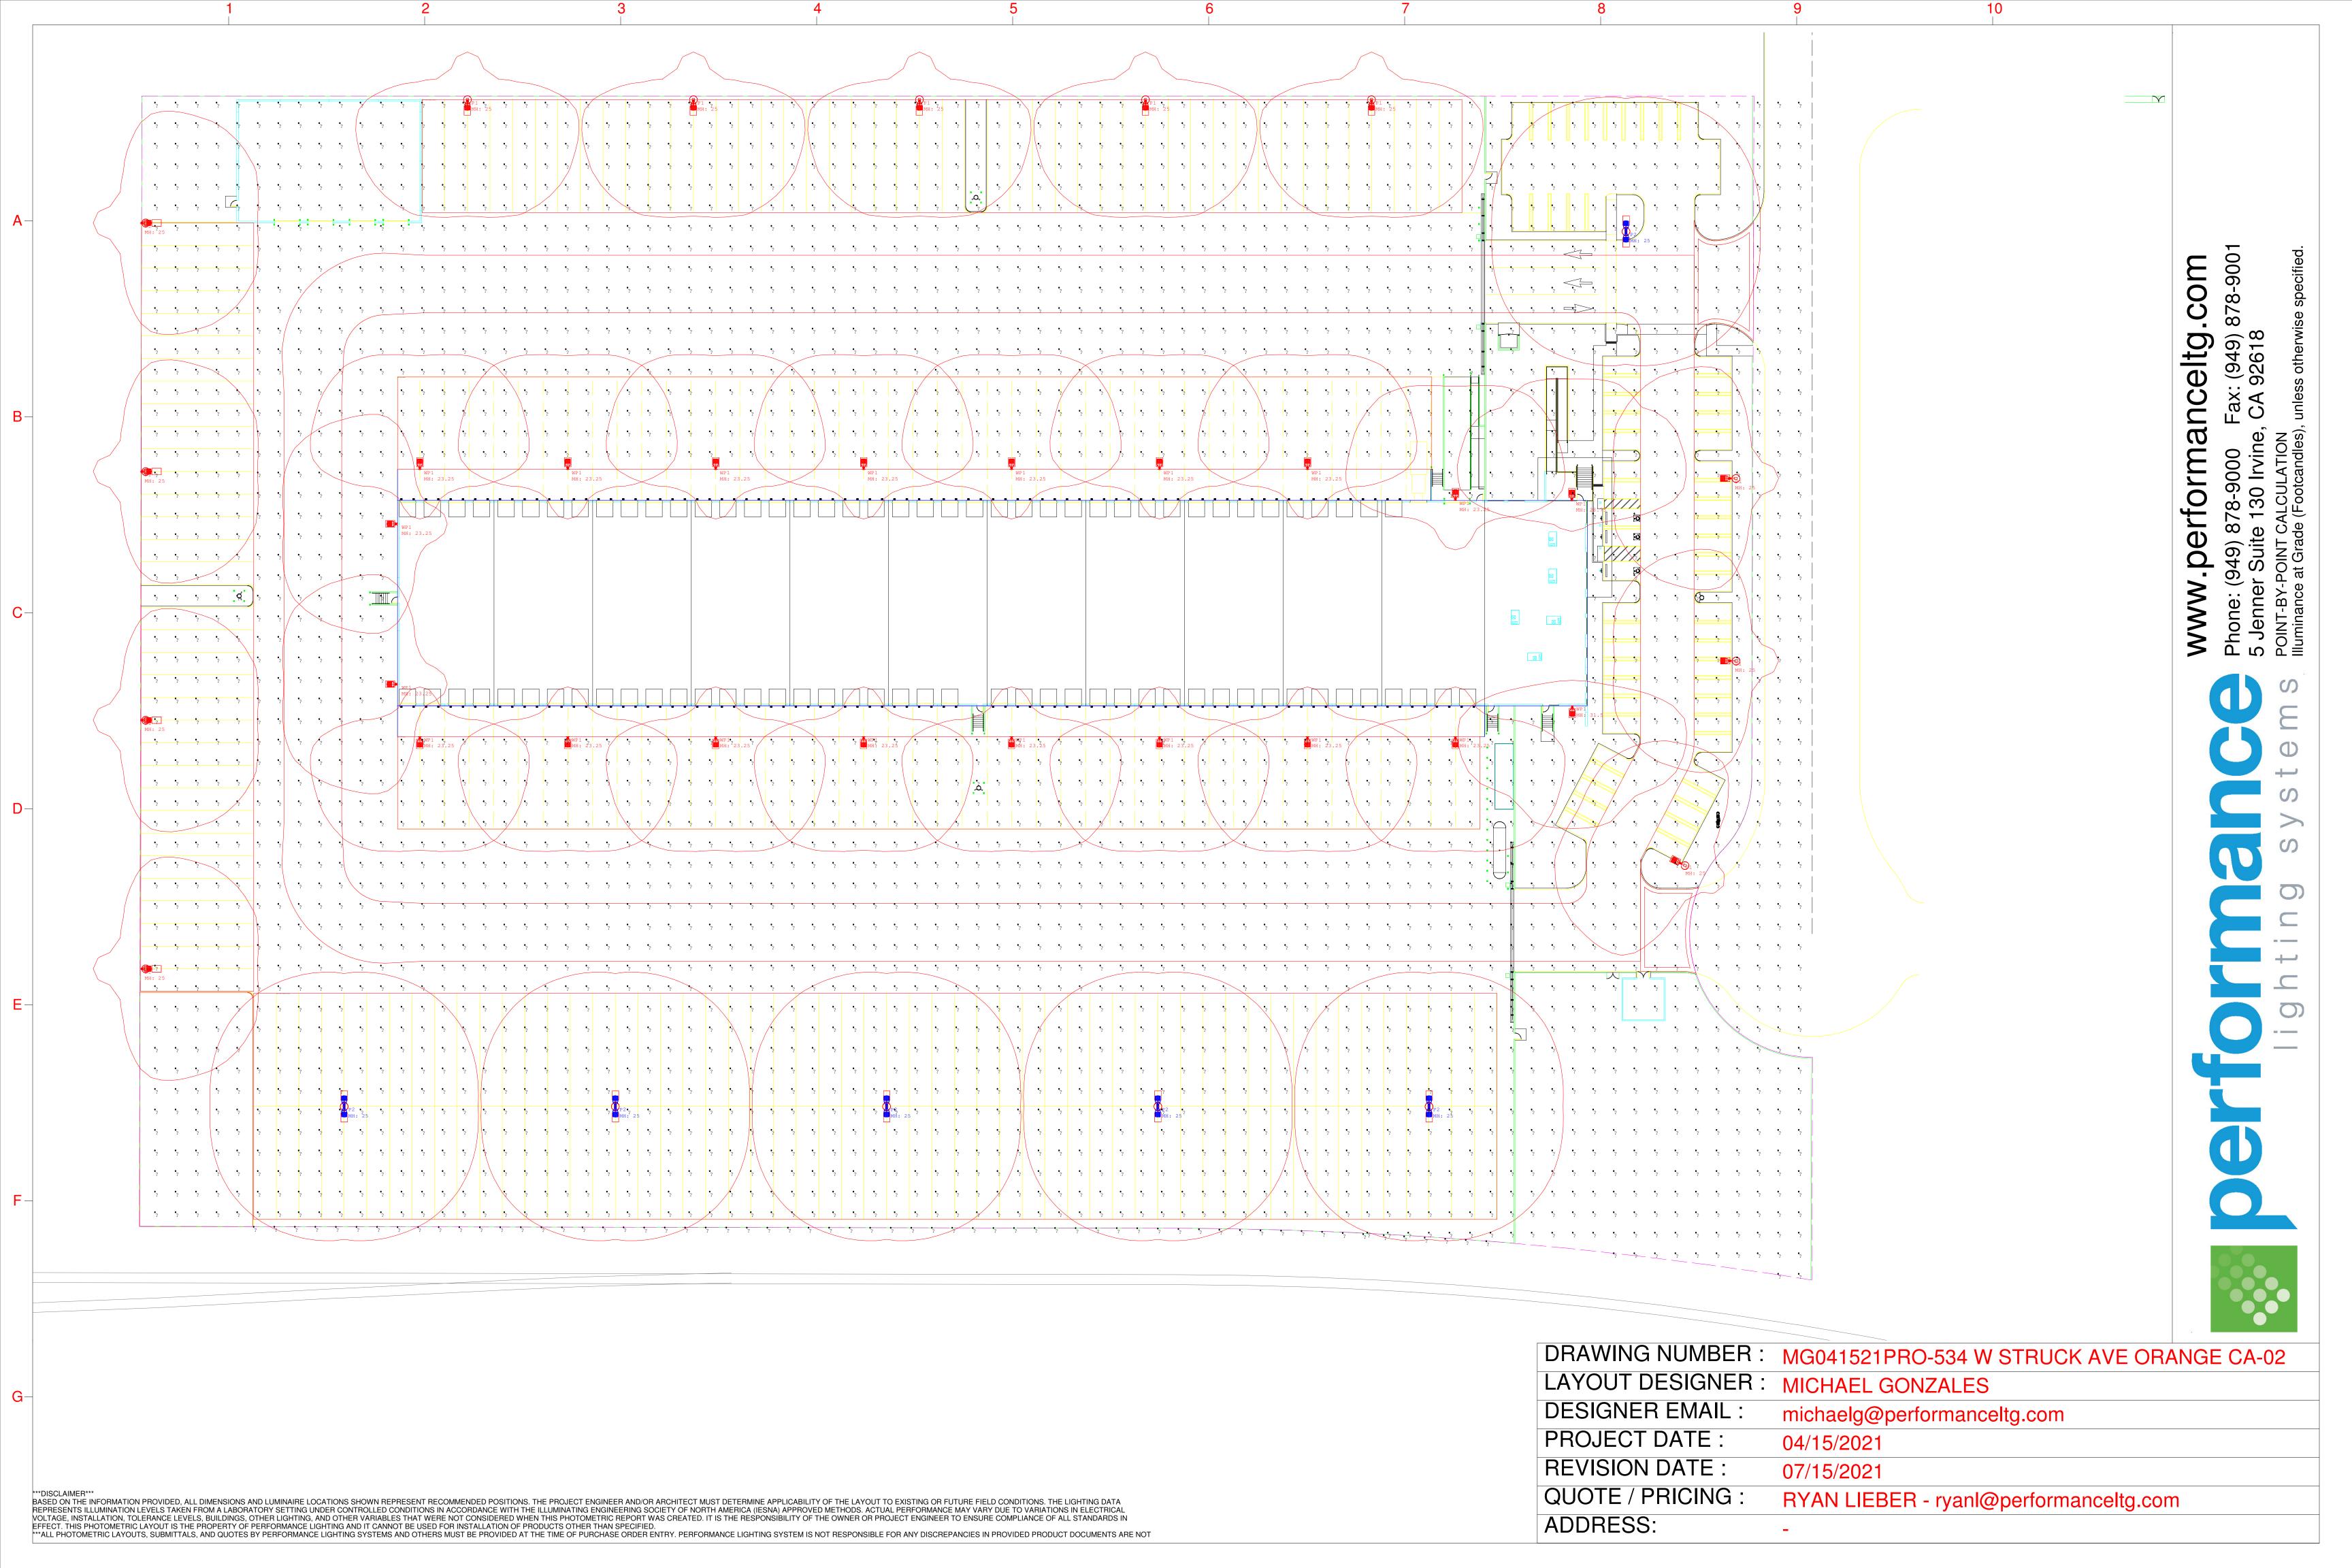

Calculation Summary Max/Min Units Avg CALC AREA N.A. N.A. EAST PROPERTY Illuminance N.A. N.A. EAST DOCK AREA Illuminance N.A. N.A. 0.0 EAST TRUCK Illuminance 0.00 N.A. N.A. 0.0 PARKING STALLS SOUTH TRUCK 0.00 Illuminance N.A. 0.0 PARKING STALLS WEST DOCK AREAllluminance 0.00 N.A. N.A. 0.0 WEST TRUCK N.A. N.A. 0.0 PARKING STALLS

Lumin	aire So	chedule							
Symbo	ol	Qty	Label	Arrangement	Total Lamp Lumens	LLF	Description	BUG Rating	Lum. Watts
•		12	P1	SINGLE	N.A.	0.900	RSX2 LED P2 40K R4	B2-U0-G3	114.071
		6	P2	2 @ 180 DEGREES	N.A.	0.900	RSX2 LED P2 40K R5	B5-U0-G3	114.071
		20	WP1	SINGLE	N.A.	0.900	RSX2 LED P2 40K R4	B2-U0-G3	114.071

Oerfformannamer lighting system

Fax: (949) 878-9001 e, CA 92618

Phone: (949) 878-9000 Factorial Expension Formance at Grade (Footcandles), u

www.performanceltg.com

DRAWING NUMBER: MG041521PRO-534 W STRUCK AVE ORANGE CA-02
LAYOUT DESIGNER: MICHAEL GONZALES
DESIGNER EMAIL: michaelg@performanceltg.com


PROJECT DATE : 04/15/2021
REVISION DATE : 07/15/2021

QUOTE / PRICING: RYAN LIEBER - ryanl@performanceltg.com

ADDRESS:

DISCLAIMER*
BASED ON THE INFORMATION PROVIDED, ALL DIMENSIONS AND LUMINAIRE LOCATIONS SHOWN REPRESENT RECOMMENDED POSITIONS. THE PROJECT ENGINEER AND/OR ARCHITECT MUST DETERMINE APPLICABILITY OF THE LAYOUT TO EXISTING OR FUTURE FIELD CONDITIONS. THE LIGHTING DATA REPRESENTS ILLUMINATION LEVELS TAKEN FROM A LABORATORY SETTING UNDER CONTROLLED CONDITIONS IN ACCORDANCE WITH THE ILLUMINATING ENGINEERING SOCIETY OF NORTH AMERICA (IESNA) APPROVED METHODS. ACTUAL PERFORMANCE MAY VARY DUE TO VARIATIONS IN ELECTRICAL VOLTAGE, INSTALLATION, TOLERANCE LEVELS, BUILDINGS, OTHER LIGHTING, AND OTHER VARIABLES THAT WERE NOT CONSIDERED WHEN THIS PHOTOMETRIC REPORT WAS CREATED. IT IS THE RESPONSIBILITY OF THE OWNER OR PROJECT ENGINEER TO ENSURE COMPLIANCE OF ALL STANDARDS IN EFFECT. THIS PHOTOMETRIC LAYOUT IS THE PROPERTY OF PERFORMANCE LIGHTING AND IT CANNOT BE USED FOR INSTALLATION OF PRODUCTS OTHER THAN SPECIFIED.

****ALL PHOTOMETRIC LAYOUTS, SUBMITTALS, AND QUOTES BY PERFORMANCE LIGHTING SYSTEMS AND OTHERS MUST BE PROVIDED AT THE TIME OF PURCHASE ORDER ENTRY. PERFORMANCE LIGHTING SYSTEM IS NOT RESPONSIBLE FOR ANY DISCREPANCIES IN PROVIDED PRODUCT DOCUMENTS ARE NOT THE TIME OF PURCHASE ORDER ENTRY. PERFORMANCE LIGHTING SYSTEM IS NOT RESPONSIBLE FOR ANY DISCREPANCIES IN PROVIDED PRODUCT DOCUMENTS ARE NOT THE TIME OF PURCHASE ORDER ENTRY.

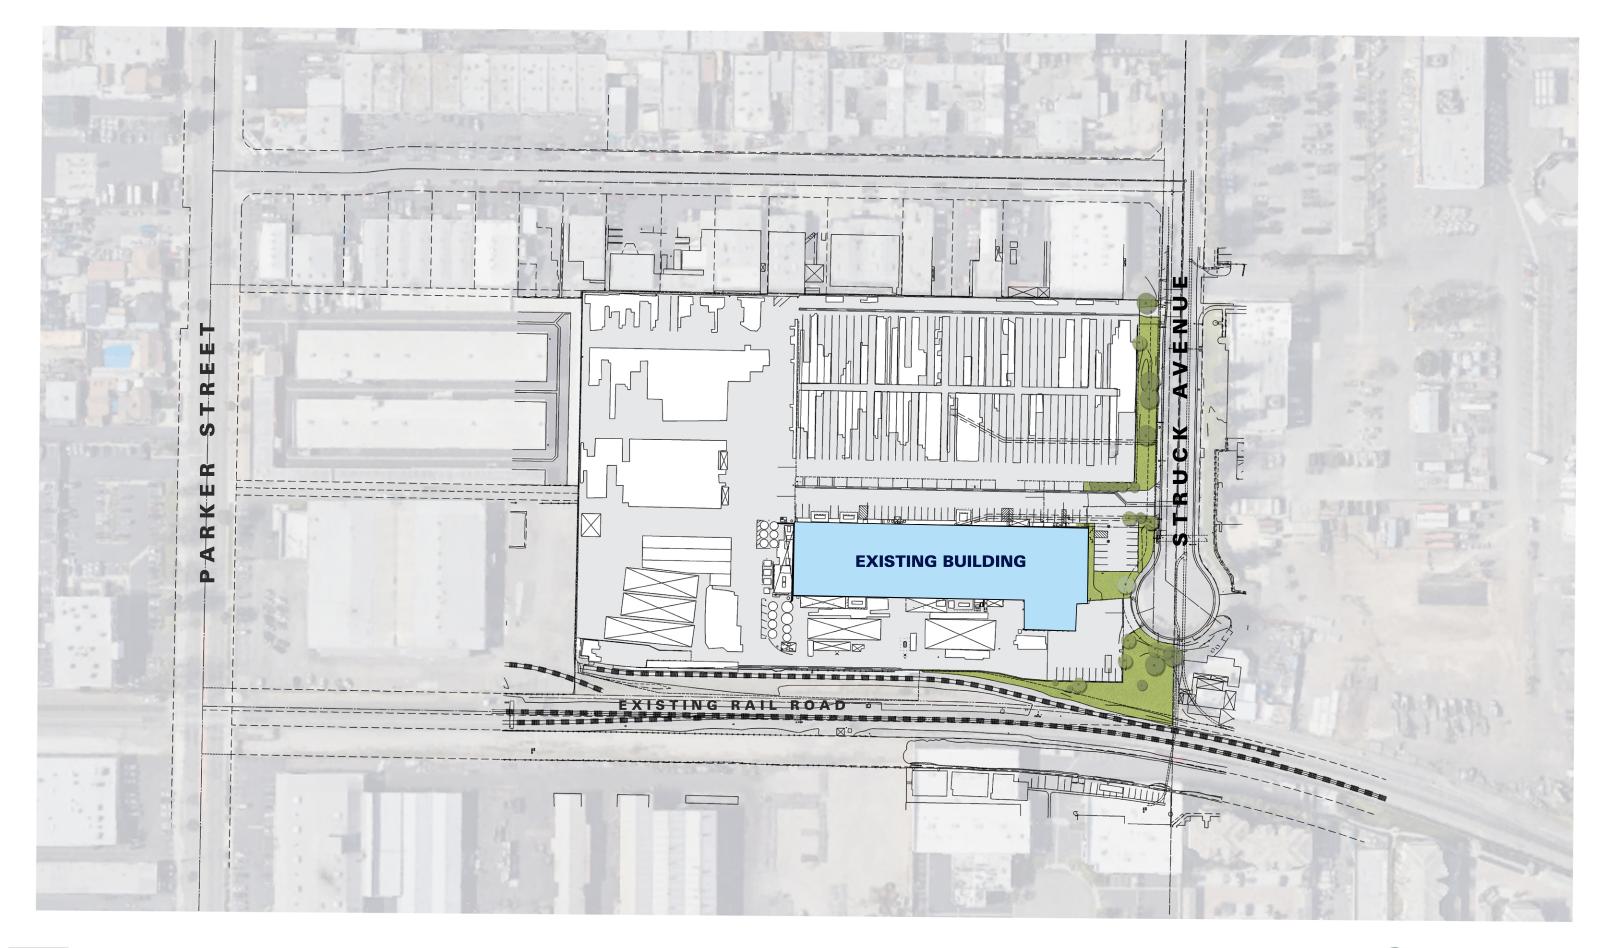













	PLANTING LEGEND
06993	X 30 5 5 5 5 5 5 5 5 5 5 5 5 5 5 5 5 5 5

TREES					
SYMBOL	BOTANICAL/COMMON NAME	SIZE	QTY	WUCOLS	REMARKS
	Cinnamomum camphora Camphor Tree	. 24" Box	9	м	Standard
(Pinus canariensis Canary Island Pine	24" Box	3	L	Standard
•	Podocarpus gracilior Fern Pine	. 24" Box	7	Ĭ.	Standard
	Pyrus kawakami Ornamental Pear	36" Box 24" Box	4 7	L	Standard

YMBOL	BOTANICAL/COMMON NAME	SIZE	WUCOLS	SPACING
	Acca sellowiana Pineapple Guava	5 Gal	L	3' OC
	Bougainvillea spp. Bougainvillea	5 Gal	L	3' OC
	Callistemon 'Little John' Dwarf Bottle Brush	5 Gal	L	3' OC
	Cistus 'Sunset Pink' Sunset Pink Rockrose	5 Gal	L	3' OC
	Elaeagnus pungens Silverberry	5 Gal	L	4' OC
	Ligustrum j. Texanum Texas Privet	5 Gal	М	3' OC
	Rhaphiolepis i. 'Springtime' Indian Hawthorn	5 Gal	L	3' OC
	Rosmarinus o. 'Tuscan Blue' Rosemary	5 Gal	L	3' OC
	Salvia greggii Autumn Sage	5 Gal	L	3' OC
	Salvia leucantha Mexican Sage	5 Gal	L	4' OC
	Westringia fruticosa Coast Rosemary	5 Gal	L	5' OC

SYMBOL	BOTANICAL/COMMON NAME	SIZE	WUCOLS	SPACING
	Agave 'Blue Flame' Blue Flame Agave	5 Gal	L	3' OC
	Agave 'Blue Glow Blue Glow Agave	5 Gal	L	3' OC
	Agave victoria-reginae Agave	5 Gal	L	3' OC
	Aloe striata Coral Aloe	1 Gal	L	2' OC
	Dasylerion wheeleri Desert Spoon	5 Gal	L	4' OC
	Echeveria 'Ruffles' Ruffles Echeveria	5 Gal	L	1' OC
	Hesperaloe parviflora Red Yucca	5 Gal	L	3' OC
	Phormium 'Bronze Baby' New Zealand Flax	5 Gal	L	3' OC

SYMBOL	BOTANICAL/COMMON NAME	SIZE	SPACING	WUCOLS
	Hemerocallis hybridus-Yellow Yellow Day Lily	1 Gal	24" O.C.	М
	Lonicera j. 'Halliana' Hall's Honeysuckle	1 Gal	48" O.C.	L
	Muhlenbergia capillaris Pink Muhly	1 Gal	36" O.C.	L
	Rosa 'Flower Carpet' -Red Red Flower Carpet Rose	1 Gal	30" O.C.	L
	Rosmarinus o. 'Huntington Carpet' Prostrate Rosemary	1 Gal	48" O.C.	L
	Sesleria autumnalis Moor Grass	1 Gal	18" O.C.	м
	Trachelopspermum jasminiodes Star Jasmine	1 Gal	24" O.C.	м

GENERAL NOTES

A LANDSCAPE PLAN FOR ALL PROJECTS THAT INVOLVE NEW CONSTRUCTION OR BUILDING ADDITIONS MUST BE SUBMITTED FOR REVIEW AND APPROVAL (FOR INDIVIDUAL SINGLE-FAMILY RESIDENTIAL PROJECTS, OVER 5,000 SQUARE FEET). IF YOUR PROJECT REQUIRES A WATER QUALITY MANAGEMENT PLAN (WQMP), PLEASE ENSURE YOUR LANDSCAPE ARCHITECT AND CIVIL ENGINEER COORDINATE PLANS. PLEASE CONTACT CITY'S SENIOR LANDSCAPE COORDINATOR IN THE COMMUNITY SERVICES DEPARTMENT AT (714) 532-8484 FOR FURTHER INFORMATION.

LANDSCAPE WAS INCLUDED TO CONTROL ACCESS TO GRAFFITI PRONE WALLS.

GRAFFITI RESISTANT SURFACES AND LANDSCAPING FOR EASY MAINTENANCE.
WATER DIVISION SHALL APPROVE THE TYPE AND LOCATION OF LANDSCAPING AND FIRE SERVICE
(BACKFLOW PREVENTION) DEVICE FOR PROPOSED CITY SERVICES.
PRIOR TO CITY APPROVAL OF LANDSCAPE PLANS, THE APPLICANT SHALL REVIEW THE APPROVED WATER
QUALITY MANAGEMENT PLAN AND ENSURE THE PROPOSED LANDSCAPE PLANS ARE CONSISTENT WITH
THE PROJECT GRADING PLANS. THE PLANS MUST SHOW ANY PROPOSED STORM WATER TREATMENT
BEST MANAGEMENT PRACTICES SUCH AS BIORETENTION PLANTERS, DRYWELLS, PERMEABLE PAVERS,
OR ANY OTHER PROPOSED SURFACE WATER QUALITY BMPS.

ALL ABOVE GROUND EQUIPMENT IS TO BE SUFFICIENTLY SCREENED BY PLANT MATERIAL.

ALL PARKING VISIBLE TO PUBLIC SHALL BE SCREENED WITH 3' HIGH 5 GALLON SHRUBS AT 3' OC.

EXISTING TREES - all existing trees are to be removed due to proposed site conditions

Species Trunk Diameter Condition

1 Eucalyptus citriodora 3.5' Healthy

#	Species	Trunk Diameter	Condition
1	Eucalyptus citriodora	3.5'	Healthy
2	Eucalyptus citriodora	3.5'	Healthy
3	Eucalyptus citriodora	3.5"	Healthy
4	Eucalyptus citriodora	3.5'	Healthy
5	Washingtonia robusta	40 bt	Healthy
6	Avacado	2'	Healthy
7	Cupaniopsis anacardioides	1.5'	Healthy
8	Cupaniopsis anacardioides	1.5'	Healthy
9	Cupaniopsis anacardioides	1.5'	Healthy
10	Cupaniopsis anacardioides	1.5'	Healthy
11	Cupaniopsis anacardioides	1.5'	Healthy
12	Cupaniopsis anacardioides	1.5'	Healthy
13	Cupaniopsis anacardioides	1.5'	Healthy
14	Eriobotrya japonica	1.5'	Healthy
15	Olea europaea	2.5'	Unhealthy
16	Fraxinus spp	1.5'	Healthy
17	Fraxinus spp	1.5'	Healthy
18-23	Archantonhaeniy cunninghamiana	15'	Healthy

25 Archontophoenix cunninghamiana 15'

Healthy Healthy 26 Saygrus romanzoffiana 15' Healthy
27 Eucalyptus citriodora 3.5' Healthy
28 Psidium guajava 10" Healthy
29 Psidium guajava 10" Healthy
39 Fraxinus spp 1.5' Unhealthy



534 W Struck Avenue

20-069 05.21.20 05.05.21 06.22.20 08.05.21 08.20.20 10.11.21 Prologis



HUNTER LANDSCAPE

711 FEE ANA STREET PLACENTIA, CA 92870
714.986.2400 FAX 714.986.2408

TREES



Cinnamomum camphora / Camphor Tree



Pinus canariensis / Canary Island Pine



Podocarpus gracillor / Fern Pine



Pyrus kawkami / Ornamental Pear

SHRUBS



Acca sellowiana / Pineapple Guava



Bougainvillea spp./ Bougainvillea



Cistus 'Sunset Pink' /
Sunset Pin Rock Rose



Elaeagnus punges / Silverberry



Rhaphiolepis i. 'Springtime" / Indian Hawthorne



Rosemary o. 'Tuscan Blue /



Salvia greggii / Autumn Sage



Salvia leucantha / Mexican Bush Sage

ACCENTS



Agave 'Blue Flame' / Blue Flame Agave



Aloe striata / Coral Aloe




Dasylirion wheeleri / Desert Spoon




Echeveria 'Ruffles' / Ruffles Echeveria

GROUNDCOVER

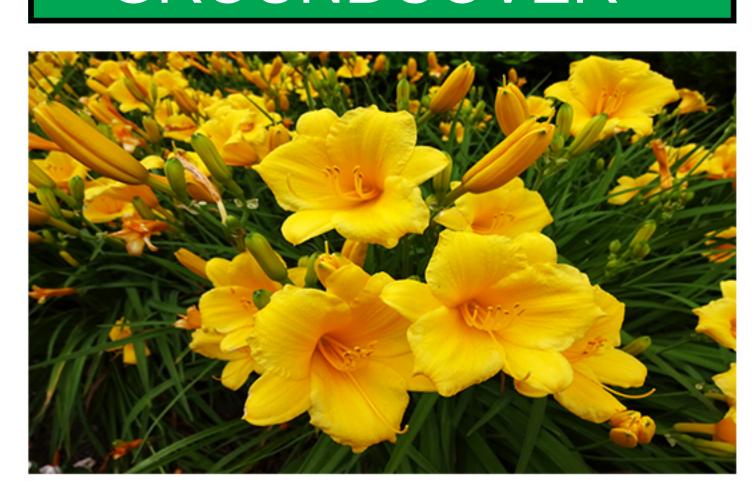

Hemerocallis hybriadus - Yellow / Yellow Day Lily

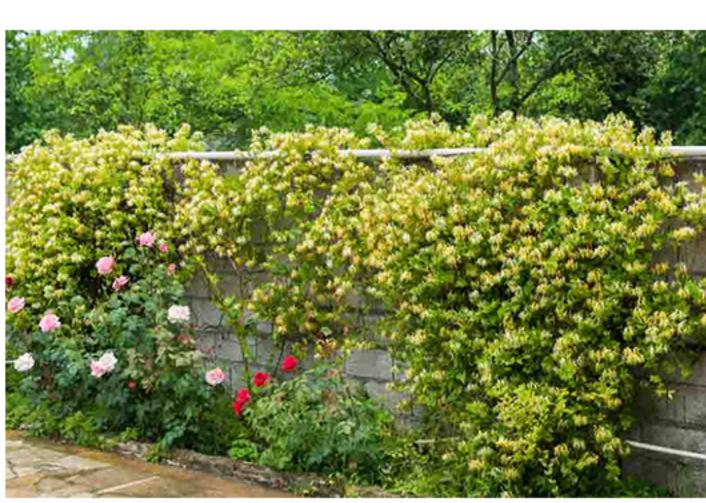

Lonicera j. "halliana /




Muhlenbergia capillaris / Pink Muhly



Rosemarinus o. 'Huntington Carpet' /
Prostrate Rosemary





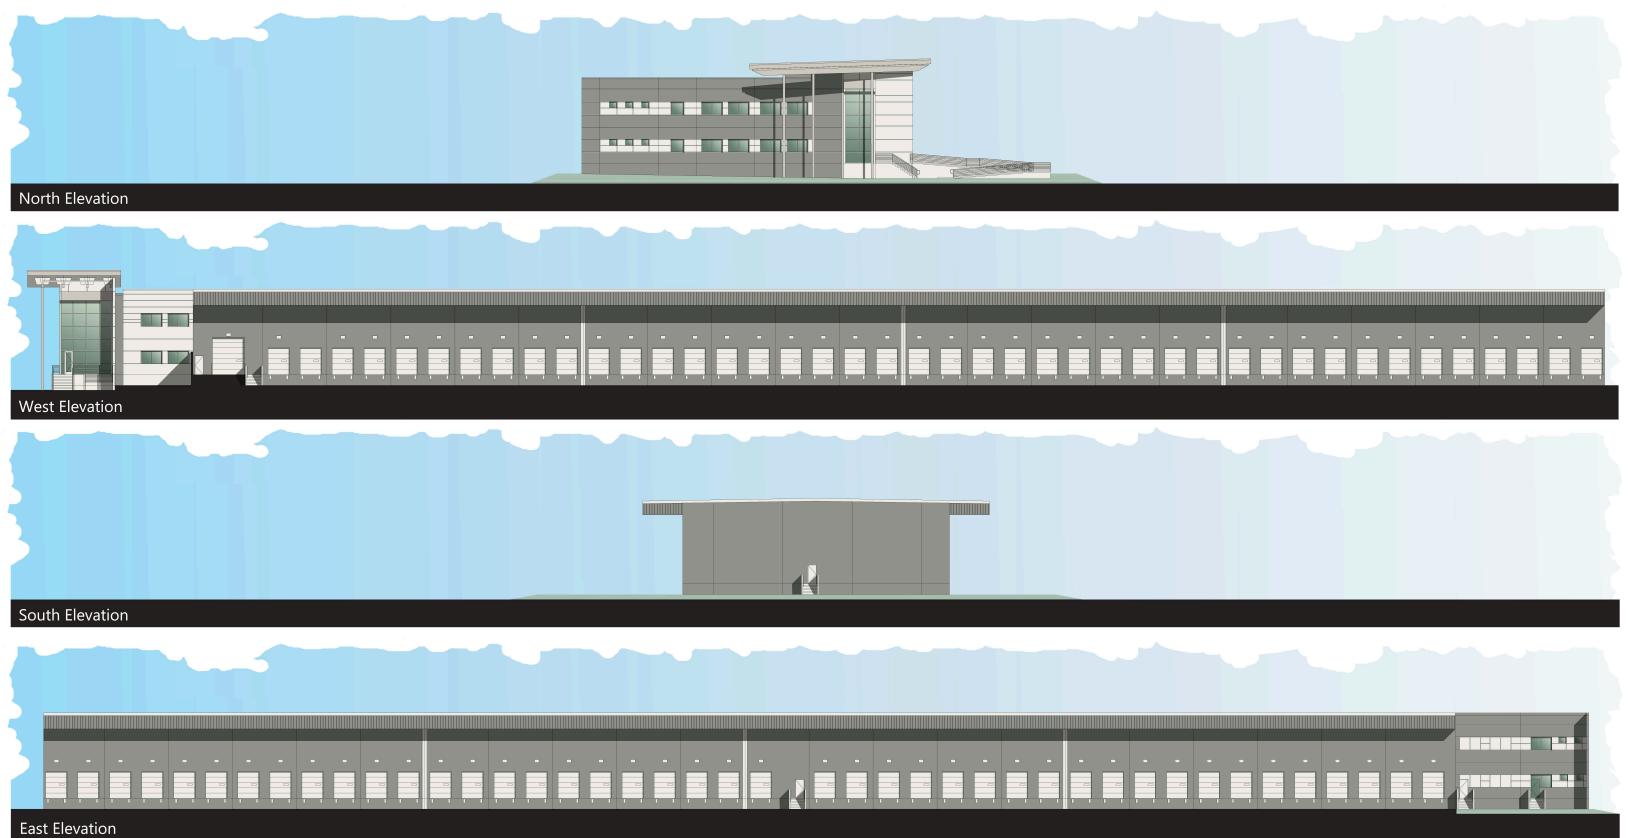




534 W. STRUCK STREET ORANGE, CALIFORNIA





North Elevation

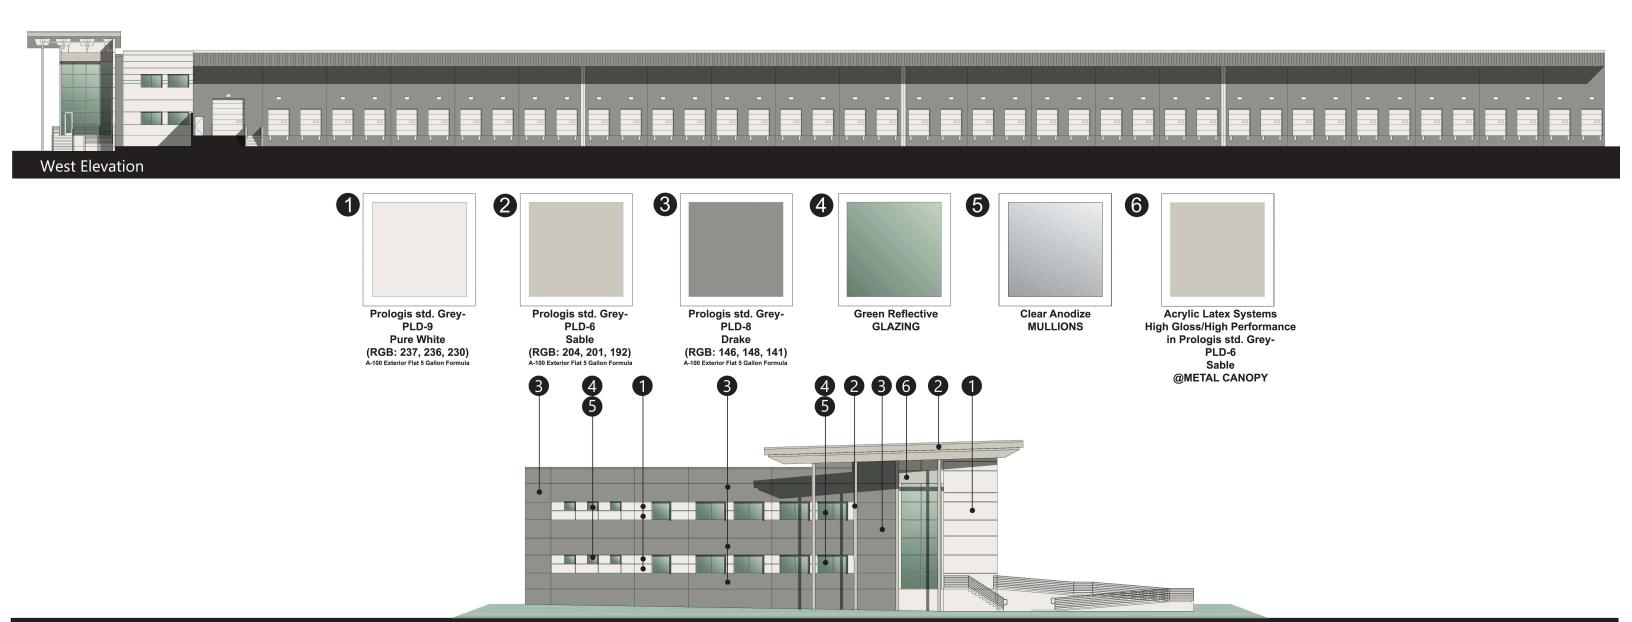


Enlarged View of North Elevation



534 W. STRUCK STREET

ORANGE, CALIFORNIA



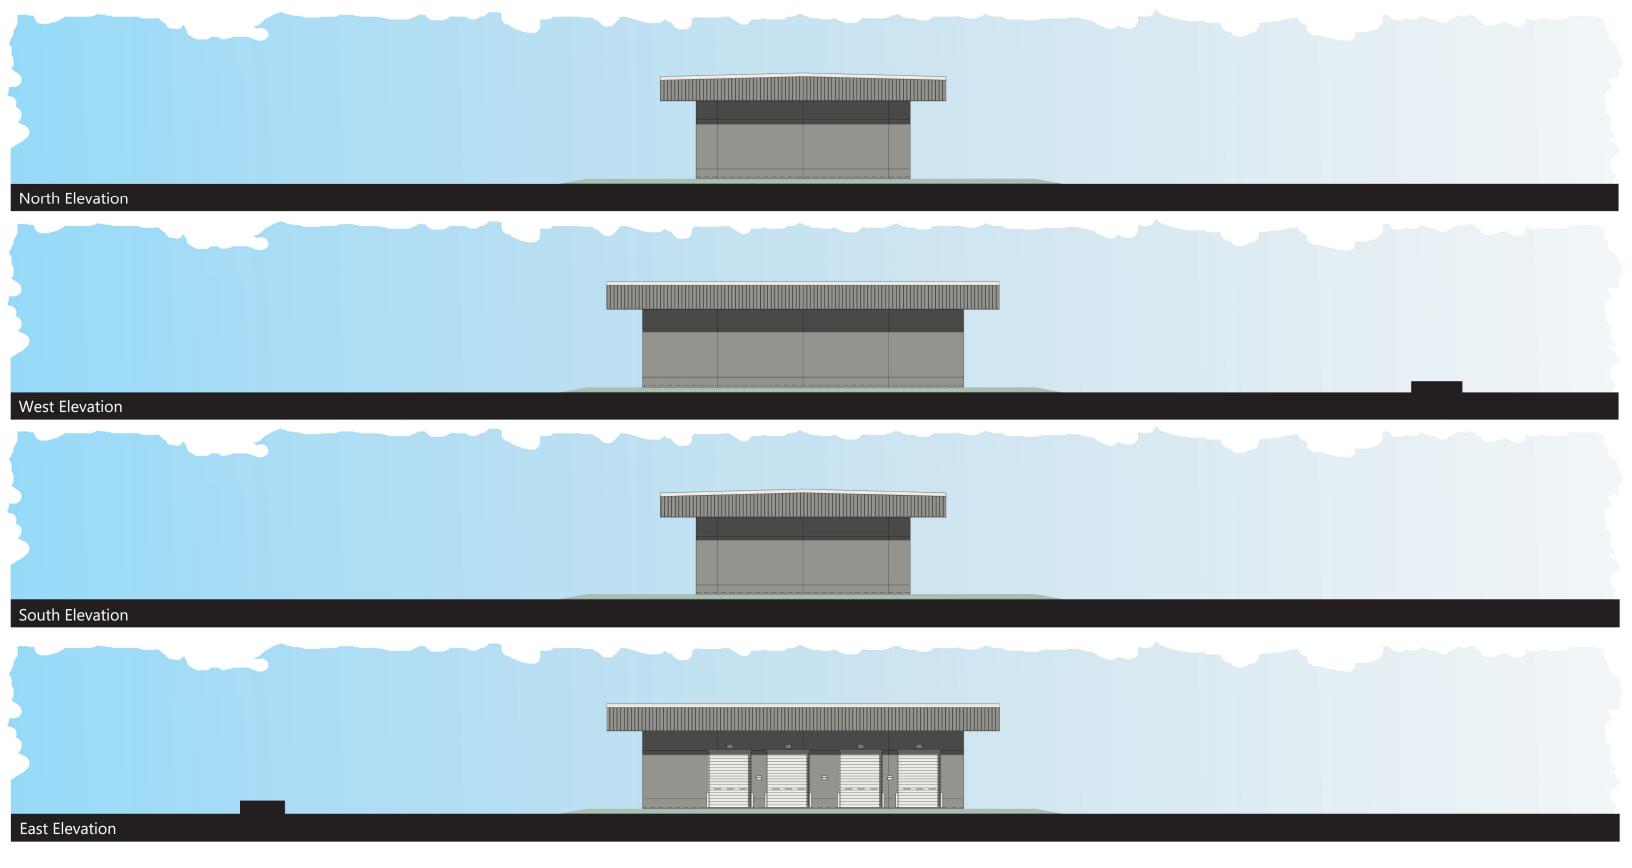



534 W. STRUCK STREET ORANGE, CALIFORNIA


PROLOGIS®



North Elevation



West Elevation

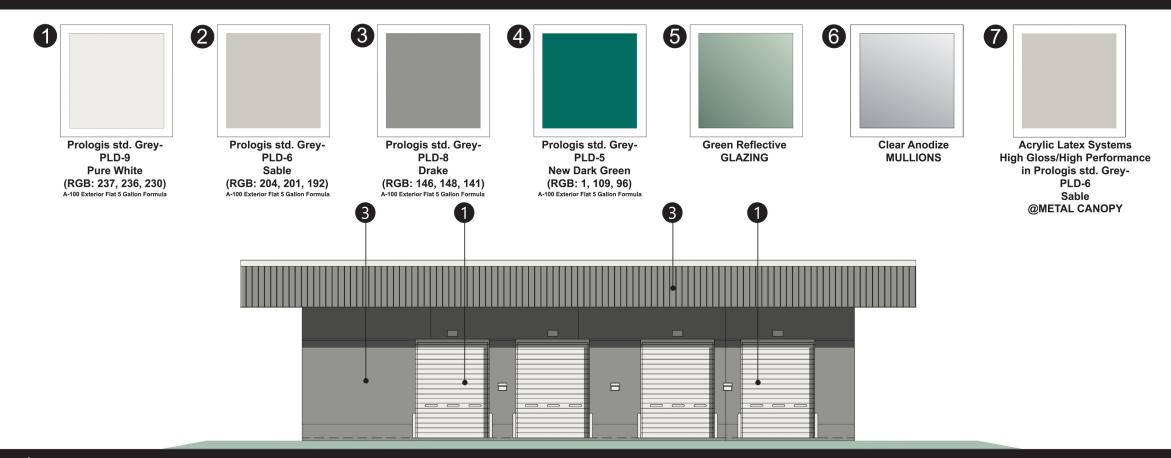

Enlarged View of North Elevation



534 W. STRUCK STREET

ORANGE, CALIFORNIA

